


#### PEDESTRIAN FENCE / BARRIER WITH CHAIN WIRE - OPTION 2

INSTALLED IN GROUND

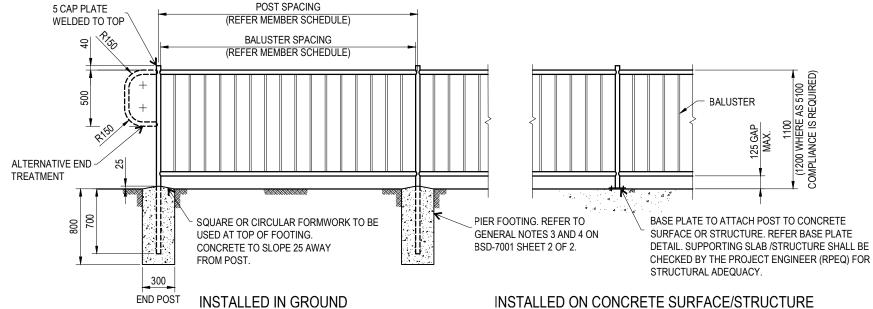

INSTALLED ON CONCRETE SURFACE/STRUCTURE

INSTALLED ON CONCRETE SURFACE/STRUCTURE

PEDESTRIAN FENCE / BARRIER WITH BALUSTERS - OPTION 3

	MEMBER SCHEDULE					
WHERE	THERE IS NO FALL HEIGHT (LEVE	L GROUND)				
ELEMENT	HOT DIPPED GALVANISED	STAINLESS STEEL (GR316)				
POSTS	48.3 x 4.0 CHS (AT 2400 MAX. CTS)	48.3 x 5.08 CHS (AT 2400 MAX. CTS)				
GATE/END POSTS	76.3 x 3.6 CHS	73 x 5.16 CHS				
RAILS	48.3 x 4.0 CHS	48.3 x 3.68 CHS				
BASEPLATE (WHERE REQUIRED)	TYPE 1	TYPE 1				
WHERE FALL HEIGHT IS LESS THAN 1.0m						
ELEMENT	HOT DIPPED GALVANISED	STAINLESS STEEL (GR316)				
POSTS	48.3 x 4.0 CHS (AT 1400 MAX CTS)	48.3 x 5.08 CHS (AT 1400 MAX. CTS)				
RAILS	48.3 x 4.0 CHS	48.3 x 3.68 CHS				
BASEPLATE (WHERE REQUIRED)	TYPE 2	TYPE 2				
WHERE F	ALL HEIGHT IS 1.0m OR GREATER	USE OPTION 3				
ELEMENT	HOT DIPPED GALVANISED	STAINLESS STEEL (GR316)				
POSTS	48.3 x 4.0 CHS (AT 1400 MAX. CTS)	48.3 x 5.08 CHS (AT 1400 MAX. CTS)				
POSTS (WHERE AS5100 COMPLIANCE IS REQUIRED)	76.1 x 4.5 CHS (AT 1400 MAX. CTS)	73 x 5.16 CHS (AT 1400 MAX. CTS)				
GATE/END POSTS	76.1 x 3.6 CHS	73 x 5.16 CHS				
RAILS	48.3 x 4.0 CHS	48.3 x 3.68 CHS				
BALUSTERS	16 DIA. ROD AT 130 MAX. CTRS	16 DIA. ROD AT 130 MAX. CTRS				
BASEPLATE (WHERE REQUIRED)	TYPE 2	TYPE 2				

NOTE: REFER TO GENERAL NOTES 5 & 6 ON BSD-7001 SHEET 2 OF 2 FOR DESIGN ASSUMPTIONS

#### NOTES:

FOR MARINE ENVIRONMENTS OR ENVIRONMENTS WITH A CORROSIVITY CATEGORY OF C4 OR GREATER (IN ACCORDANCE WITH AS2312), ONE OF THE FOLLOWING PROTECTIVE TREATMENT OPTIONS TO BE ADOPTED:

OPTION A: ALL STEEL MEMBERS, FASTENERS, INCLUDING BOLTS, NUTS AND PLATES SHALL BE GRADE 316 STAINLESS STEEL (REFER STAINLESS STEEL NOTES - SHEET 2). ANCHOR BOLTS TO BE GRADE 316 STAINLESS STEEL A4-50 MINIMUM. WIRE MESH AND WIRE TIES SHALL BE GRADE 316 STAINLESS STEEL.

OPTION B: ALL STEEL MEMBERS TO BE HOT DIPPED GALVANISED IN ACCORDANCE WITH AS/NZS4680 AND PAINTED WITH A SYSTEM SUITABLE FOR A CORROSION CATEGORY C4 ENVIRONMENT. THE GALVANISED STEEL SHALL BE PREPARED AND COATED IN ACCORDANCE WITH AS/NZS2312.2 AND GALVANISERS ASSOCIATION OF AUSTRALIA GUIDELINES. MINIMUM SYSTEM REQUIREMENTS AS FOLLOWS (AFTER HOT DIP GALVANISING)

- CLEAN AND DEGREASE
- 2 COATS OF HIGH BUILD OR 2 PACK EPOXY (MINIMUM DFT 250µm)
- 2 COATS OF 2 PACK POLYURETHANE OR 2 PACK ACRYLIC (MINIMUM DFT 50µm/COAT)

PAINT COLOUR TO BE IN ACCORDANCE WITH BCC CORPORATE COLOUR PALATTE (REFER BSD-1003).

WIRE MESH AND WIRE TIES TO BE HOT DIPPED GALVANISED AND PVC COATED

ANCHOR BOLTS TO BE GRADE 316 STAINLESS STEEL A4-50 MINIMUM. STAINLESS STEEL ANCHOR BOLTS TO BE ISOLATED FROM GALVANISED/PAINTED STEEL BASE PLATE USING NYLON WASHERS.

- CHAIN WIRE TO BE 900 HIGH x 3.15 THICK x 50 MESH TO AS2423. CHAIN WIRE TO BE FIXED USING 1.6 THICK WIRE, TIED TO POSTS AT 2 LOCATIONS AND CONTINUOUSLY LACED TO RAILS. MESH AND TIES TO BE HOT DIPPED GALVANISED. FOR MARINE ENVIRONMENTS, PROTECTIVE TREATMENT FOR MESH TO BE AS PER EITHER OPTION A OR B IN NOTE 1.
- 3. REFER DRAWING BSD-7001 SHEET 2 OF 2 FOR NOTES AND BASEPLATE DETAILS

THE PURPOSE OF THIS STANDARD DRAWING IS TO PROVIDE TYPICAL DETAILS THAT SUPPORT THE DESIRED OUTCOMES OF THE BRISBANE CITY PLAN 2014 AND ASSOCIATED PLANNING SCHEME POLICIES. THE FITNESS FOR PURPOSE OF THIS STANDARD DRAWING FOR A SPECIFIC PROJECT SHOULD BE ASSESSED AND ACCEPTED BY AN APPROPRIATELY QUALIFIED DESIGNER AND/OR REGISTERED PROFESSIONAL ENGINEER OF QUEENSLAND (RPEQ)



#### BRISBANE CITY COUNCIL STANDARD DRAWING

PEDESTRIAN FENCE/BARRIER **GALVANISED TUBULAR HANDRAIL** SHEET 1 OF 2

	, ,
Ì	PUBLISH DATE
	JUN 2023
	SCALE
	NOT TO SCALE
	DRAWING NUMBER
	BSD-7001
	ORIGINAL SIZE REVISION

#### **GENERAL NOTES:**


- ALL WORKMANSHIP AND MATERIAL SHALL COMPLY WITH THE APPROPRIATE AUSTRALIAN STANDARDS AND WORKPLACE HEALTH AND SAFETY REGULATIONS THAT ARE CURRENT AT THE TIME OF CONSTRUCTION.
- 2. VERIFY LOCATIONS OF ALL SERVICES PRIOR TO COMMENCING WORK.
- 3. FOOTINGS HAVE BEEN DESIGNED ON THE ASSUMPTION THAT THE MINIMUM ALLOWABLE BEARING CAPACITY OF SOIL IS 100kPa AND MINIMUM CU = 50kPa FOR COHESIVE SOILS.THE ACTUAL SOIL CONDITION IS TO BE ASSESSED BY A GEOTECHNICAL ENGINEER (RPEQ) AND IF FOUND TO BE OF WEAKER STRENGTH OR OF DIFFERENT TYPE OF SOIL TO THE ONE ASSUMED, A STRUCTURAL ENGINEER (RPEQ) IS TO BE CONSULTED FOR A PROJECT SPECIFIC FOOTING DESIGN.
- CONCRETE PIER FOOTINGS TO BE GRADE N25.
- 5. PEDESTRIAN FENCE / BARRIER IN THIS BSD ARE TO BE USED ONLY IN SITUATIONS CLEAR OF LONGITUDINAL VEHICLE IMPACT SO AS TO AVOID A POTENTIAL SPEARING HAZARD TO MOTORISTS. THESE HANDRAILS ARE NOT TO BE USED IN SITUATIONS WHERE MOTOR VEHICLES / CROWDS / PEOPLE UNDER PANIC CONDITIONS REQUIRE RESTRAINT.
- PEDESTRIAN FENCE / BARRIER IN THIS BSD HAVE NOT BEEN DESIGNED FOR FLOOD LOADING. IF 6. FENCE / BARRIER ARE REQUIRED TO RESIST FLOOD LOADING, THE PROJECT ENGINEER (RPEQ) WILL NEED TO ASSESS THE SUITABILITY OF THE BSD FOR USE AND MODIFY THE DESIGN AS REQUIRED
- NECESSARY DDA COMPLIANCE REQUIREMENTS IN ACCORDANCE WITH AS 1428.1 ARE TO BE ASSESSED AND COMPLIED BY THE PROJECT ENGINEER (RPEQ) FOR EACH PROJECT.
- POSTS TO BE VERTICAL
- 9. ALL HORIZONTAL RAILS TO BE ROLLED TO MATCH SHAPE OF PATH/WALL IF RADIUS IS LESS THAN
- 10. MINIMUM LENGTH OF RAILS TO BE 2 SPANS LONG TO MINIMISE NEED FOR JOINTS AT EVERY POST.
- EXPANSION JOINTS SHALL BE PROVIDED IF THE LENGTH OF HANDRAIL EXCEEDS 20m
- DIMENSIONS IN MILLIMETRES (U.N.O.).


#### STEELWORK NOTES:

- S1. CIRCULAR HOLLOW STEEL SECTIONS SHALL BE IN ACCORDANCE WITH AS1163 GRADE C250LO. STEEL PLATES SHALL BE IN ACCORDANCE WITH AS/NZS3678 GRADE 250.
- ALL STEELWORK TO BE HOT DIPPED GALVANISED IN ACCORDANCE WITH AS/NZS4680 U.N.O.
- S3.. ALL WELDS TO BE 4mm THICK C.F.W. (CONTINUOUS FILLET WELDS) TO AS1554.1 U.N.O. WELDS TO BE MADE USING ELECTRODES WITH A NOMINAL TENSILE STRENGTH OF 490MPa (OR BETTER) TO AS/NZS1554
- STEELWORK MAY BE POWDER COATED (AFTER GALVANISING). HOT DIPPED GALVANISED SURFACES THAT ARE TO BE POWDER COATED ARE TO BE CLEANED AND PREPARED IN ACCORDANCE WITH AS4506 AND THE POWDER COATING MANUFACTURER'S WRITTEN INSTRUCTIONS, ENSURING EXCESSIVE REMOVAL OR DAMAGE OF THE ZINC COATING DOES NOT OCCUR. POWDER COATING PROCEDURES TO BE IN ACCORDANCE WITH AS4506 AND THE POWDER COATING MANUFACTURER'S SPECIFICATIONS. POWDER COATING SHALL BE SUFFICIENT FOR A MINIMUM C3 EXPOSURE CLASSIFICATION AND HAVE A MINIMUM MAINTENANCE FREE LIFE OF 25 YEARS. COLOUR OF POWDER COATING TO MATCH COLOUR COORDINATION IN THE AREA (IN ACCORDANCE WITH BCC CORPORATE COLOUR PALETTE - REFER BSD-1003)
- S5. PROTECTIVE COATING TO BE APPLIED AFTER ALL FABRICATION COMPLETED. NO WELDING ETC. TO BE CARRIED OUT DURING OR AFTER APPLICATION OF COATING SYSTEM.
- S6. ANY POST GALVANISING DAMAGE TO BE MADE GOOD WITH AN ORGANIC EPOXY ZINC RICH PAINT CONFORMING TO AS/NZS3750.9. PAINT TO BE APPLIED TO THE REPAIR AREAS IN TWO COATS. EACH COAT SHALL HAVE A MINIMUM DRY FILM THICKNESS OF 50 MICRON AND SHALL BE APPLIED AS PER THE MANUFACTURER'S SPECIFICATIONS


#### STAINLESS STEEL NOTES:

- STAINLESS STEEL MATERIAL SHALL NOT BE STORED WITH CARBON STEEL.
- SS2. TOOLS USED FOR CARBON STEEL SHALL NOT BE USED TO FABRICATE OR ASSEMBLE STAINLESS STEEL COMPONENTS.
- SS3 THE STAINLESS STEEL SHALL BE WRAPPED OR OTHERWISE PROTECTED DURING TRANSPORT TO AVOID CONTAMINATION BY FERROUS PRODUCTS.
- WELDS SHALL BE 4mm C.F.W. (U.N.O.) CATEGORY 2B IN ACCORDANCE WITH AS1554.6 GRADE 316 SS4 ELECTRODES SHALL BE USED FOR GRADE 316L.
- LIMIT THE INPUT OF HEAT INTO THE WELD. THE WELD SHALL NOT BE PREHEATED, POST-HEATED OR STRESS RELIEVED.
- SS6 SURFACE FINISH OF WELDS SHALL BE GRADE 1. POLISHED USING 320 GRIT OR FINER. SILICONE CARBIDE ABRASIVES WITH LUBRICATION. AFTER POLISHING, WELDS SHALL BE PASSIVATED USING NITRIC ACID IN ACCORDANCE WITH ASTM A380.
- ALL STAINLESS STEEL COMPONENTS SHALL HAVE A RA<0.5µm AND PASSIVATED USING NITRIC ACID IN ACCORDANCE WITH ASTM A380.

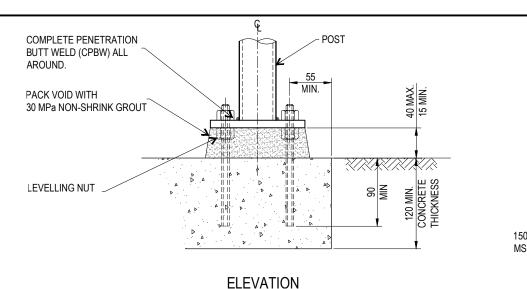

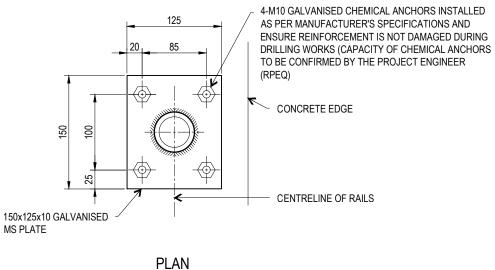


WHERE THERE IS NO FALL HEIGHT (LEVEL GROUND)

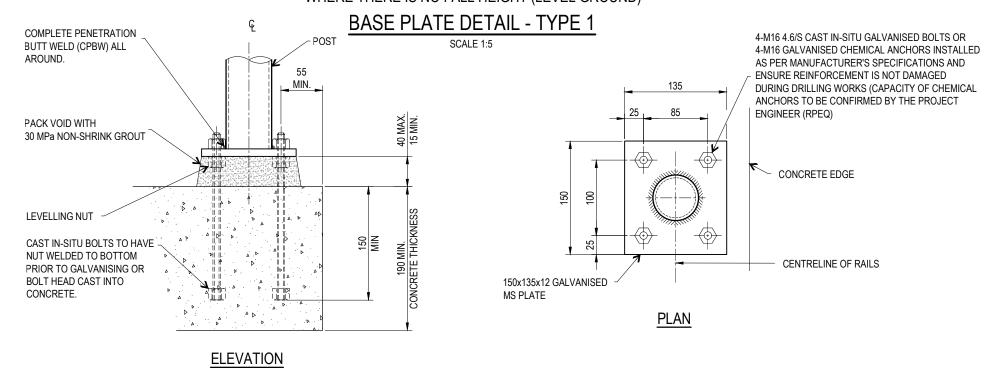

WHERE THERE IS ANY FALL HEIGHT

BASE PLATE DETAIL - TYPE 2 SCALE 1:5

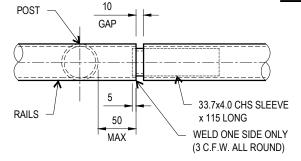

SPACING OF EJ'S TO SUIT FABRICATION, TRANSPORTATION AND INSTALLATION REQUIREMENTS. MINIMUM LENGTH OF CONTINUOUS RAIL TO BE TWO SPANS.

#### RAIL EXPANSION JOINT AT 20.0m MAX. CTS

(FOR CONTINUOUS HANDRAIL LENGTHS)

SCALE: 1:5

THE PURPOSE OF THIS STANDARD DRAWING IS TO PROVIDE TYPICAL DETAILS THAT SUPPORT THE DESIRED OUTCOMES OF THE BRISBANE CITY PLAN 2014 AND ASSOCIATED PLANNING SCHEME POLICIES. THE FITNESS FOR PURPOSE OF THIS STANDARD DRAWING FOR A SPECIFIC PROJECT SHOULD BE ASSESSED AND ACCEPTED BY AN APPROPRIATELY QUALIFIED DESIGNER AND/OR REGISTERED PROFESSIONAL ENGINEER OF QUEENSLAND (RPEQ).




#### BRISBANE CITY COUNCIL STANDARD DRAWING

PEDESTRIAN FENCE/BARRIER GALVANISED TUBULAR HANDRAIL SHEET 2 OF 2

JUN 2023 NOT TO SCALE DRAWING NUMBER BSD-7001 ORIGINAL SIZE

D

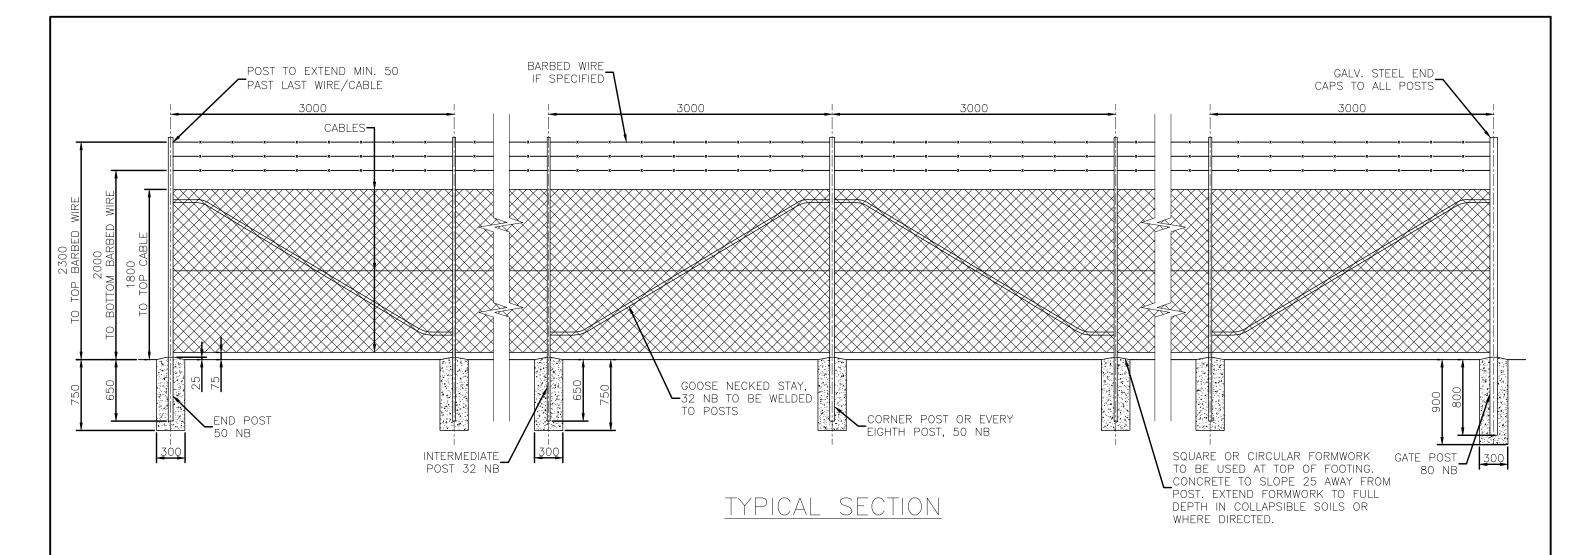

#### NOTES:

- 1. THIS STANDARD IS NOT INTENDED FOR USE IN A MARINE ENVIRONMENT. THE MARINE ENVIRONMENT COULD EXTEND UP TO 1 km FROM THE THE FORESHORE.
- 2. WHERE STANDARD IS REQUIRED FOR USE WITH MARINE ENVIRONMENT, THE FOLLOWING PROTECTION TREATMENT IS REQUIRED:
  - STEELWORK HOT DIP GALVANISING: 85 MICRONS (600g/m²) MIN;
  - SWEEP ABRASIVE BLAST;
  - STEELWORK FIRST COAT: EPOXY PRIMER 75 MICRONS MIN;
  - STEELWORK SECOND COAT: TWO PACK ACRYLIC OR POLYURETHANE GLOSS 75 MICRONS MIN;
  - WIRE MESH AND WIRE TIES TO BE PVC COATED.
- 3. PAINT SYSTEMS TO BE IN ACCORDANCE WITH AS 2312 AND DESIGNATED HDG600P6 AND HDG600P
- 4. FENCE COLOURS (WHERE REQUIRED) TO CONFORM TO BRISBANE CITY COUNCIL CORPORATE COLOUR PALETTE. REFER BSD-1003.
- 5. GATE POSTS TO BE 80 NB (88.9 OD, 5.0 THICK) GALVANISED STEEL TUBE TO AS/NZS1163.
- 6. CORNER, END AND EVERY EIGHTH POST TO BE 50 NB (60.3 OD, 3.6 THICK) GALVANISED STEEL TUBE TO AS/NZS1163.
- 7. INTERMEDIATE POSTS AND GOOSE NECKED STAYS TO BE 32 NB (42.4 OD, 3.2 THICK) GALVANISED STEEL TUBE TO AS/NZS1163.
- 8. STANDARD COUPLINGS (DOWN-EE FITTINGS, MONOWILLS, SENTAUR JOINTS, KEE-KLAMP, SWAGED JOINTS OR SIMILAR) MAY BE USED AS AN ALTERNATIVE TO WELDS

- 9. GALVANISED STEEL END CAPS TO BE PROVIDED TO ALL POSTS.
- 10. CORNER POSTS TO BE ADOPTED WHERE THE CHANGE IN ANGLE IN HORIZONTAL ALIGNMENT EXCEEDS 20 DEGREES.
- 11. ALL WELDS TO BE 5 THICK C.F.W. (CONTINUOUS FILLET WELDS) TO AS1554.1 WITH COLD GALVANISING TREATMENT TO COMPLETED WELDS.
- 12. 1800 CHAIN WIRE TO BE 3.15 THICK x 50 MESH TO AS2423. BARBED WIRE TO AS2423.
- 13. STAYS TO BE PROVIDED AT END POSTS, GATE POSTS, CORNER POSTS AND EVERY EIGHTH POST.
- 14. POSTS ARE TO BE VERTICAL AND EXTEND 150 MIN. BEYOND TOP WIRE.
- 15. CABLES TO BE FORMED FROM TWO 3.15 DIAMETER WIRES TWISTED TOGETHER.
- 16. ALL POSTS, STAYS AND CABLES ARE TO BE GALVANISED. HOT DIP GALVANISING: FERROUS OPEN SECTIONS TO AS4791, FERROUS HOLLOW SECTIONS TO AS4792.
- 17. ALL CONCRETE TO BE GRADE N25.
- 18. CHAIN WIRE TO BE FIXED USING 1.6 WIRE TIES AS FOLLOWS:
  - INTERMEDIATE POSTS AT 3 LOCATIONS;
  - END POSTS AT 3 LOCATIONS;
  - HORIZONTAL CABLE AT 375 CENTRES TO TOP CABLE;
  - HORIZONTAL CABLE AT 600 CENTRES TO MIDDLE CABLE;
  - HORIZONTAL CABLE AT 450 CENTRES TO BOTTOM CABLE.
- 19. DIMENSIONS IN MILLIMETRES (UNO).

ISSUE	AMENDMENT	DRAWN DATE	CHK'D DATE	APPR'D DATE	PRINCIPAL ASSET OFFICER ROADS & DRAINAGE	ASSOCIATED PLANS	SUPERSEDES UMS-243			BRISBANECITY	CH.
А	Drawing Converted from UMS Series April 2014	APR '14	APR '14	APR '14	DATED 27/6/01	DRAWING FILENAME	BSD-7003 (B) Fence - 1.8	Bm high chain	wire.dwg		
В	Drawing Title Amended	FEB'16			DESIGN APPROVED B. HANSEN SIGNATURE ON ORIGINAL		M. STEEK	DATE	MATUI		1.8
					STRATEGIC ASSET MANAGEMENT	CHECKED	M. STEER	DATE	MAY '01	<mark>©</mark> ⊋⁄⊊ ∣	l F
					DATED 29/6/01 R.P.E.Q: 3852 ASSET ENGINEERING MANAGER	DRAWN	CITY DESIGN	DATE	APRIL '01	Ē	
					DRAWING AUTHORISED FOR PUBLICATION  B. BALL SIGNATURE ON ORIGINAL	DESIGN	Std Dwgs Group	DATE	APRIL '01	<u> </u>	BRISBANE CI

#### BRISBANE CITY COUNCIL STANDARD DRAWING

FENCE
1.8m HIGH
CHAINWIRE

SCALE NOT TO SCALE


DWG NO.

BSD-7003

ORIGINAL SIZE

A 3

B

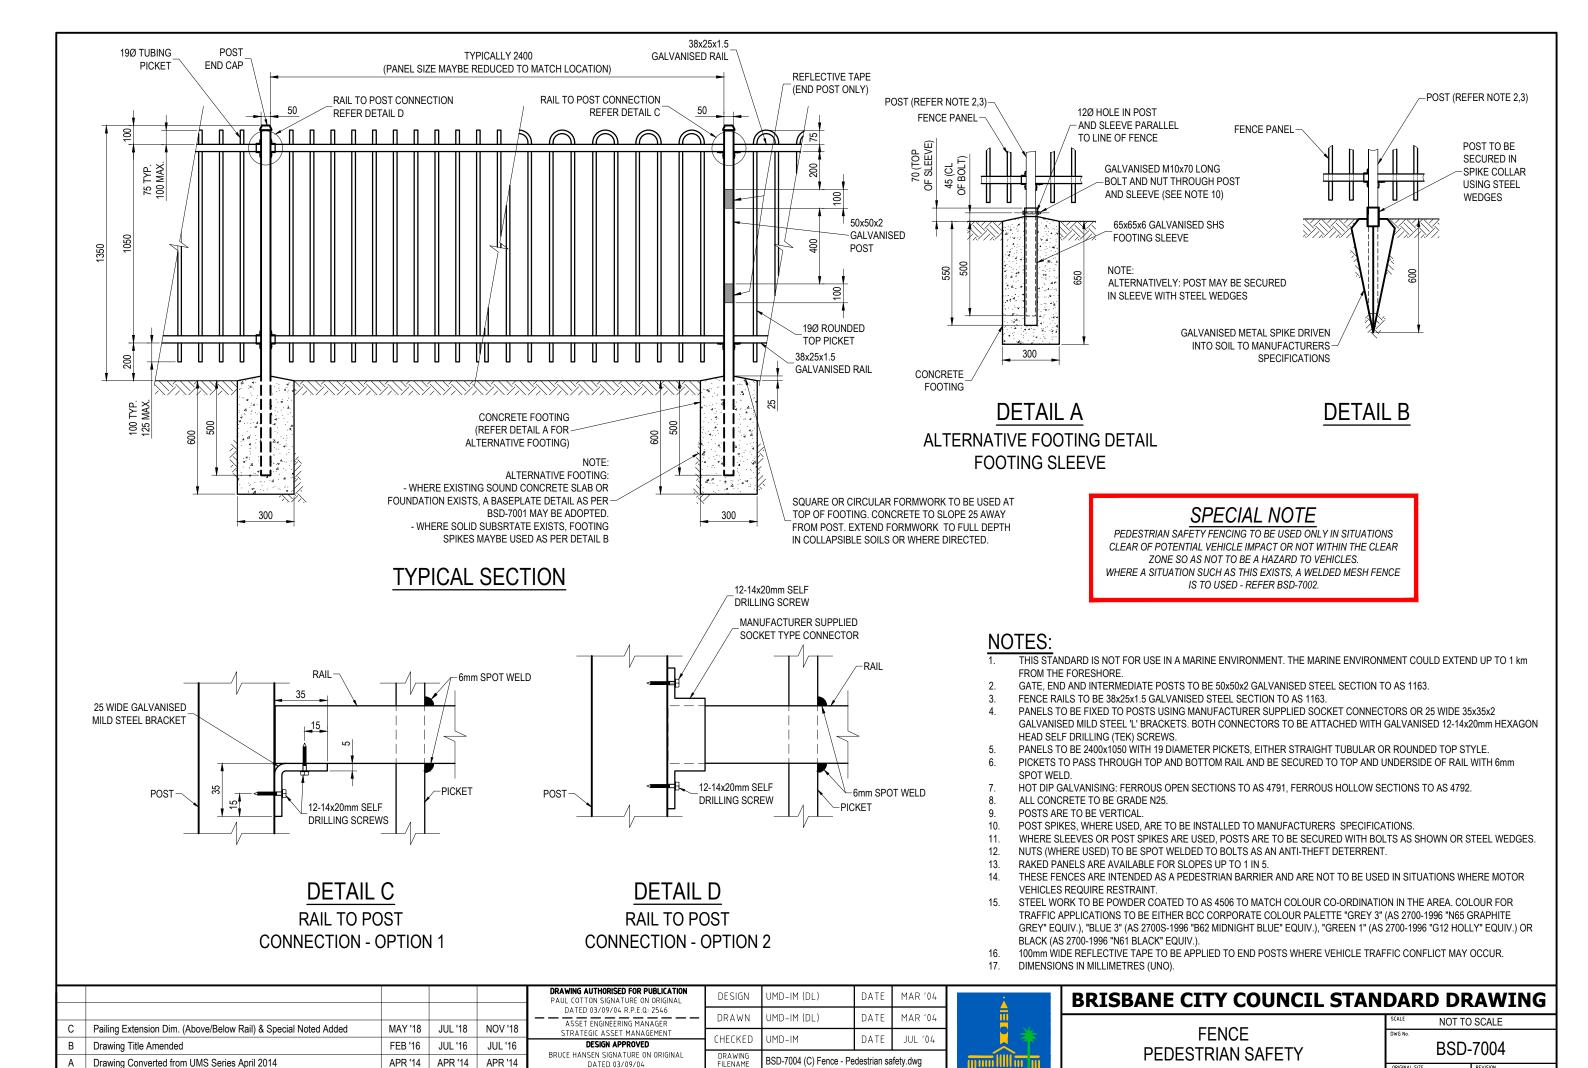

SUPERSEDES UMS-247

RISBANE CITY


C

PRINCIPAL ENGINEER STRATEGIC INFRASTRUCTURE MANAGEMENT

APPR'D


ISSUE

AMENDMENT

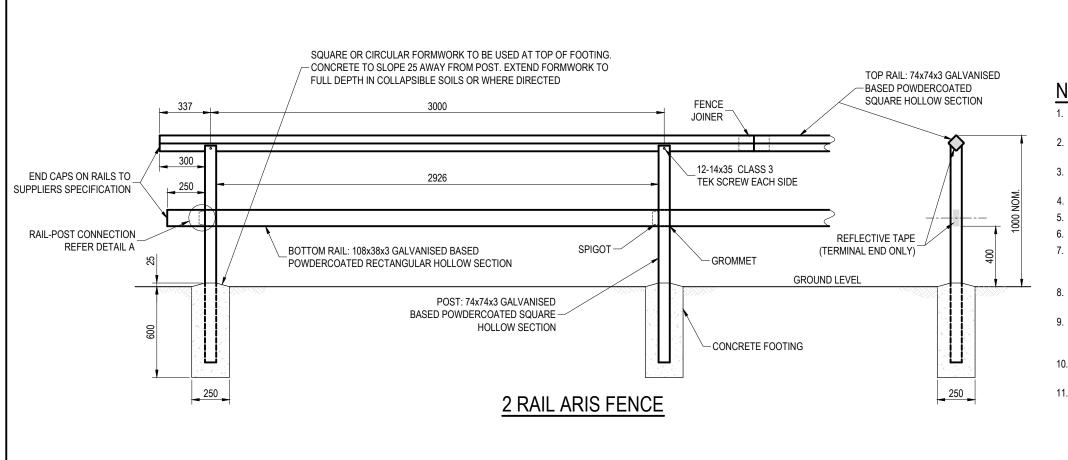

#### NOTES:

- THIS STANDARD IS NOT FOR USE IN A MARINE ENVIRONMENT. THE MARINE ENVIRONMENT COULD EXTEND UP TO 1km FROM THE FORESHORE.
- POSTS AND ARIS FENCE TOP RAIL TO BE 74x74 GALVANISED BASED COLORBOND SQUARE HOLLOW SECTION.
- 8. ALL OTHER RAILS TO BE 108x38 GALVANISED BASED COLORBOND RECTANGULAR HOLLOW SECTION.
- 4. JOINTS AND CONNECTIONS TO MANUFACTURERS SPECIFICATIONS.
- POSTS TO BE VERTICAL.
- ALL CONCRETE TO BE GRADE N25.
- 7. TWO RAIL POST AND RAIL FENCES GENERALLY USED AS PEDESTRIAN PROTECTION ABOVE CULVERTS AND EMBANKMENTS AND AS VEHICLE DELINEATION ALONG SPLIT-LEVEL STREETS
- 8. THESE FENCES ARE INTENDED AS A PEDESTRIAN BARRIER AND DELINEATION DEVICE AND ARE NOT TO BE USED IN SITUATIONS WHERE VEHICLES REQUIRE RESTRAINT.
- STEEL POSTS AND RAILS MAYBE POWDER COATED TO AS 4506 TO MATCH COLOUR CO-ORDINATION IN THE AREA (IN ACCORDANCE WITH BCC CORPORATE COLOUR PALETTE, REFER BSD-1003).
- 100mm WIDE REFLECTIVE TAPE TO BE APPLIED TO END POSTS AND/OR TERMINAL END OF RAILS WHERE VEHICLE TRAFFIC CONFLICT MAY OCCUR.
- 11. DIMENSIONS IN MILLIMETRES (U.N.O.).

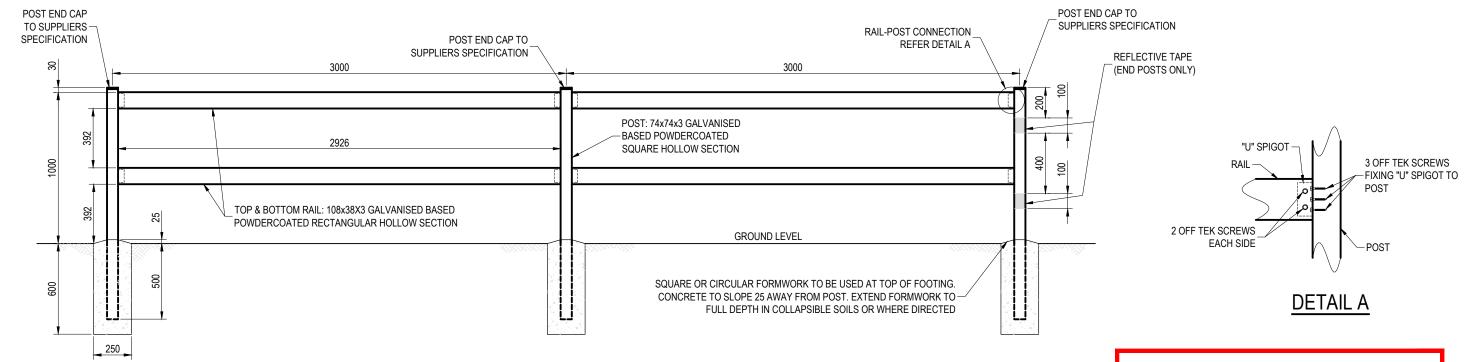

#### SPECIAL NOTE

TWO RAIL POST AND RAIL FENCING TO BE USED ONLY IN SITUATIONS
CLEAR OF POTENTIAL VEHICLE IMPACT OR NOT WITHIN THE CLEAR
ZONE SO AS NOT TO BE A HAZARD TO VEHICLES.
WHERE A SITUATION SUCH AS THIS EXISTS, A WELDED MESH FENCE
IS TO USED - REFER BSD-7002.

ISSUE	AMENDMENT	DRAWN DATE	CHK'D DATE	APPR'D DATE	PRINCIPAL ENGINEER STRATEGIC INFRASTRUCTURE MANAGEMENT	ASSOCIATED PLANS	SUPERSEDES UMS-248		
Α	Drawing Converted from UMS Series April 2014	APR '14	APR '14	APR '14	BRUCE HANSEN SIGNATURE ON ORIGINAL DATED MAR '05	DRAWING FILENAME	BSD-7005 (C) Fence - Two rail, ste	el hollow sectio	n post and rail.dwg
В	Drawing Title Amended	FEB '16	JUL '16	JUL '16	DESIGN APPROVED		ВН	DATE	MAR '05
С	Special Notes Added	JAN '19	APR '19	APR '19	ASSET ENGINEERING MANAGER STRATEGIC ASSET MANAGEMENT				
					DATED 03/03/05 R.P.E.Q: 2546	DRAWN	UMD-IM (DL)	DATE	FEB '04
					<b>DRAWING AUTHORISED FOR PUBLICATION</b> PAUL COTTON SIGNATURE ON ORIGINAL	DESIGN	UMD-IM (DL)	DATE	FEB '04


2 RAIL FENCE



#### **BRISBANE CITY COUNCIL STANDARD DRAWING**

FENCE - TWO RAIL, STEEL HOLLOW SECTION POST AND RAIL FENCE

•	DAILD DIV	MILLIO
	SCALE NOT TO	SCALE
	DWG No.	
	BSD-	7005
	ORIGINAL SIZE	REVISION
	Α3	С

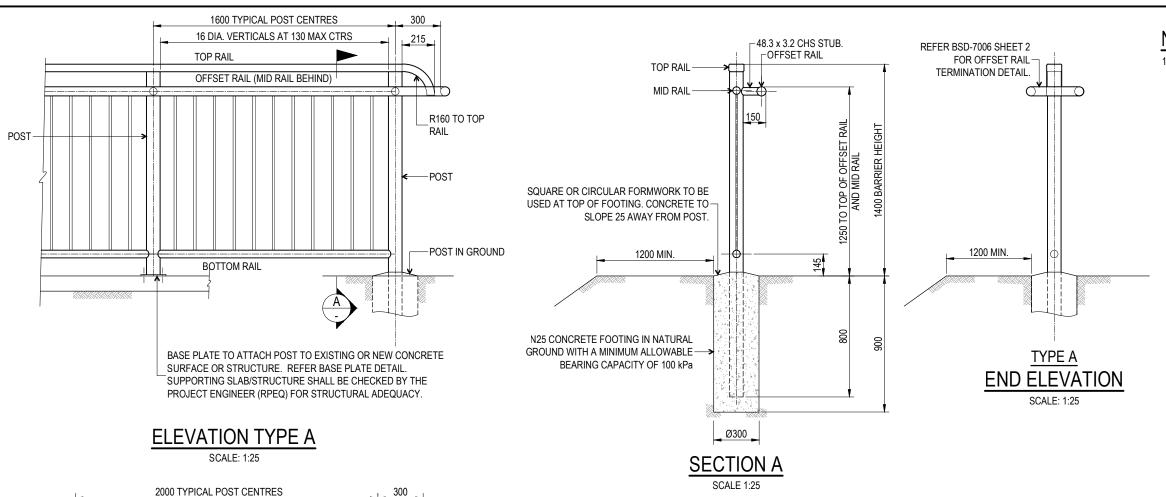

OFFSET RAIL

MID RAIL

POST

BOTTOM RAIL

POST IN GROUND


(NOT TO BE USED WHERE FALL HEIGHT IS 1.0m OR GREATER)

SURFACE OR STRUCTURE. REFER BASE PLATE DETAIL.
SUPPORTING SLAB/STRUCTURE SHALL BE CHECKED BY THE
PROJECT ENGINEER (RPEQ) FOR STRUCTURAL ADEQUACY.

BASE PLATE TO ATTACH POST TO EXISTING OR NEW CONCRETE

#### **ELEVATION TYPE B**

COALE: 4:00

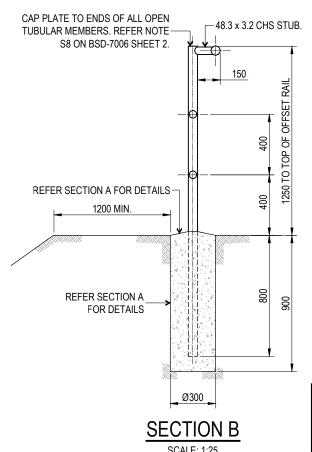

#### NOTES:

 REFER DRAWING BSD-7006 SHEET 2 FOR DRAWING NOTES AND STANDARD DETAILS

MEMBER SCHEDULE - TYPE A			
ELEMENT	MEMBER		
POSTS	88.9 x 5.0 CHS		
TOP RAIL	100 x 50 x 4.0 RHS		
MID RAIL	48.3 x 3.2 CHS		
BOTTOM RAIL	48.3 x 3.2 CHS		
OFFSET RAIL	60.3 x 3.6 CHS		

MEMBER SCHEDULE - TYPE B			
ELEMENT	MEMBER		
POSTS	60.3 x 5.4 CHS		
TOP RAIL	N/A		
MID RAIL	48.3 x 3.2 CHS		
BOTTOM RAIL	48.3 x 3.2 CHS		
OFFSET RAIL	60.3 x 3.6 CHS		

#### ATTENTION:

- BICYCLE FRIENDLY TUBULAR HANDRAILS TO BE USED ONLY IN SITUATIONS CLEAR OF LONGITUDINAL VEHICLE IMPACT SO AS TO AVOID A POTENTIAL SPEARING HAZARD TO MOTORISTS. THESE HANDRAILS ARE INTENDED AS A BIKE BARRIER AND ARE NOT TO BE USED IN SITUATIONS WHERE MOTOR VEHICLES/ CROWDS/ PEOPLE UNDER PANIC CONDITIONS REQUIRE RESTRAINT.
- PROJECT ENGINEER (RPEQ) TO CARRY OUT AN ASSESSMENT IN ACCORDANCE WITH THE RELEVANT STANDARDS TO DETERMINE WHICH BARRIER TYPE IS TO BE USED.
- BICYCLE FRIENDLY TUBULAR HANDRAILS ON THIS BSD HAVE NOT BEEN DESIGNED FOR FLOOD LOADING. IF HANDRAILS ARE REQUIRED TO RESIST FLOOD LOADING, THE PROJECT ENGINEER (RPEQ) WILL NEED TO ASSESS THE SUITABILITY OF THE BSD FOR USE AND MODIFY THE DESIGN AS REQUIRED.
- THIS BSD IS NOT FOR USE IN A MARINE ENVIRONMENT OR ENVIRONMENTS WITH A CORROSIVITY CATEGORY OF C4 OR GREATER IN ACCORDANCE WITH AS2312.1

THE PURPOSE OF THIS STANDARD DRAWING IS TO PROVIDE TYPICAL DETAILS THAT SUPPORT THE DESIRED OUTCOMES OF THE BRISBANE CITY PLAN 2014 AND ASSOCIATED PLANNING SCHEME POLICIES. THE FITNESS FOR PURPOSE OF THIS STANDARD DRAWING FOR A SPECIFIC PROJECT SHOULD BE ASSESSED AND ACCEPTED BY AN APPROPRIATELY QUALIFIED DESIGNER AND/OR REGISTERED PROFESSIONAL ENGINEER OF QUEENSLAND (RPEQ).



REFER BSD-7006 SHEET 2

TERMINATION DETAIL.

FOR OFFSET RAIL

1200 MIN.

TYPE B

END ELEVATION

#### BRISBANE CITY COUNCIL STANDARD DRAWING

BICYCLE FRIENDLY FENCE GALVANISED TUBULAR HANDRAIL SHEET 1 OF 2 PUBLISH DATE

DEC 2023

SCALE

NOT TO SCALE

DRAWING NUMBER

DEC 7006

BSD-7006
ORIGINAL SIZE REVISION D

#### **DESIGN LOADS:**

STATIC LOADING:

 $0.75 {\rm kN/m}$  TO TOP RAIL OR OFFSET RAIL (SIMULTANEOUSLY TRANSVERSE AND VERTICAL) AS PER AS5100.2.

0.6kN TO INFILL (TRANSVERSE) AS PER AS5100.2.

#### **GENERAL NOTES:**


- ALL WORKMANSHIP AND MATERIAL SHALL COMPLY WITH THE APPROPRIATE
   AUSTRALIAN STANDARDS THAT ARE CURRENT AT THE TIME OF CONSTRUCTION.
- 2. VERIFY LOCATIONS OF ALL SERVICES PRIOR TO COMMENCING WORK.
- 3. SAFETY PRECAUTIONS SHALL BE TAKEN TO AVOID INJURY TO PEOPLE DURING CONSTRUCTION. THE UNATTENDED HOLES SHALL BE COVERED OR FENCED OFF AT ALL TIMES.
- 4. FOOTINGS HAVE BEEN DESIGNED ON THE ASSUMPTION THAT THE MINIMUM ALLOWABLE BEARING CAPACITY OF SOIL IS 100KPa AND MINIMUM Cu = 50kPa FOR COHESIVE SOIL SAND. THE ACTUAL SOIL CONDITION IS TO BE ASSESSED BY A GEOTECHNICAL ENGINEER (RPEQ) AND IF FOUND TO BE OF WEAKER STRENGTH OR OF DIFFERENT TYPE TO THE ONE ASSUMED, A STRUCTURAL ENGINEER IS TO BE CONSULTED FOR A PROJECT SPECIFIC FOOTING DESIGN.
- 5. BASE PLATE SUPPORTING SLAB/STRUCTURE SHALL BE CHECKED BY A RPEQ FOR STRUCTURAL ADEQUACY.
- 6. ALL CONCRETE TO BE GRADE N25 MINIMUM.
- 7. DDA COMPLIANCE AS PER AS1428.1:


USE OF THIS STANDARD DRAWING IS LIMITED FOR STRUCTURES ON LONGITUDINAL GRADE OF 1:20 OR LESSER. NECESSARY DDA COMPLIANCE REQUIREMENTS ARE TO BE ASSESSED AND COMPLIED BY THE PROJECT ENGINEER (RPEQ.) FOR EACH PROJECT

8. ALL DIMENSIONS IN MILLIMETRES UNLESS NOTED OTHERWISE.

#### STEEL NOTES:

- S1. CIRCULAR HOLLOW STEEL SECTIONS SHALL BE IN ACCORDANCE WITH AS/NZS1163 GRADE C250L0 AND RECTANGULAR HOLLOW STEEL SECTIONS SHALL BE IN ACCORDANCE WITH AS/NZS1163 GRADE C350LO.
- S2. ALL STEELWORK TO BE HOT DIPPED GALVANISED IN ACCORDANCE WITH AS/NZS4680.
- S3. ALL POSTS TO BE VERTICAL.
- S4. ALL HORIZONTAL RAILS TO BE ROLLED TO MATCH SHAPE OF PATH/WALL IF RADIUS IS LESS THAN 20m.
- S5. MINIMUM LENGTH OF RAILS TO BE 2 SPANS LONG TO MINIMISE NEED FOR JOINTS AT EVERY POST.
- S6. ALL WELDS TO BE 4mm THICK C.F.W. (CONTINUOUS FILLET WELD) TO AS1554.1 U.N.O.
- S7. ALL WELDS TO BE MADE USING ELECTRODES WITH A NOMINAL TENSILE STRENGTH OF 490MPa (OR BETTER) TO AS/NZS1554. GRIND ALL CORNERS OF WELDS SMOOTH.
- S8. THE ENDS OF ALL TUBULAR MEMBERS ARE TO BE SEALED WITH 5mm THICK PLATES AND C.F.W. (U.N.O.).
- S9. THE PRINCIPAL CONTRACTOR SHALL CONFER WITH THE FABRICATOR AND GALVANISER TO ENSURE VENT HOLES ARE PROVIDED IN ACCORDANCE WITH AS/NZS4680.
- S10. EXPANSION JOINT SHALL BE PROVIDED IF THE LENGTH OF HANDRAIL EXCEEDS 20.0m OR TO MEET PROJECT REQUIREMENT. MINIMUM LENGTH OF CONTINUOUS RAIL TO BE TWO SPANS.
- S11. PROTECTIVE COATING TO BE APPLIED AFTER ALL FABRICATION COMPLETED. NO WELDING ETC. TO BE CARRIED OUT DURING OR AFTER APPLICATION OF COATING SYSTEM.
- S12. THE ONLY SITE WELDING ALLOWED IS AT THE EXPANSION JOINTS. TREATMENT OF THE SITE WELD IS TO BE MADE GOOD AS PER NOTE 13.
- S13. ANY POST GALVANISING DAMAGE TO BE MADE GOOD WITH AN ORGANIC EPOXY ZINC RICH PAINT CONFORMING TO AS/NZS3750.9. PAINT TO BE APPLIED TO THE REPAIR AREAS IN TWO COATS. EACH COAT SHALL HAVE A MINIMUM DRY FILM THICKNESS OF 50 MICRON AND SHALL BE APPLIED AS PER THE MANUFACTURER'S SPECIFICATIONS.

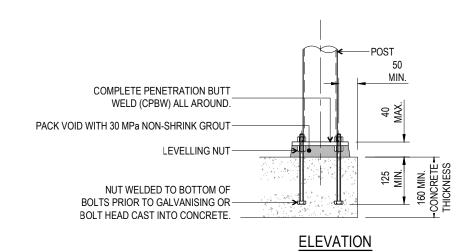


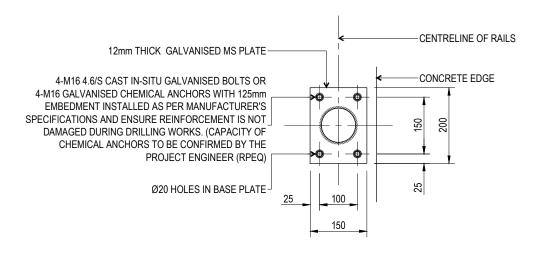

**PLAN** 

#### **BASE PLATE DETAIL**


SCALE: 1:10

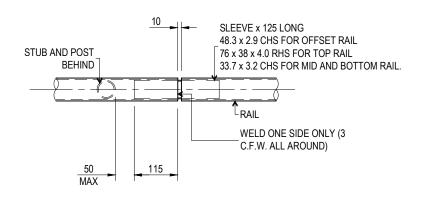

NOTE:
SPACING OF EJ'S TO SUIT FABRICATION, TRANSPORTATION AND
INSTALLATION REQUIREMENTS. MINIMUM LENGTH OF CONTINUOUS
RAIL TO BE TWO SPANS.

# RAIL EXPANSION JOINT AT 20.0m MAX. CTS. (FOR CONTINUOUS HANDRAIL LENGTHS)

SCALE: 1:10

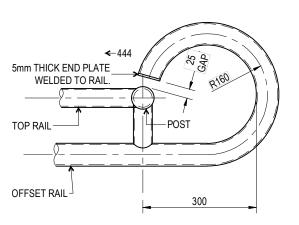

#### OFFSET RAIL TERMINATION DETAIL

SCALE: 1:10

THE PURPOSE OF THIS STANDARD DRAWING IS TO PROVIDE TYPICAL DETAILS THAT SUPPORT THE DESIRED OUTCOMES OF THE BRISBANE CITY PLAN 2014 AND ASSOCIATED PLANNING SCHEME POLICIES. THE FITNESS FOR PURPOSE OF THIS STANDARD DRAWING FOR A SPECIFIC PROJECT SHOULD BE ASSESSED AND ACCEPTED BY AN APPROPRIATELY QUALIFIED DESIGNER AND/OR REGISTERED PROFESSIONAL ENGINEER OF QUEENSLAND (RPEQ).




#### BRISBANE CITY COUNCIL STANDARD DRAWING

BICYCLE FRIENDLY FENCE GALVANISED TUBULAR HANDRAIL SHEET 2 OF 2

	PUBLISH DATE	
	DEC 2023	
_	SCALE	
	NOT TO SCALE	
	DRAWING NUMBER	

BSD-7006
ORIGINAL SIZE REVISION

A3 REVISION D

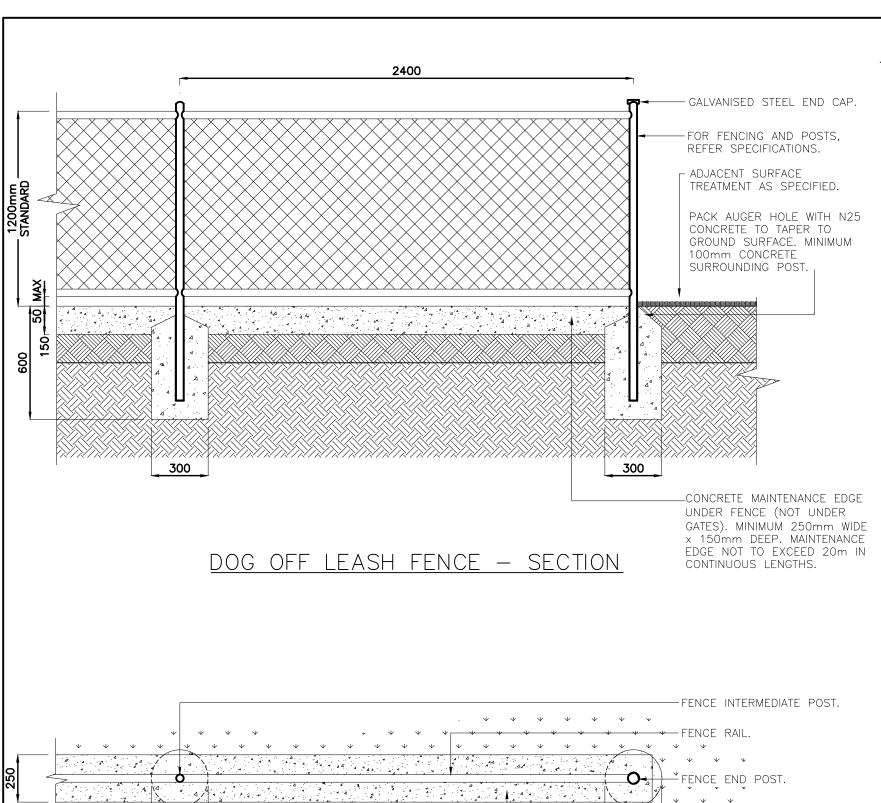

# CONCETE MAINTENANCE EDGE UNDER FENCE (NOT UNDER GATES). MINIMUM GAI CONC AT COI 28

#### DOG OFF LEASH FENCE - PLAN CONTRACTION JO PER BSD-5208.

<del>---- 300 ----</del>

250mm WIDE x 150mm DEEP.

MAINTENANCE EDGE NOT TO EXCEED
20m IN CONTINUOUS LENGTHS.

CONTRACTION JOINTS AT EVERY 4m AS
PER BSD-5208.

#### DRAWING AUTHORISED FOR PUBLICATION DESIGN Std Dwgs WG DATE OCT '13 PAUL COTTON SIGNATURE ON ORIGINAL DATED \_\_\_\_03/09/04\_\_\_ MANAGER INFRASTRUCTURE MANAGEMENT DRAWN CPO - P&D DATE OCT '13 R P F 0: 2546 CHECKED DATE OCT '13 UMD - E&P - IMB DESIGN APPROVED I AUREN TEMPI EMAN SIGNATURE ON ORIGINAL BSD-7007 (A) Fence - Dog off leash area.dwg A Drawing Converted From UMS Series April 2014 APR '14 APR '14 DATED 31/08/04 APR '14 FILENAME DRAWN ASSOCIATED PLANS ISSUE AMENDMENT SUPERSEDES UMS-726 PRICIPAL PROGRAM OFFICER PARKS

#### **GENERAL NOTES & SPECIFICATIONS**

- ENSURE DOG OFF LEASH FENCE IS LOCATED IN ACCORDANCE WITH DETAILED LANDSCAPE PLAN, AND PARKS CHAPTER OF INFRASTRUCTURE DESIGN PLANNING SCHEME POLICY.
- AUSTRALIAN STANDARDS SHALL BE IN ACCORDANCE WITH THE CURRENT EDITIONS OF THE REFERENCED AUSTRALIAN STANDARDS EXCEPT WHERE VARIED BY SPECIFICATIONS AND/OR DRAWINGS.
- MATERIAL CHOICES ARE TO BE DETERMINED ON THE GROUNDS OF SUSTAINABILITY, LOW
  MAINTENANCE, VANDAL RESISTANCE, PRODUCT AVAILABILITY AND SUITABILITY TO THE CLIMATIC
  CONDITIONS. WHERE POSSIBLE, MATERIALS ARE TO BE LOCALLY SOURCED.
- ENSURE DOG OFF LEASH FENCE IS CLEANED OF CONCRETE SLURRY OR SPRAY WHEN INSTALLED TO PREVENT STAINING OR DAMAGE TO APPLIED FINISHES.
- COLOUR SELECTION IN ACCORDANCE WITH STANDARD BCC CORPORATE COLOUR PALETTE. "BCC GREY 3" (AS 2700. "N65 GRAPHITE GREY" EQUIVALENT).
- STANDARD IS NOT FOR USE IN A MARINE ENVIRONMENT. THE MARINE ENVIRONMENT COULD EXTEND UP TO 1 km FROM THE FORESHORE.
- FOR NON-MARINE ENVIRONMENT, SUPPLY AND INSTALL 1200mm HIGH GALVANISED FENCE POST WITH TOP AND BOTTOM RAIL. ALL POSTS, RAILS AND FITTINGS TO BE GALVANISED STEEL TUBE TO AS 1163 THEN POWDER COATED.
- WHERE STANDARD IS REQUIRED FOR USE WITH MARINE ENVIRONMENT, THE FOLLOWING PROTECTION TREATMENT FOR STEELWORK IS REQUIRED:
  - HOT DIP GALVANISING: 85 MICRONS (600g/m²) MIN.
  - SWEEP ABRASIVE BLAST.
  - FIRST COAT: EPOXY PRIMER 75 MICRONS MIN.
  - SECOND COAT: TWO PACK ACRYLIC OR POLYURETHANE GLOSS 75 MICRONS MIN.
- ALL CHAINWIRE AND TIE WIRE (BOTH MARINE AND NON-MARINE APPLICATIONS) TO BE PVC COATED REFER BSD-7032 FOR SINGLE AND DOUBLE GATE REQUIREMENTS.
- OTHER SPECIFICATIONS:
  - GATE, CORNER AND END POSTS (CAPPED) 50NB (60.3 OD, 3.6 THICK).
  - INTERMEDIATE (POSTS CAPPED) 40NB (48.3 OD, 3.2 THICK).
  - RAILS AND BRACES 40NB (48.3 OD, 3.2 THICK).
  - CHAINWIRE 50mm NOMINAL MESH WITH 2.5mm PVC COATED WIRE.
  - CABLES & STRINGERS PVC COATED 3.15mm.
  - PANELS MAXIMUM SPAN 2400mm.
- ALL POSTS ARE TO BE CONCRETED INTO GROUND 300x600mm DEEP
- MAX. GAP OF 50mm UNDER FENCE. ANY GAPS BELOW FENCE OF MORE THAN 100mm ARE TO BE COVERED WITH INSTALLATION OF A BOTTOM STRINGER LINE, PVC COATED WITH AN IN LINE TENSIONER.
- ALL DIMENSIONS IN MILLIMETRES (U.N.O.).

#### <u> FIXTURES/FITTINGS & METAL WORK NOTES</u>

- ALL WORKMANSHIP AND MATERIAL SHALL BE IN ACCORDANCE WITH AS 4100 & AS/NZS 1554.
- ALL METAL FINISHES TO BE IN ACCORDANCE WITH AS 4506.
- ALL FIXTURES/FITTINGS UNLESS SPECIFIED ARE TO BE HOT DIPPED GALVANISED. IN VICINITY OF SALTWATER/SPRAY, ENSURE ALL FASTENERS ARE STAINLESS STEEL. PLASTIC SEPARATORS SHALL BE PROVIDED TO AVOID CONTACT BETWEEN DISSIMILAR MATERIALS.STAINLESS STEEL GRADE 316 TO BE USED. WHERE POSSIBLE ALL FIXINGS TO BE TAMPER/VANDAL PROOF TO MINIMISE DAMAGE OR THEFT.
- ALL WELDS TO BE CONTINUOUS FILLET WELDS, GROUND OFF SMOOTH & FLUSH IN ACCORDANCE WITH AS 1554. GRIND SMOOTH EDGES & WELDS PRIOR TO HOT DIPPED GALVANISING OR APPLIED FINISHES.

#### CONCRETE WORK NOTES


- ALL WORKMANSHIP AND MATERIAL SHALL BE IN ACCORDANCE WITH AS 3600.
- AT A MINIMUM ALL CONCRETE TO BE GRADE N25. CONCRETE SHALL BE NORMAL CLASS
   CONCRETE UNLESS DIRECTED OTHERWISE. N25 SHALL MEAN NORMAL CLASS CONCRETE WITH A
   28 DAY CHARACTERISTIC STRENGTH OF 25MPa. CONCRETE MIX DESIGN SHALL BE SUBMITTED
   TO THE SITE SUPERINTENDENT FOR APPROVAL FIVE (5) DAYS PRIOR TO ORDERING.
- ALL CEMENT TO BE TYPE GP OR GB TO AS 3972 UNLESS SPECIFIED OTHERWISE.
- NORMAL AGGREGATE SIZE TO BE 20mm, SLUMP TO BE NOT GREATER THAN 80mm.
- THE BOTTOMS OF ALL FOOTINGS ARE TO BE CLEANED OF ALL LOOSE MATERIAL AND WATER PRIOR TO PLACING CONCRETE.



#### **BRISBANE CITY COUNCIL STANDARD DRAWING**

FENCE -DOG OFF LEASH AREA

•	DAILD DI	MILLIC
	SCALE 1:2	20
	BWG No.	
	BSD-	7007
	ORIGINAL SIZE	REVISION
	Α3	А

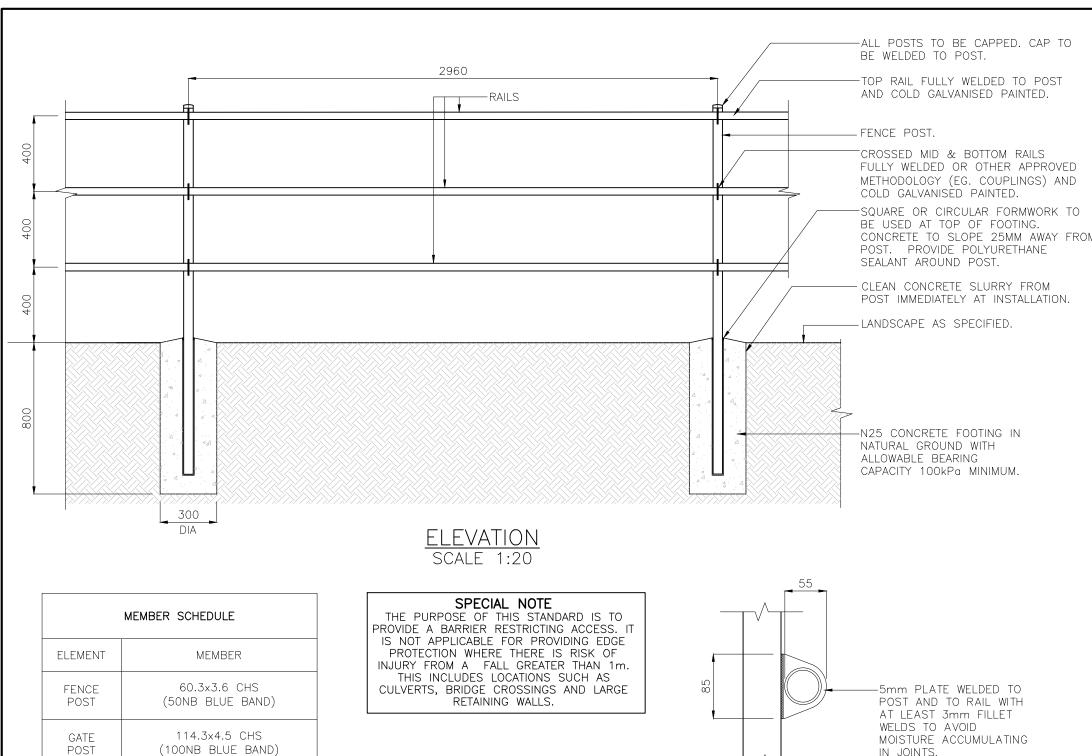

CONCRETE TO SLOPE 25MM AWAY FROM

#### STEEL NOTES

GENERAL NOTES

OF CONSTRUCTION WORKS.

DISTANCES.

CONSTRUCTION.

SOIL IS 100kPa.

1. WHERE FENCE IS FOR USE IN A NON-MARINE ENVIRONMENT (MORE THAN 1KM FROM THE FORESHORE), THE FOLLOWING PROTECTION TREATMENT IS REQUIRED: HOT DIP GALVANISING:

- ENSURE THAT WORK IS IN ACCORDANCE WITH BRISBANE CITY COUNCIL ENVIRONMENTAL BEST PRACTICE NOTES.

- SITE SETOUT TO BE VERIFIED BY SUPERINTENDENT OR

- VERIFY LOCATION OF ALL SERVICES AND EASEMENTS

- WRITTEN DIMENSIONS TAKE PRECEDENCE OVER SCALED

- FOOTINGS HAVE BEEN DESIGNED ON THE ASSUMPTION THAT THE MINIMUM ALLOWABLE BEARING CAPACITY OF

MODIFICATION AS NECESSARY WILL BE REQUIRED FOR

PRIOR TO THE COMMENCEMENT OF WORKS.

- VERIFY ALL DIMENSIONS ON SITE PRIOR TO

- IN EACH CASE ENGINEERING CERTIFICATION AND

- THE COPYRIGHT OF THIS DRAWING REMAINS THE PROPERTY OF THE BRISBANE CITY COUNCIL.

PARTICULAR SOIL AND SITE CONDITIONS.

- DIMENSIONS IN MILLIMETRES (UNO)

LANDSCAPE ARCHITECT PRIOR TO THE COMMENCEMENT

- FERROUS OPEN SECTIONS TO AS4791 - FERROUS HOLLOW SECTIONS TO AS4792

STEEL WORK

- MAY BE POWDERCOATED TO AS4506 -COLOUR 'MATT BLACK' IF REQUIRED.
- 2. WHERE FENCE IS REQUIRED FOR USE WITHIN MARINE ENVIRONMENT (UP TO 1km FROM THE FORESHORE), THE FOLLOWING PROTECTION TREATMENT IS REQUIRED: HOT DIP GALVANISING:
  - 85 MICRONS (600G/M<sup>2</sup>) MIN;
  - SWEEP ABRASIVE BLAST;

STEELWORK FIRST COAT:

- EPOXY PRIMER 75 MICRONS MIN:

STEELWORK SECOND COAT:

- TWO PACK ACRYLIC OR POLYURETHANE GLOSS 75 MICRONS MIN:
- 3. PAINT SYSTEMS TO BE IN ACCORDANCE WITH AS2312
- AND IS DESIGNATED HDG600P6.
- 4. ALL STEEL TUBE TO AS/NZ1163.
- 5. POSTS TO BE VERTICAL.
- 6. ALL RAILS ARE SWAGED AND WELDED. SWAGES TO BE ON INSIDE OF FENCE AND NOT FACING PUBLIC ROADS,
- 7. ALL JOINTS TO BE FULLY WELDED. WELDS TO BE 5 THICK C.F.W (CONTINUOUS FILLET WELDS) TO AS554.1 WITH COLD GALVANISING TREATMENT TO COMPLETED WELDS
- 8. PREFERRED COLD GALVANISING TREATMENT FOR IN-SITU WELDS, CUT ENDS OR OTHER BARE STEEL IS TO APPLY 2 COATS OF INORGANIC ZINC PRIMER APPLIED BY
- 9. STANDARD COUPLINGS (MONOWILLS, SENTAUR JOINTS, KEE-KLAMP, SWAGED JOINTS OR SIMILAR) FOR POST TO RAIL CONNECTIONS MAY BE USED AS AN ALTERNATIVE TO WELDS WHERE APPROVED. 11° MAX REFLECTION FROM HORIZONTAL FOR STANDARD COUPLINGS. FOR ANGLES GREATER THAN 11°, SPECIALIST COUPLINGS MAY BE USED UPON APPROVAL FROM COUNCIL.

ISSUE	AMENDMENT	DRAWN DATE	CHK'D DATE	APPR'D DATE	SENIOR CO-ORDINATOR NATURAL ENVIRONMENT ASSET SERVICES/BRISBANE INFRASTRUCTURE	ASSOCIATED PLANS			
А	ORIGINAL ISSUE	DEC '14	DEC '14	DEC '14		DRAWING FILENAME	BSD-7008 (A) Fence - Nat	ural area -	Three rail.dwg
					DESIGN APPROVED	LHELKED	BI - FSG - AS	DATE	DEC '14
					STRATEGIC ASSET MANAGEMENT	CHECKER	DI 505 10	D. 1.T.	DEC 141
					ASSET ENGINEERING MANAGER	DRAWN	CPO - P&D	DATE	DEC '14
					DRAWING AUTHORISED FOR PUBLICATION	DESIGN	CPO - P&D	DATE	DEC '14
							ı		

48.3x3.2 CHS

(40NB BLUE BAND)

**RAILS** 



#### **BRISBANE CITY COUNCIL STANDARD DRAWING**

**FENCE** NATURAL AREA THREE RAIL

SCALE	AS	SHOWN	
DWG No.			
В	SD-	-7008	
ORIGINAL SIZE		REVISION	
А	3	А	

#### GENERAL NOTES

- ENSURE THAT WORK IS IN ACCORDANCE WITH BRISBANE CITY COUNCIL ENVIRONMENTAL BEST PRACTICE NOTES.
- SITE SETOUT TO BE VERIFIED BY SUPERINTENDENT OR LANDSCAPE ARCHITECT PRIOR TO THE COMMENCEMENT OF CONSTRUCTION WORKS.
- VERIFY LOCATION OF ALL SERVICES AND EASEMENTS PRIOR TO THE COMMENCEMENT OF WORKS.
- WRITTEN DIMENSIONS TAKE PRECEDENCE OVER SCALED DISTANCES.
- VERIFY ALL DIMENSIONS ON SITE PRIOR TO CONSTRUCTION.
   FOOTINGS HAVE BEEN DESIGNED ON THE ASSUMPTION
- THAT THE MINIMUM ALLOWABLE BEARING CAPACITY OF SOIL IS 100kPa.
- IN EACH CASE ENGINEERING CERTIFICATION AND MODIFICATION AS NECESSARY WILL BE REQUIRED FOR PARTICULAR SOIL AND SITE CONDITIONS.
- THE COPYRIGHT OF THIS DRAWING REMAINS THE PROPERTY OF THE BRISBANE CITY COUNCIL.
- DIMENSIONS IN MILLIMETRES (UNO)

#### STEEL NOTES

- 1. WHERE FENCE IS FOR USE IN A NON-MARINE ENVIRONMENT (MORE THAN 1KM FROM THE FORESHORE), THE FOLLOWING PROTECTION TREATMENT IS REQUIRED:
- HOT DIP GALVANISING:
- FERROUS OPEN SECTIONS TO AS4791
   FERROUS HOLLOW SECTIONS TO AS4792
   STEEL WORK
  - MAY BE POWDERCOATED TO AS4506 COLOUR 'MATT BLACK' IF REQUIRED.
- 2. WHERE FENCE IS REQUIRED FOR USE WITHIN MARINE ENVIRONMENT (UP TO 1km FROM THE FORESHORE), THE FOLLOWING PROTECTION TREATMENT IS REQUIRED: HOT DIP GALVANISING:
  - 85 MICRONS (600G/M $^2$ ) MIN;
  - SWEEP ABRASIVE BLAST;

STEELWORK FIRST COAT:

- EPOXY PRIMER 75 MICRONS MIN;

STEELWORK SECOND COAT:

- TWO PACK ACRYLIC OR POLYURETHANE GLOSS 75 MICRONS MIN;
- 3. PAINT SYSTEMS TO BE IN ACCORDANCE WITH AS2312 AND IS DESIGNATED HDG600P6.
- 4. ALL GALVANISED STEEL TUBE TO AS1163.
- 5. STANDARD COUPLINGS (DOWN-EE FITTINGS) MAY BE USED AS AN ALTERNATIVE TO SWAGED JOINTS AND WELDS
- 6. GALVANISED STEEL END CAPS TO BE PROVIDED TO ALL POSTS.
- 7. CORNER POSTS TO BE ADOPTED WHERE THE CHANGE IN ANGLE IN HORIZONTAL ALIGNMENT EXCEEDS 20 DEGREES..
- 8. ALL WELDS TO BE 6 THICK C.F.W (CONTINUOUS FILLET WELDS) TO AS1554.1 WITH COLD GALVANISING TREATMENT TO COMPLETED WELDS.
- 9. PREFERRED COLD GALVANISING TREATMENT FOR IN-SITU WELDS, CUT ENDS OR OTHER BARE STEEL IS TO APPLY 2 COATS OF INORGANIC ZINC PRIMER APPLIED BY BRUSH
- 10. 1800 CHAIN WIRE TO BE 3.15 THICK X 50 PITCH MESH GALVANISED PVC TO AS 2423.
- 11. GOOSE NECKED STAYS TO BE PROVIDED AT END POSTS, GATE POSTS, CORNER POSTS AND EVERY EIGHTH POST.
- 12. POSTS ARE TO BE VERTICAL.
- 13. ALL CONCRETE TO BE N25.
- 14. CHAIN WIRE TO BE FIXED USING 2.0 WIRE TIES AS FOLLOWS:
  - INTERMEDIATE POSTS AT 3 LOCATIONS
  - END POSTS AT 3 LOCATIONS
  - HORIZONTAL CABLE AT 375 CENTRES TO TOP CABLE
  - HORIZONTAL CABLE AT 600 CENTRES TO MIDDLE CABLE
  - HORIZONTAL CABLE AT 450 CENTRES TO BOTTOM CABLE
- 15. GALV STEEL SHEETS TO BE POWDERCOATED OR PREPAINTED TO AS 2728, COLOURED ON BOTH SIDES. THE COLOUR SHALL BE 'MIST GREEN OR 'RIVER GUM' SUBJECT TO FINAL APPROVAL BY SUPERINTENDENT. SHEETS SHALL BE 0.42MM BMT, OVERLAPPED AT POSTS ONLY AND FASTENED TO POST BY POP RIVETS AT 150 CENTRES. SHEETING TO BE ON PARK SIDE OF FENCE.

MEMBER SCHEDULE						
ELEMENT	MEMBER					
END POST	60.3x3.6 CHS (50NB BLUE BAND)					
CORNER	60.3x3.6 CHS					
POST	(50NB BLUE BAND)					
EVERY EIGHTH	60.3x3.6 CHS					
POST	(50NB BLUE BAND)					
INTERMEDIATE	42.4×3.2 CHS					
POST	(32NB BLUE BAND)					
GATE POST	88.9x3.2 CHS (80NB YELLOW BAND)					
GOOSE	42.4x3.2 CHS					
NECKED STAY	(32NB BLUE BAND)					

SPECIAL NOTE

THE PURPOSE OF THIS STANDARD IS TO PROVIDE A BARRIER RESTRICTING ACCESS. IT IS NOT APPLICABLE FOR PROVIDING EDGE PROTECTION WHERE THERE IS RISK OF INJURY FROM A FALL GREATER THAN 1m. THIS INCLUDES LOCATIONS SUCH AS CULVERTS, BRIDGE CROSSINGS AND LARGE RETAINING WALLS.


ISSUE	AMENDMENT	DRAWN DATE	CHK'D DATE	APPR'D DATE	SENIOR CO-ORDINATOR NATURAL ENVIRONMENT ASSET SERVICES/BRISBANE INFRASTRUCTURE	ASSOCIATED PLANS	BSD-7009-Sheet 2		
А	ORIGINAL ISSUE	DEC '14	DEC '14	DEC '14		DRAWING FILENAME	BSD-7009 (A) Fence - Natural area - Chainvi	ire fauna exclusion	fence - Sheet 1 of 2.dwg
					STRATEGIC ASSET MANAGEMENT  DESIGN APPROVED	CHECKED	BI - FSG - AS	DATE	DEC '14
					ASSET ENGINEERING MANAGER	DRAWN	CPO - P&D	DATE	DEC '14
					DRAWING AUTHORISED FOR PUBLICATION	DESIGN	CPO - P&D	DATE	DEC '14




#### **BRISBANE CITY COUNCIL STANDARD DRAWING**

FENCE — NATURAL AREA — CHAINWIRE FAUNA EXCLUSION FENCE -SHEET 1 OF 2

JAKO DI	WILLIA
SCALE AS S	SHOWN
DWG No.	
BSD-	-7009
ORIGINAL SIZE	REVISION
Α3	Α

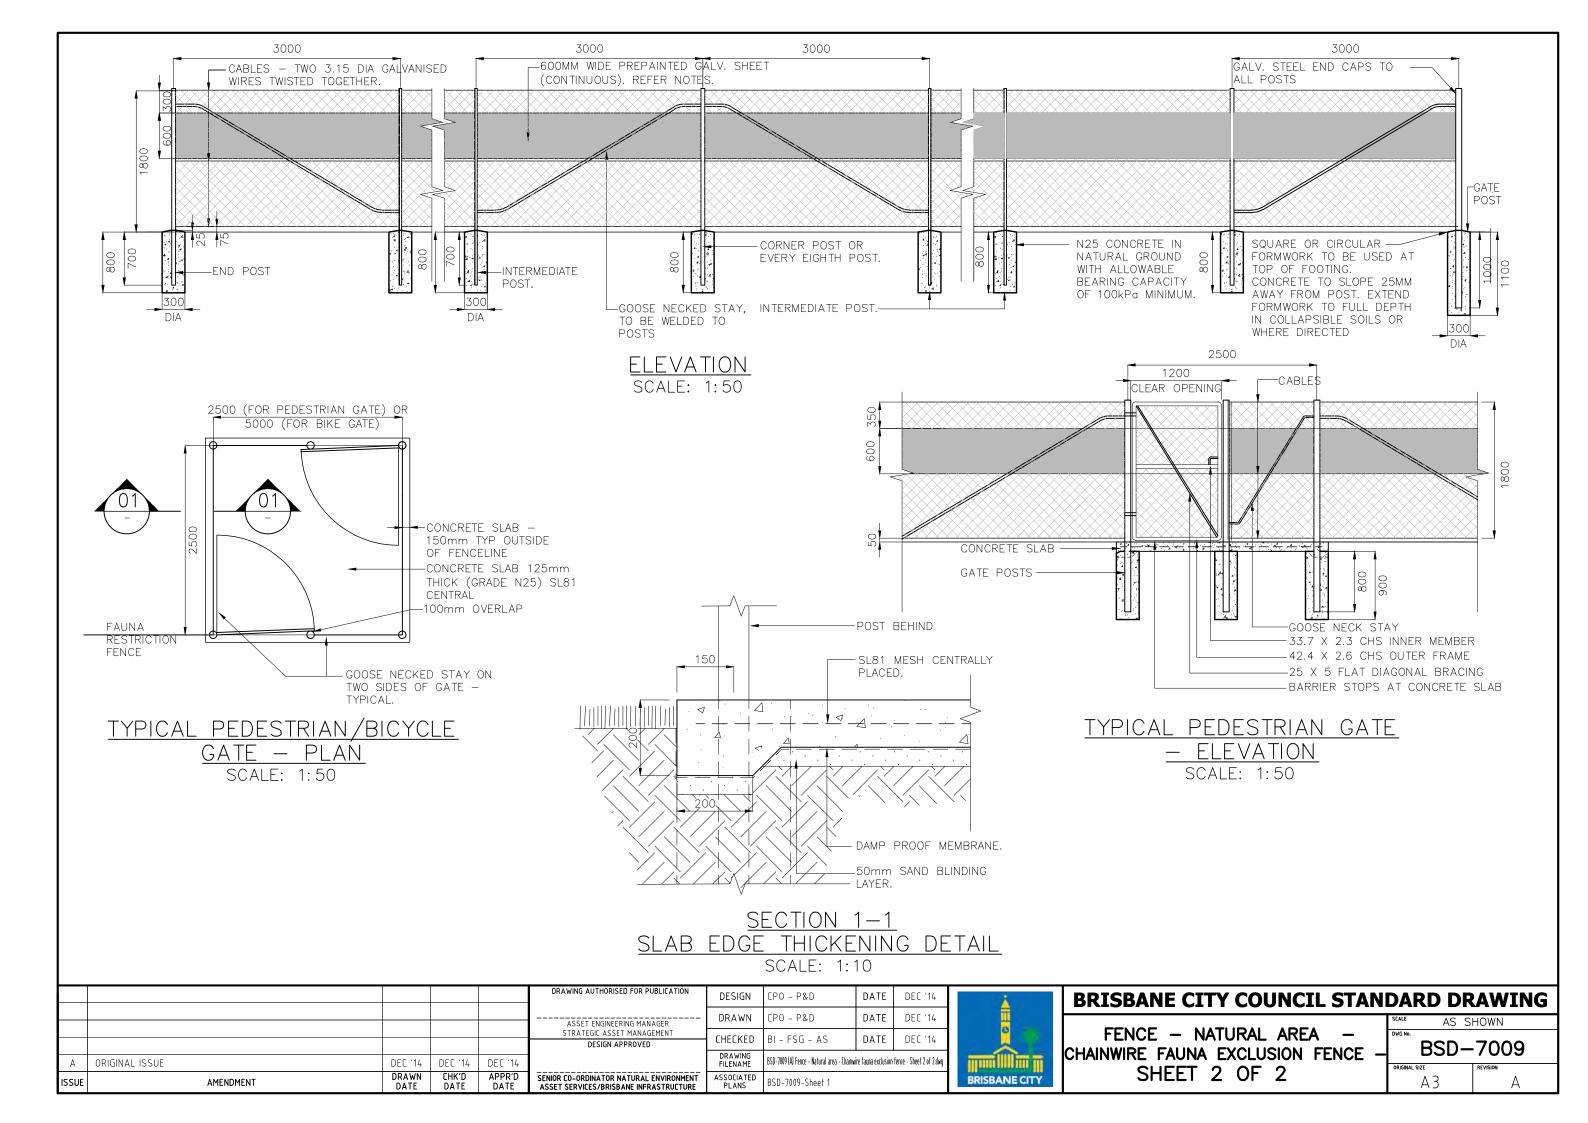

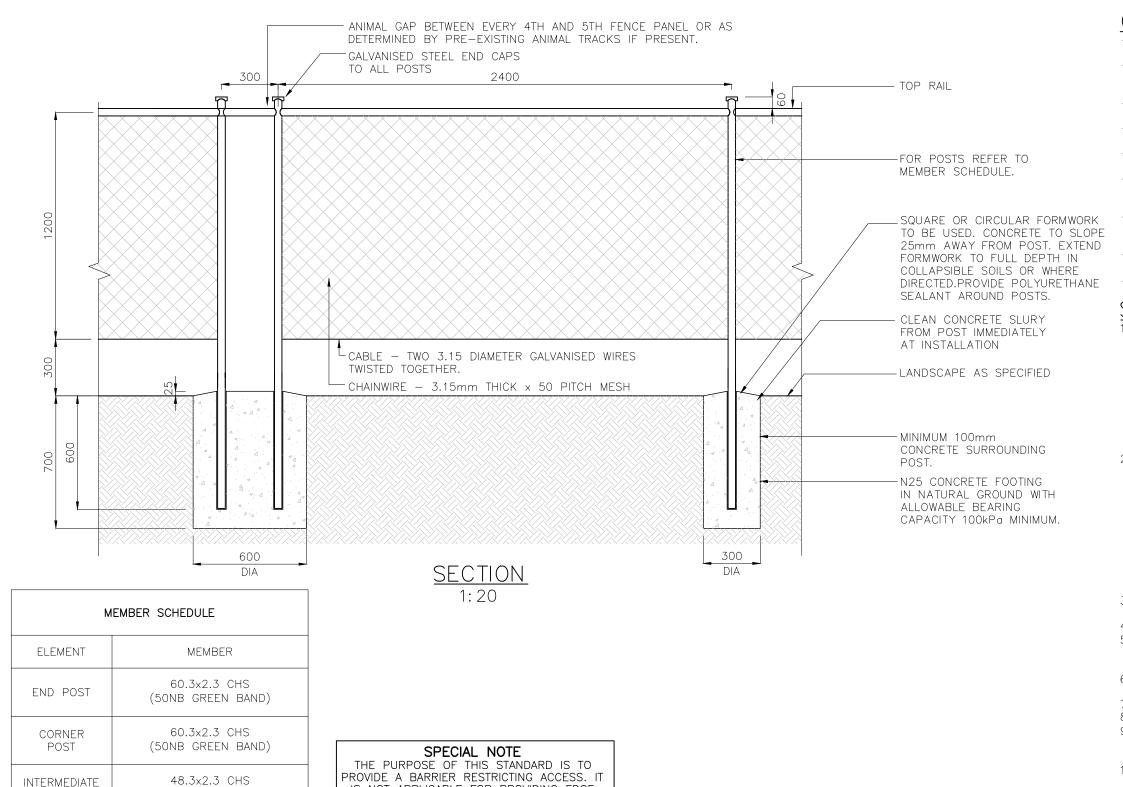

THE PURPOSE OF THIS STANDARD IS TO PROVIDE A BARRIER RESTRICTING ACCESS. IT IS NOT APPLICABLE FOR PROVIDING EDGE PROTECTION WHERE THERE IS RISK OF INJURY FROM A FALL GREATER THAN 1m. THIS INCLUDES LOCATIONS SUCH AS CULVERTS, BRIDGE CROSSINGS AND LARGE RETAINING WALLS.

(40NB GREEN BAND)

48.3x2.3 CHS

(40NB GREEN BAND)

POST

TOP RAIL

#### FENCE FINISH

TYPE '

STANDARD GALVANISED.

#### TYPE 2

MATT BLACK PVC COATED CHAIN WIRE, SUPPORT CABLES AND LACING WIRE. ALL POSTS, FIXINGS, COUPLINGS AND WIRE TO BE MATT BLACK.

#### GENERAL NOTES

- ENSURE THAT WORK IS IN ACCORDANCE WITH BRISBANE CITY COUNCIL ENVIRONMENTAL BEST PRACTICE NOTES.
- SITE SETOUT TO BE VERIFIED BY SUPERINTENDENT OR LANDSCAPE ARCHITECT PRIOR TO THE COMMENCEMENT OF CONSTRUCTION WORKS.
- VERIFY LOCATION OF ALL SERVICES AND EASEMENTS PRIOR TO THE COMMENCEMENT OF WORKS.
- WRITTEN DIMENSIONS TAKE PRECEDENCE OVER SCALED DISTANCES.
- VERIFY ALL DIMENSIONS ON SITE PRIOR TO CONSTRUCTION.
- FOOTINGS HAVE BEEN DESIGNED ON THE ASSUMPTION THAT THE MINIMUM ALLOWABLE BEARING CAPACITY OF SOIL IS 100kPa.
- IN EACH CASE ENGINEERING CERTIFICATION AND MODIFICATION AS NECESSARY WILL BE REQUIRED FOR PARTICULAR SOIL AND SITE CONDITIONS.
- THE COPYRIGHT OF THIS DRAWING REMAINS THE PROPERTY OF THE BRISBANE CITY COUNCIL.
- DIMENSIONS IN MILLIMETRES (UNO)

#### STEEL NOTES

- 1. WHERE FENCE IS FOR USE IN A NON-MARINE ENVIRONMENT (MORE THAN 1KM FROM THE FORESHORE), THE FOLLOWING PROTECTION TREATMENT IS REQUIRED:
- HOT DIP GALVANISING:
  - FERROUS OPEN SECTIONS TO AS4791
- FERROUS HOLLOW SECTIONS TO AS4792 STEEL WORK
  - MAY BE POWDERCOATED TO AS4506 COLOUR 'MATT BLACK' IF REQUIRED.
- 2. WHERE FENCE IS REQUIRED FOR USE WITHIN MARINE ENVIRONMENT (UP TO 1km FROM THE FORESHORE), THE FOLLOWING PROTECTION TREATMENT IS REQUIRED: HOT DIP GALVANISING:
  - 85 MICRONS (600G/M²) MIN;
  - SWEEP ABRASIVE BLAST;

STEELWORK FIRST COAT:

- EPOXY PRIMER 75 MICRONS MIN;
- STEELWORK SECOND COAT:
  - TWO PACK ACRYLIC OR POLYURETHANE GLOSS 75 MICRONS MIN;
- 6. PAINT SYSTEMS TO BE IN ACCORDANCE WITH AS2312 AND IS DESIGNATED HDG600P6.
- 4. ALL GALVANISED STEEL TUBE TO AS1163.
- STANDARD COUPLINGS (MONOWILLS, SENTAUR JOINTS, KEE-KLAMP, SWAGED JOINTS OR SIMILAR) MAY BE USED AS AN ALTERNATIVE TO WELDS WHERE APPROVED.
- GALVANISED STEEL END CAPS TO BE PROVIDED TO ALL POSTS.
- 7. POSTS ARE TO BE VERTICAL.
- B. ALL CONCRETE TO BE GRADE N25.
- 9. ALL WELDS TO BE 6 THICK C.F.W (CONTINUOUS FILLET WELDS) TO AS1554.1 WITH COLD GALVANISING TREATMENT TO COMPLETED WELDS.
- 10. PREFERRED COLD GALVANISING TREATMENT FOR IN—SITU WELDS, CUT ENDS OR OTHER BARE STEEL IS TO APPLY 2 COATS OF INORGANIC ZINC PRIMER APPLIED BY BRUSH.
- 11. CHAIN WIRE TO BE 3.15 THICK X 50 PITCH MESH GALVANISED PVC TO AS 2423.
- 12. CHAIN WIRE TO BE FIXED AS FOLLOWS:
  - LACE CONTINUOUSLY TO RAILS (2.0MM WIRE)
  - TIE TO POSTS AT 3 LOCATIONS PER POST (SPACE EVENLY, USE 2.0MM WIRE)
  - TIE TO CABLE USING 2.0MM WIRE @ 375MM CENTRES


					DRAWING AUTHORISED FOR PUBLICATION	DESIGN	CPO - P&D	DATE	DEC '14	П
					ASSET ENGINEERING MANAGER	DRAWN	CPO - P&D	DATE	DEC '14	
					STRATEGIC ASSET MANAGEMENT  DESIGN APPROVED	CHECKED	BI - FSG - AS	DATE	DEC '14	
А	ORIGINAL ISSUE	DEC '14	DEC '14	DEC '14		DRAWING FILENAME	BSD-7010 (A) Fence - Natural area -	Chainwire fauna	friendly fence.dwg	
ISSUE	AMENDMENT	DRAWN DATE	CHK'D DATE	APPR'D DATE	SENIOR CO-ORDINATOR NATURAL ENVIRONMENT ASSET SERVICES/BRISBANE INFRASTRUCTURE	ASSOCIATED PLANS				



#### **BRISBANE CITY COUNCIL STANDARD DRAWING**

FENCE - NATURAL AREA - CHAINWIRE FAUNA FRIENDLY FENCE

SEALE AS	SHOWN
DWG No.	
RSL	7010
טטט	7010
ORIGINAL SIZE	REVISION
Α3	A

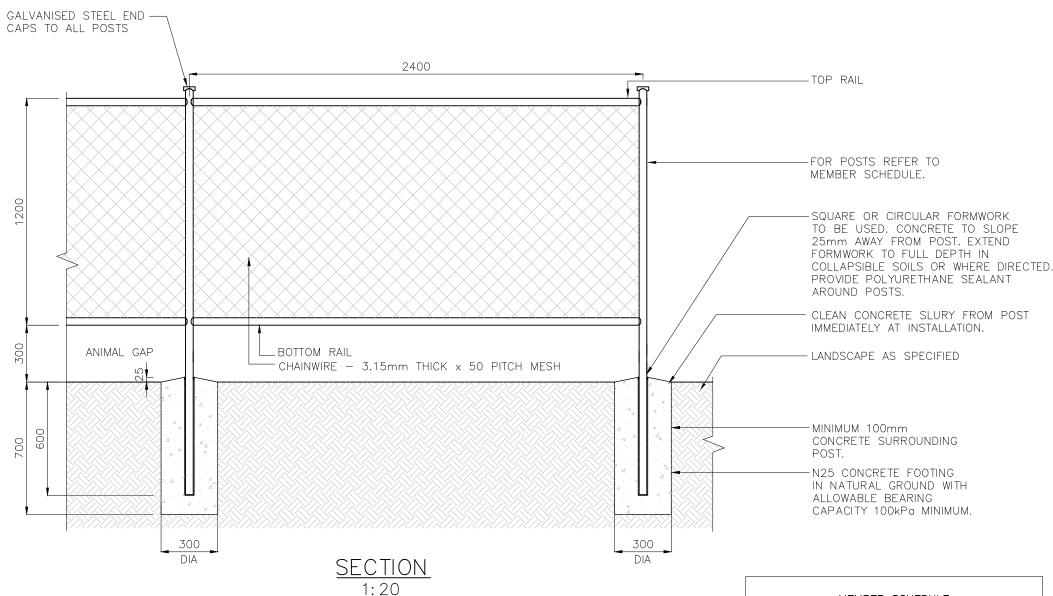

#### FENCE FINISH

STANDARD GALVANISED

TYPE 2

MATT BLACK PVC COATED CHAIN WIRE AND LACING WIRE. ALL POSTS, FIXINGS, COUPLINGS AND WIRE TO BE MATT BLACK

M	MEMBER SCHEDULE						
ELEMENT	MEMBER						
END POST	60.3x3.6 CHS (50NB BLUE BAND)						
CORNER POST	60.3x3.6 CHS (50NB BLUE BAND)						
INTERMEDIATE POST	48.3x3.2 CHS (40NB BLUE BAND)						
TOP RAIL	48.3x3.2 CHS (40NB BLUE BAND)						
BOTTOM RAIL	48.3x3.2 CHS (40NB BLUE BAND)						

#### GENERAL NOTES

- ENSURE THAT WORK IS IN ACCORDANCE WITH BRISBANE CITY COUNCIL ENVIRONMENTAL BEST PRACTICE NOTES.
- SITE SETOUT TO BE VERIFIED BY SUPERINTENDENT OR LANDSCAPE ARCHITECT PRIOR TO THE COMMENCEMENT OF CONSTRUCTION WORKS.
- VERIFY LOCATION OF ALL SERVICES AND EASEMENTS PRIOR TO THE COMMENCEMENT OF WORKS.
- WRITTEN DIMENSIONS TAKE PRECEDENCE OVER SCALED DISTANCES.
- VERIFY ALL DIMENSIONS ON SITE PRIOR TO CONSTRUCTION.
- FOOTINGS HAVE BEEN DESIGNED ON THE ASSUMPTION THAT THE MINIMUM ALLOWABLE BEARING CAPACITY OF SOIL IS 100KPA.
- IN EACH CASE ENGINEERING CERTIFICATION AND MODIFICATION AS NECESSARY WILL BE REQUIRED FOR PARTICULAR SOIL AND SITE CONDITIONS.
- THE COPYRIGHT OF THIS DRAWING REMAINS THE PROPERTY OF THE BRISBANE CITY COUNCIL.
- DIMENSIONS IN MILLIMETRES (UNO)

#### STEEL NOTES

- 1. WHERE FENCE IS FOR USE IN A NON-MARINE ENVIRONMENT (MORE THAN 1KM FROM THE FORESHORE), THE FOLLOWING PROTECTION TREATMENT IS REQUIRED:
  - HOT DIP GALVANISING:
    - FERROUS OPEN SECTIONS TO AS4791
- FERROUS HOLLOW SECTIONS TO AS4792 STEEL WORK
  - MAY BE POWDERCOATED TO AS4506 COLOUR 'MATT BLACK' IF REQUIRED.
- 2. WHERE FENCE IS REQUIRED FOR USE WITHIN MARINE ENVIRONMENT (UP TO 1km FROM THE FORESHORE), THE FOLLOWING PROTECTION TREATMENT IS REQUIRED: HOT DIP GALVANISING:
  - 85 MICRONS (600G/M<sup>2</sup>) MIN;
  - SWEEP ABRASIVE BLAST;

STEELWORK FIRST COAT:

- EPOXY PRIMER 75 MICRONS MIN;
- STEELWORK SECOND COAT:
  - TWO PACK ACRYLIC OR POLYURETHANE GLOSS 75 MICRONS MIN;
- 3. PAINT SYSTEMS TO BE IN ACCORDANCE WITH AS2312 AND IS DESIGNATED HDG600P6.
- 4. ALL GALVANISED STEEL TUBE TO AS1163.
- . STANDARD COUPLINGS (DOWN-EE FITTINGS) MAY BE USED AS AN ALTERNATIVE TO SWAGED JOINTS AND WELDS.
- 5. GALVANISED STEEL END CAPS TO BE PROVIDED TO ALL POSTS.
- 7. POSTS ARE TO BE VERTICAL
- 8. ALL CONCRETE TO BE GRADE N25.
- 9. ALL WELDS TO BE 6 THICK C.F.W (CONTINUOUS FILLET WELDS) TO AS1554.1 WITH COLD GALVANISING TREATMENT TO COMPLETED WELDS.
- 10. PREFERRED COLD GALVANISING TREATMENT FOR IN—SITU WELDS, CUT ENDS OR OTHER BARE STEEL IS TO APPLY 2 COATS OF INORGANIC ZINC PRIMER APPLIED BY BRUSH.
- 11. CHAIN WIRE TO BE 3.15 THICK X 50 PITCH MESH GALVANISED PVC TO AS 2423.
- 12. CHAIN WIRE TO BE FIXED AS FOLLOWS:
  - LACE CONTINUOUSLY TO RAILS (2.0MM WIRE)
  - TIE TO POSTS AT 2 LOCATIONS PER POST (SPACE EVENLY, USE 2.0MM WIRE)
- 13. GALVANISED TUBULAR HANDRAILS TO BE USED ONLY IN SITUATIONS CLEAR OF LONGITUDINAL VEHICLE IMPACT.
- 14. THESE FENCES ARE INTENDED AS A PEDESTRIAN BARRIER AND ARE NOT TO BE USED IN SITUATIONS WHERE MOTOR VEHICLES REQUIRE RESTRAINT.


					DRAWING AUTHORISED FOR PUBLICATION	DESIGN	CPO - P&D	DATE	DEC '14
					ASSET ENGINEERING MANAGER	DRAWN	CPO - P&D	DATE	DEC '14
					STRATEGIC ASSET MANAGEMENT  DESIGN APPROVED	CHECKED	BI - FSG - AS	DATE	DEC '14
А	ORIGINAL ISSUE	DEC '14	DEC '14	DEC '14		DRAWING FILENAME	BSD-7011 (A) Fence - Natural	area - Chain	wire handrail.dwg
ISSUE	AMENDMENT	DRAWN DATE	CHK'D DATE	APPR'D DATE	SENIOR CO-ORDINATOR NATURAL ENVIRONMENT ASSET SERVICES/BRISBANE INFRASTRUCTURE	ASSOCIATED PLANS			



#### **BRISBANE CITY COUNCIL STANDARD DRAWING**


FENCE NATURAL AREA CHAINWIRE HANDRAIL

SCALE AS	SHOWN
DWG No.	
BSD	<b>-7011</b>
ORIGINAL SIZE	REVISION
Α3	A

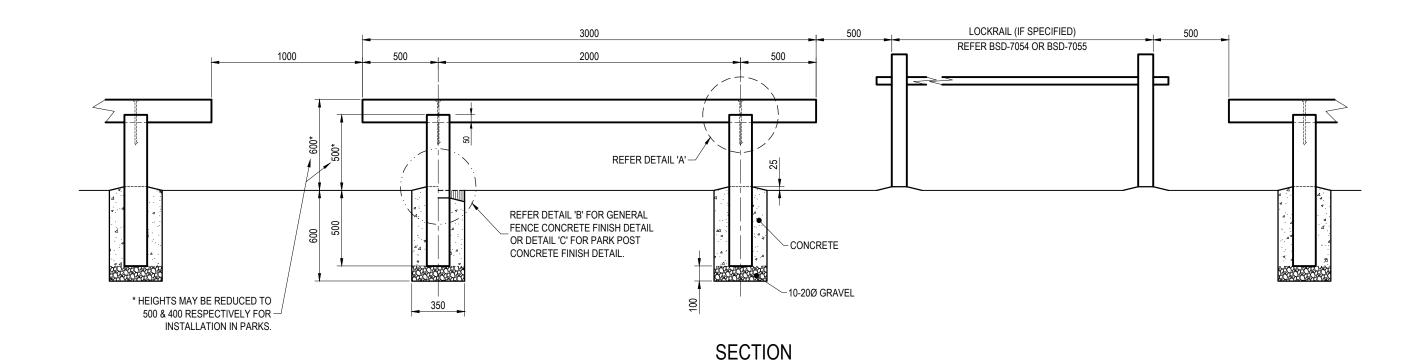

# 10Ø GALVANISED RAILLOC SPIKE (BARBED) CHECK 50 OUT OF RAIL PREDRILLED Ø10 HOLE 270 LONG

DETAIL 'A'

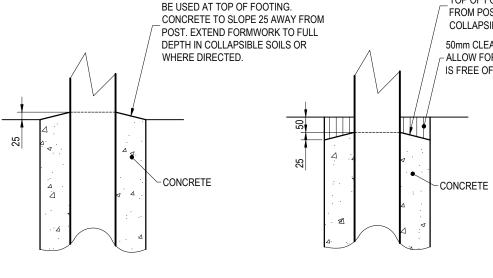

SQUARE OR CIRCULAR FORMWORK TO

DETAIL 'B'

GENERAL FENCE CONCRETE FINISH DETAIL

PARK FENCE CONCRETE FINISH DETAIL

TOP OF FOOTING. CONCRETE TO SLOPE 25 AWAY
FROM POST. EXTEND FORMWORK TO FULL DEPTH IN
COLLAPSIBLE SOILS OR WHERE DIRECTED.

50mm CLEAN TOPSOIL OVER FOOTING TO

SQUARE OR CIRCULAR FORMWORK TO BE USED AT

50mm CLEAN TOPSOIL OVER FOOTING TO - ALLOW FOR GRASS COVER. ENSURE SOIL IS FREE OF ROCKS, STICKS ETC.

#### NOTES:

- 1. ALL CONCRETE TO BE GRADE N25.
- 2. LOG BARRIERS TO BE 150 DIAMETER, 'A' GRADE SUPERLOGS OR EQUIVALENT.
- 3. ALL POSTS AND RAILS TO BE PRESERVATIVE TREATED TO HAZARD CLASS H4 TO AS1604.1 AND HAVE A DURABILITY CLASS 1 OR 2 TO AS5604. ALL POSTS AND RAILS SHALL EITHER BE:
  - CCA TREATED PINE FOR GENERAL USE (e.g. NOT WITHIN PARKS).
  - ACQ TREATED PINE FOR USE WITHIN PARKS.
- PRIOR TO INSTALLATION, ALL CUTS, EDGES, JOINTS TO RECEIVE LIBERAL COATINGS WITH AN APPROVED TIMBER PRESERVATIVE (CELLEVIT OR EQUIVALENT).
- 5. ALL TIMBER TO BE FREE OF KNOTS, SPLINTERS, CRACKS OR ANY MAJOR DEFECT.
- 6. WHERE USED ADJACENT TO OFF-ROAD BICYCLE FACILITIES, REFER TO STANDARD DRAWING BSD-5002.
- 7. FENCE TYPE ONLY TO BE USED ONLY IN SITUATIONS CLEAR OF LONGITUDINAL VEHICLE IMPACT SO AS NOT TO BE A POTENTIAL SPEARING HAZARD TO MOTORISTS.
- 8. IF A CONTINUOUS RAIL IS SPECIFIED, POSTS TO BE SPACED 2000.
- 9. DIMENSIONS IN MILLIMETRES (U.N.O.).

THE FITNESS FOR PURPOSE OF THIS STANDARD DRAWING FOR A SPECIFIC PROJECT SHALL BE ASSESSED AND ACCEPTED BY A SUITABLY QUALIFIED REGISTERED PROFESSIONAL ENGINEER OF QUEENSLAND (RPEQ).

600mm HIGH



BRISBANE CITY COUNCIL STANDARD DRAWING


SCALE

NOT TO SCALE

DRAWING NUMBER

BSD-7012

ORIGINAL SIZE REVISION

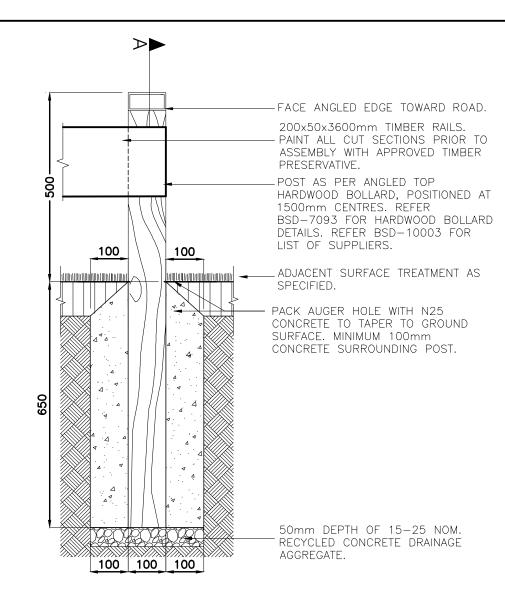

# FOOTING, RAIL & POST — SECTION SCALE 1:10

#### GENERAL NOTES & SPECIFICATIONS


- ENSURE BARRIERS ARE LOCATED IN ACCORDANCE WITH DETAILED LANDSCAPE PLAN AND PARKS CHAPTER OF INFRASTRUCTURE DESIGN PLANNING SCHEME POLICY.
- AUSTRALIAN STANDARDS SHALL BE IN ACCORDANCE WITH THE CURRENT EDITIONS OF THE REFERENCED AUSTRALIAN STANDARDS EXCEPT WHERE VARIED BY SPECIFICATIONS AND/OR DRAWINGS.
- MATERIAL CHOICES ARE TO BE DETERMINED ON THE GROUNDS OF SUSTAINABILITY, LOW MAINTENANCE, VANDAL RESISTANCE, PRODUCT AVAILABILITY AND SUITABILITY TO THE CLIMATIC CONDITIONS WHERE POSSIBLE, MATERIALS ARE TO BE LOCALLY SOURCED.
- ENSURE BOLLARDS & POSTS ARE CLEANED OF CONCRETE SLURRY OR SPRAY WHEN INSTALLED TO PREVENT STAINING OR DAMAGE TO APPLIED FINISHES.
- COLOUR SELECTION IN ACCORDANCE WITH STANDARD BCC CORPORATE COLOUR PALETTE (& AS 2700 EQUIVALENT).
- BARRIERS TO BE IN A STRAIGHT LINE OR AS DIRECTED. LOCATE BARRIERS ON PARK BOUNDARY, OR SET BACK 600mm FROM EDGE OF INTERNAL ROAD, OR AS SHOWN ON PLAN.
- ALL DIMENSIONS IN MILLIMETRES (U.N.O.).


#### CONCRETE WORK NOTES

- ALL WORKMANSHIP AND MATERIAL SHALL BE IN ACCORDANCE WITH AS 3600.
- AT A MINIMUM ALL CONCRETE TO BE GRADE N25. CONCRETE SHALL BE NORMAL CLASS CONCRETE UNLESS DIRECTED OTHERWISE. N25 SHALL MEAN NORMAL CLASS CONCRETE WITH A 28 DAY CHARACTERISTIC STRENGTH OF 25MPa. CONCRETE MIX DESIGN SHALL BE SUBMITTED TO THE SITE SUPERINTENDENT FOR APPROVAL FIVE (5) DAYS PRIOR TO ORDERING.
- ALL CEMENT TO BE TYPE GP OR GB TO AS 3972 UNLESS SPECIFIED OTHERWISE.
- NORMAL AGGREGATE SIZE TO BE 20mm, SLUMP TO BE NOT GREATER THAN 80mm.
- THE BOTTOMS OF ALL FOOTINGS ARE TO BE CLEANED OF ALL LOOSE MATERIAL AND WATER PRIOR TO PLACING CONCRETE.

#### TIMBER WORK NOTES

- TIMBER SHOULD BE SOURCED FROM LEGAL AND SUSTAINABLE SOURCES. TIMBERS ARE CONSIDERED ACCEPTABLE WHERE THERE IS A HIGH DEGREE OF CERTAINTY THAT THEY ARE FROM FORESTS, EITHER NATIVE OR PLANTATION, THAT ARE LEGALLY HARVESTED AND SUSTAINABLY MANAGED. THE CONTRACTOR IS TO SUBMIT EVIDENCE THAT THE TIMBER HAS BEEN OBTAINED FROM A LEGAL AND SUSTAINABLE SOURCE.
- ALL TIMBER TO BE ACQ PRESSURE TREATED OR TANALITH E (COPPER AZOL) TO AS 1608 TREATED ROUGH SAWN APPEARANCE GRADE HARDWOOD OF ONE SPECIES.
- ALL EXPOSED EDGES TO RECEIVE MIN. 5mm WIDE ARRIS.
- PRIOR TO INSTALLATION, ALL CUTS, EDGES, JOINTS TO RECEIVE LIBERAL COATINGS WITH AN APPROVED TIMBER PRESERVATIVE.
- ALL TIMBER IN CONTACT WITH GROUND TO BE PRESERVATIVE TREATED TO HAZARD CLASS H5 TO AS 1604 AND HAVE A DURABILITY CLASS 1 OR 2 TO AS 5604.
- ALL TIMBER TO BE FREE OF KNOTS, SPLINTERS, CRACKS OR ANY MAJOR DEFECT.
- TIMBER PRESERVATIVES WHERE NO FINISH SPECIFIED, ALL TIMBER TO RECEIVE 3 No COATS OF CLEAR APPROVED TIMBER PRESERVATIVE SUCH AS COPPER NAPTHENATE OIL (FOR ABOVE GROUND USE) AND COPPER NAPTHENATE EMULSION (FOR BELOW GROUND USE) — COAT ENTIRE BOLLARD PRIOR TO PLACING.

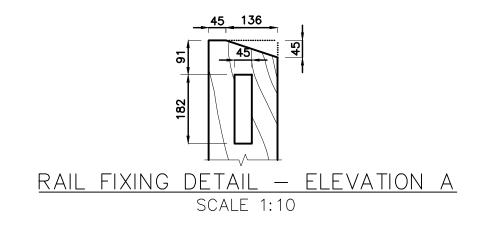

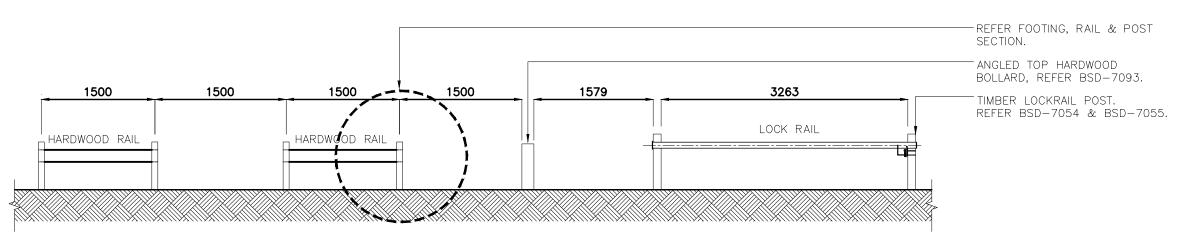

#### <u>HARDWOOD RAIL SETOUT - ELEVATION</u>

SCALE 1:50


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					DRAWING AUTHORISED FOR PUBLICATION PAUL COTTON SIGNATURE ON ORIGINAL DATED	DESIGN	Std Dwgs WG	DATE	OCT '13	Γ
					03/09/04 MANAGER INFRASTRUCTURE MANAGEMENT	DRAWN	CPO - P&D	DATE	OCT '13	
					R.P.E.Q: 2546 DESIGN APPROVED	CHECKED	UMD - E&P & IMB	DATE	OCT '13	
А	Drawing Converted From UMS Series April 2014	APR '14	APR '14	APR '14	LAUREN TEMPLEMAN SIGNATURE ON ORIGINAL DATED 31/08/04	DRAWING FILENAME	BSD-7013 (A) Fence - Parks -	Dressed hard	dwood barrier.dwg	
ISSUE	AMENDMENT	DRAWN DATE	CHK'D DATE	APPR'D DATE	PRICIPAL PROGRAM OFFICER PARKS	ASSOCIATED PLANS	SUPERSEDES UMS-732			
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#### **BRISBANE CITY COUNCIL STANDARD DRAWING**

FENCE — PARKS — DRESSED HARDWOOD BARRIER

AILD		MILLIO
SCALE	AS S	HOWN
BWG No.		
BS	SD-	·7013
ORIGINAL SIZE		REVISION
Α3		А



#### FOOTING, RAIL & POST - SECTION

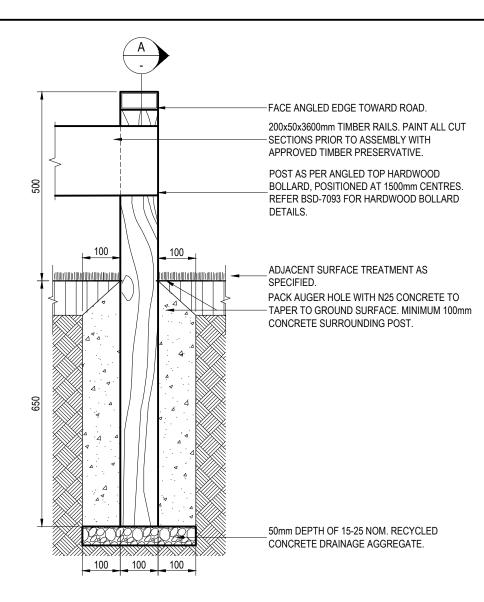**SCALE 1:10** 

#### **GENERAL NOTES & SPECIFICATIONS**


- G1. ENSURE BARRIERS ARE LOCATED IN ACCORDANCE WITH DETAILED LANDSCAPE PLAN AND PARKS CHAPTER OF INFRASTRUCTURE DESIGN PLANNING SCHEME POLICY.
- G2. AUSTRALIAN STANDARDS SHALL BE IN ACCORDANCE WITH THE CURRENT EDITIONS OF THE REFERENCED AUSTRALIAN STANDARDS EXCEPT WHERE VARIED BY SPECIFICATIONS AND/OR DRAWINGS.
- G3. MATERIAL CHOICES ARE TO BE DETERMINED ON THE GROUNDS OF SUSTAINABILITY, LOW MAINTENANCE, VANDAL RESISTANCE, PRODUCT AVAILABILITY AND SUITABILITY TO THE CLIMATIC CONDITIONS WHERE POSSIBLE, MATERIALS ARE TO BE LOCALLY SOURCED.
- G4. ENSURE BOLLARDS & POSTS ARE CLEANED OF CONCRETE SLURRY OR SPRAY WHEN INSTALLED TO PREVENT STAINING OR DAMAGE TO APPLIED FINISHES.
- G5. COLOUR SELECTION IN ACCORDANCE WITH STANDARD BCC CORPORATE COLOUR PALETTE (& AS2700 EQUIVALENT).
- G6. BARRIERS TO BE IN A STRAIGHT LINE OR AS DIRECTED. LOCATE BARRIERS ON PARK BOUNDARY, OR SET BACK 600mm FROM EDGE OF INTERNAL ROAD, OR AS SHOWN ON PLAN.
- G7. ALL DIMENSIONS IN MILLIMETRES (U.N.O.).

#### **CONCRETE WORK NOTES**

- 1. ALL WORKMANSHIP AND MATERIAL SHALL BE IN ACCORDANCE WITH AS 3600.
- C2. AT A MINIMUM ALL CONCRETE TO BE GRADE N25. CONCRETE SHALL BE NORMAL CLASS CONCRETE UNLESS DIRECTED OTHERWISE. N25 SHALL MEAN NORMAL CLASS CONCRETE WITH A 28 DAY CHARACTERISTIC STRENGTH OF 25MPa. CONCRETE MIX DESIGN SHALL BE SUBMITTED TO THE SITE SUPERINTENDENT FOR APPROVAL FIVE (5) DAYS PRIOR TO ORDERING
- C3. ALL CEMENT TO BE TYPE GP OR GB TO AS 3972 UNLESS SPECIFIED OTHERWISE.
- C4. NORMAL AGGREGATE SIZE TO BE 20mm, SLUMP TO BE NOT GREATER THAN 80mm.
- C5. THE BOTTOMS OF ALL FOOTINGS ARE TO BE CLEANED OF ALL LOOSE MATERIAL AND WATER PRIOR TO PLACING CONCRETE.

#### TIMBER WORK NOTES

- 1. TIMBER SHOULD BE SOURCED FROM LEGAL AND SUSTAINABLE SOURCES. TIMBERS ARE CONSIDERED ACCEPTABLE WHERE THERE IS A HIGH DEGREE OF CERTAINTY THAT THEY ARE FROM FORESTS, EITHER NATIVE OR PLANTATION, THAT ARE LEGALLY HARVESTED AND SUSTAINABLY MANAGED. THE CONTRACTOR IS TO SUBMIT EVIDENCE THAT THE TIMBER HAS BEEN OBTAINED FROM A LEGAL AND SUSTAINABLE SOURCE.
- T2. ALL TIMBER TO BE ACQ PRESSURE TREATED OR TANALITH E (COPPER AZOL) TO AS1608 TREATED ROUGH SAWN APPEARANCE GRADE HARDWOOD OF ONE SPECIES.
- T3. ALL EXPOSED EDGES TO RECEIVE MIN. 5mm WIDE ARRIS.
- T4. PRIOR TO INSTALLATION, ALL CUTS, EDGES, JOINTS TO RECEIVE LIBERAL COATINGS WITH AN APPROVED TIMBER PRESERVATIVE.
- T5. ALL TIMBER IN CONTACT WITH GROUND TO BE PRESERVATIVE TREATED TO HAZARD CLASS H5 TO AS1604 AND HAVE A DURABILITY CLASS 1 OR 2 TO AS5604.
- T6. ALL TIMBER TO BE FREE OF KNOTS, SPLINTERS, CRACKS OR ANY MAJOR DEFECT.\
- T7. TIMBER PRESERVATIVES WHERE NO FINISH SPECIFIED, ALL TIMBER TO RECEIVE 3 No COATS OF CLEAR APPROVED TIMBER PRESERVATIVE SUCH AS COPPER NAPTHENATE OIL (FOR ABOVE GROUND USE) AND COPPER NAPTHENATE EMULSION (FOR BELOW GROUND USE) COAT ENTIRE BOLLARD PRIOR TO PLACING.

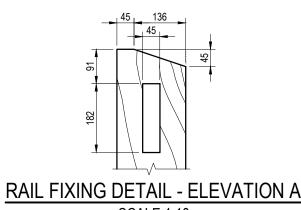

REFER FOOTING, RAIL AND POST SECTION

ANGLED TOP HARDWOOD BOLLARD, REFER BSD-7093.

LOCKRAIL WITH TIMBER POSTS, REFER BSD-7055.

# HARDWOOD RAIL SETOUT - ELEVATION SCALE 1:50

ERISBANE CITY

BRISBANE CITY COUNCIL STANDARD DRAWING


FENCE - PARKS
DRESSED HARDWOOD BARRIER


PUBLISH DATE
March 2021

SCALE
AS SHOWN
DRAWING NUMBER

BSD-7013

ORIGINAL SIZE
A3
B

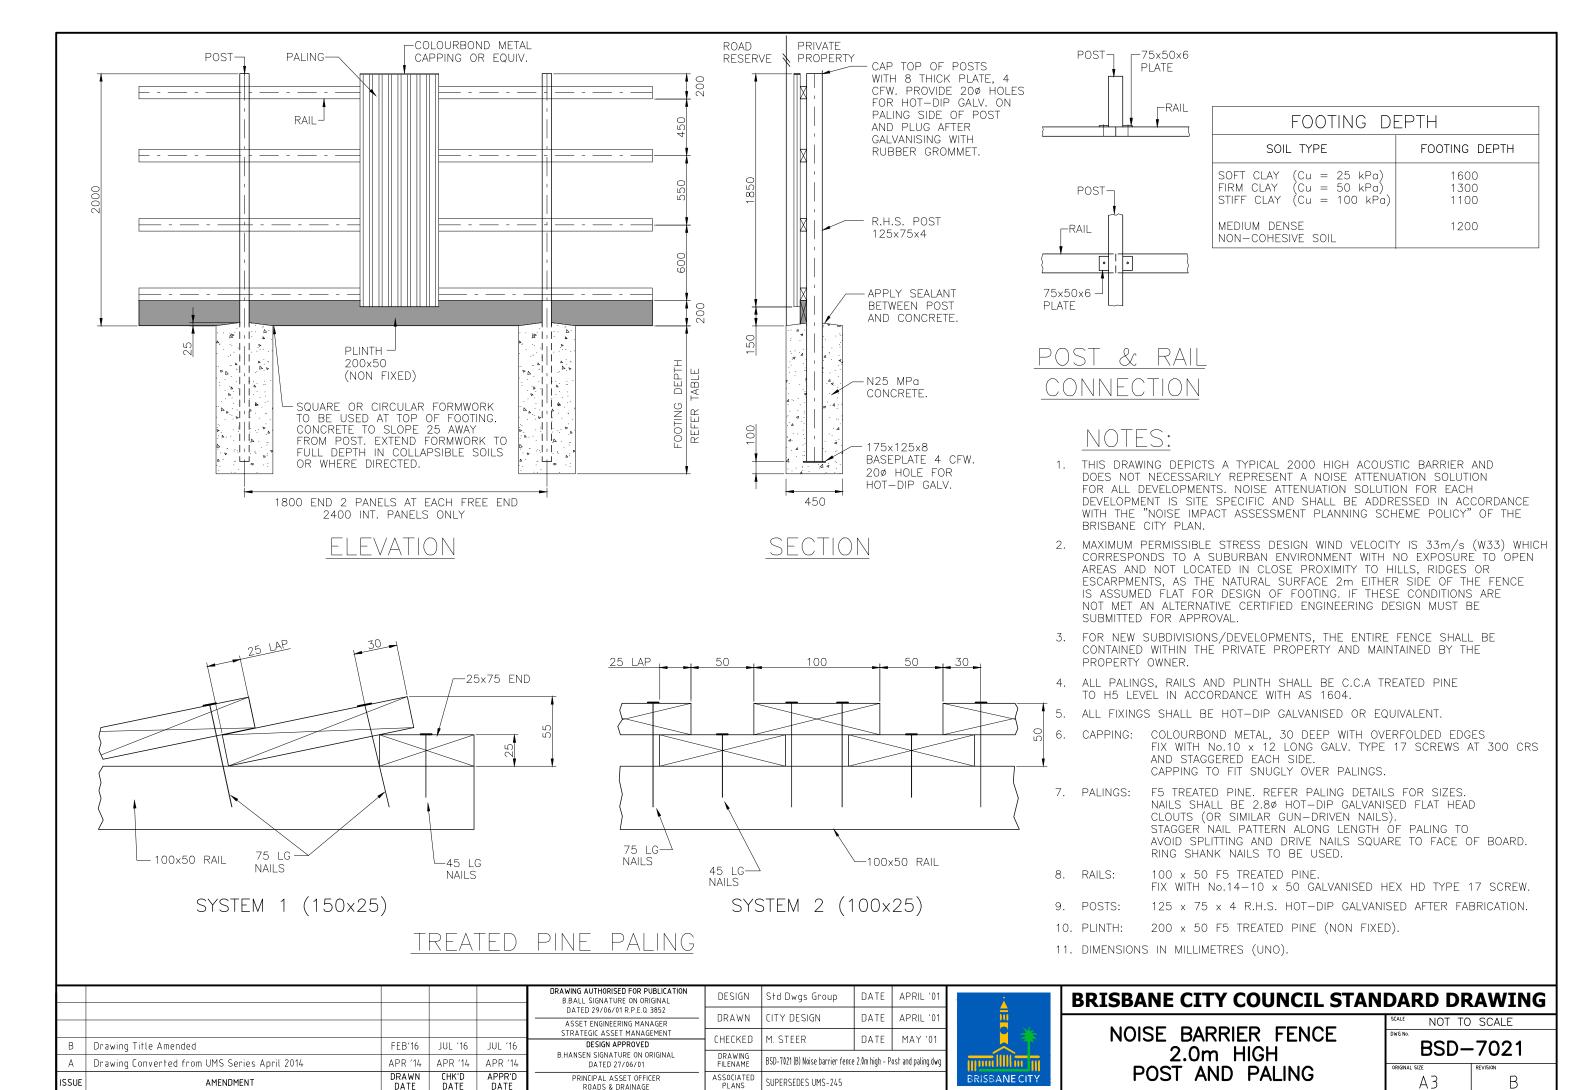

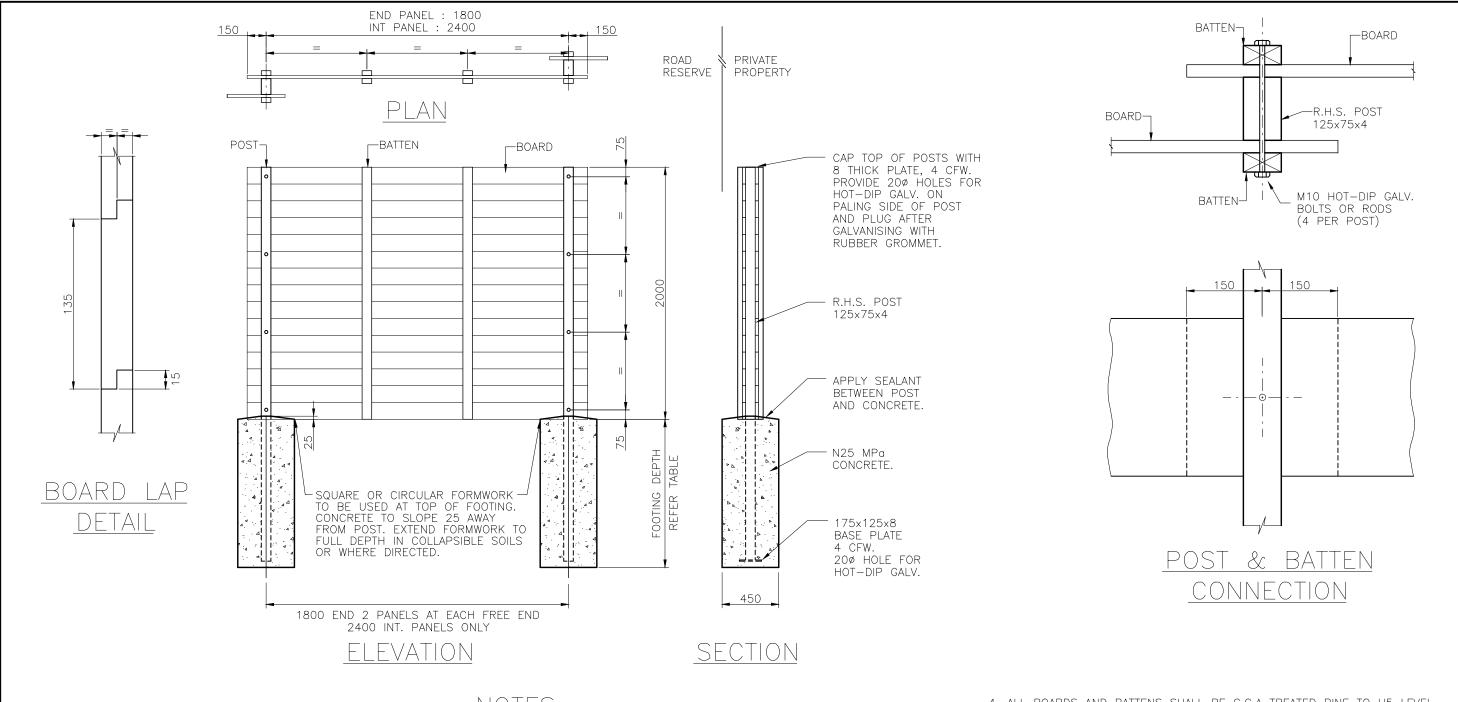

#### NOTES:

- FOOTING DEPTH

  SOIL TYPE

  FOOTING DEPTH

  SOFT CLAY (Cu = 25kPa) 1600
  FIRM CLAY (Cu = 50 kPa) 1300
  STIFF CLAY (Cu = 100 kPa) 1100

  MEDIUM DENSE 1200
  NON-COHESIVE SOIL
- 1. THIS DRAWING DEPICTS A TYPICAL 2000 HIGH ACOUSTIC BARRIER AND DOES NOT NECESSARILY REPRESENT A NOISE ATTENUATION SOLUTION FOR ALL DEVELOPMENTS. NOISE ATTENUATION SOLUTION FOR EACH DEVELOPMENT IS SITE SPECIFIC AND SHALL BE ADDRESSED IN ACCORDANCE WITH THE "NOISE IMPACT ASSESSMENT PLANNING SCHEME POLICY" OF THE BRISBANE CITY PLAN.
- 2. MAXIMUM PERMISSIBLE STRESS DESIGN WIND VELOCITY IS 33m/s (W33) WHICH CORRESPONDS TO A SUBURBAN ENVIRONMENT WITH NO EXPOSURE TO OPEN AREAS AND NOT LOCATED IN CLOSE PROXIMITY TO HILLS, RIDGES OR ESCARPMENTS, AS THE NATURAL SURFACE 2m EITHER SIDE OF THE FENCE IS ASSUMED FLAT FOR DESIGN OF FOOTING. IF THESE CONDITIONS ARE NOT MET AN ALTERNATIVE CERTIFIED ENGINEERING DESIGN MUST BE SUBMITTED FOR APPROVAL.
- 3. FOR NEW SUBDIVISIONS/DEVELOPMENTS, THE ENTIRE FENCE MUST BE CONTAINED WITHIN THE PRIVATE PROPERTY AND MAINTAINED BY THE PROPERTY OWNER.

- 4. ALL BOARDS AND BATTENS SHALL BE C.C.A TREATED PINE TO H5 LEVEL IN ACCORDANCE WITH AS 1604.
- 5. ALL FIXINGS SHALL BE HOT-DIP GALVANISED OR EQUIVALENT.
- 6. BOARDS: 150 x 25 ROUGH SAWN F5 TREATED PINE SIZED AND REBATED AS PER BOARD LAP DETAIL. ALL BOARDS TO BE FULL LENGTH.
- 7. BATTENS: 75 x 38 ROUGH SAWN F5 TREATED PINE FIXED;

  \*AT POST WITH 4 M10 HOT-DIP GALVANISED BOLTS OR RODS

  \*TO BOARDS ELSEWHERE WITH 2.8ø x 75 LONG GALVANISED CLOUTS

  (OR SIMILAR GUN-DRIVEN NAILS) AT TOP AND BOTTOM

  AND EVERY SECOND BOARD (300 CRS) BOTH SIDES.

  DRIVE NAILS SQUARE TO FACE OF BATTENS.

RING SHANK NAILS TO BE USED.

- 8. POSTS: 125 x 75 x 4 R.H.S. HOT-DIP GALVANISED AFTER FABRICATION. FOR POST AND BATTEN CONNECTION REFER TO DETAIL ABOVE.
- 9. DIMENSIONS IN MILLIMETRES (UNO).

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٨	Drawing Converted from UMS Series April 2014	APR '14	APR '14	APR '14	B. HANSEN SIGNATURE ON ORIGINAL DATED 27/06/01	DRAWING FILENAME	BSD-7022 (B) Noise barrier fenc	e 2.0m hiah – P	ost and board.dwg
В	Drawing Title Amended	FEB'16	JUL '16	JUL '16	DESIGN APPROVED		M. STEER	DATE	MAY '01
					STRATEGIC ASSET MANAGEMENT	CHECKED	M CTEED	DATE	M A V / / 0.4
					ASSET ENGINEERING MANAGER	DRAWN	CITY DESIGN	DATE	APRIL '01
					DRAWING AUTHORISED FOR PUBLICATION  B.B.ALL SIGNATURE ON ORIGINAL  DATED 29/06/01 R.P.E.Q: 3582	DESIGN	Std Dwgs Group	DATE	APRIL '01



#### **BRISBANE CITY COUNCIL STANDARD DRAWING**

NOISE BARRIER FENCE 2.0m HIGH POST AND BOARD

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	SCALE	NOT	TO	SCAL	.E
	DWG No.				
		BSD	<b>)</b> —	701	77
			,	, 02	
	ORIGINAL	SIZE		REVISION	
		Α3			В

#### **GENERAL NOTES & SPECIFICATIONS**

- G1. ENSURE DOG OFF LEASH GATES ARE LOCATED IN ACCORDANCE WITH PARKS CHAPTER OF INFRASTRUCTURE DESIGN PLANNING SCHEME POLICY.
- G2. AUSTRALIAN STANDARDS SHALL BE IN ACCORDANCE WITH THE CURRENT EDITIONS OF THE REFERENCED AUSTRALIAN STANDARDS EXCEPT WHERE VARIED BY SPECIFICATIONS AND/OR DRAWINGS.
- G3. ENSURE DOG OFF LEASH GATES ARE CLEANED OF CONCRETE SLURRY OR SPRAY WHEN INSTALLED TO PREVENT STAINING OR DAMAGE TO APPLIED FINISHES
- G4. COLOUR SELECTION IN ACCORDANCE WITH STANDARD BCC CORPORATE COLOUR PALETTE. "BCC GREY 3" (AS2700. "N65 GRAPHITE GREY" EQUIVALENT).
- G5. ALL DIMENSIONS IN MILLIMETRES (U.N.O.).
- G6. FOR FENCING DETAILS REFER BSD-7007.
- G7. ALL CHAINWIRE AND TIE WIRE (BOTH MARINE AND NON-MARINE APPLICATIONS) TO BE PVC COATED.
- G8. ALL POSTS ARE TO BE CONCRETED INTO GROUND 300mmx600mm DEEP.
- G9. MAX. GAP OF 50mm UNDER ALL GATES.
- G10. STANDARD IS NOT FOR USE IN A MARINE ENVIRONMENT. THE MARINE ENVIRONMENT COULD EXTEND UP TO 1 km FROM THE FORESHORE. FOR NON-MARINE ENVIRONMENT, SUPPLY AND INSTALL 1200mm HIGH GALVANISED FENCE POST WITH TOP AND BOTTOM RAIL. ALL POSTS, RAILS AND FITTINGS TO BE GALVANISED STEEL TUBE TO AS 1163 THEN POWDER COATED.
- G11. WHERE STANDARD IS REQUIRED FOR USE WITH MARINE ENVIRONMENT, THE FOLLOWING PROTECTION TREATMENT FOR STEELWORK IS REQUIRED:
  - HOT DIP GALVANISING: 85 MICRONS (600g/m²) MIN.
  - SWEEP ABRASIVE BLAST.
  - FIRST COAT: EPOXY PRIMER 75 MICRONS MIN.
  - SECOND COAT: TWO PACK ACRYLIC OR POLYURETHANE GLOSS 75 MICRONS MIN.
- G12. SINGLE GATE SUPPLY AND INSTALL ONE 1200mm HIGH x 1000mm WIDE ALL PIPE TO BE MEDIUM GALVANISED THEN POWDER COATED SINGLE LEAF GATE. GATE TO BE SELF-CLOSING. FITTINGS TO BE BOLTED TO POSTS. INCLUDES TWO POWDER COATED GATE POSTS. GATES TO INCLUDE 'D' LATCH.
- G13. DOUBLE GATE SUPPLY AND INSTALL ON 1200mm HIGH x 4000mm WIDE ALL PIPE TO BE MEDIUM GALVANISED THEN POWDER COATED DOUBLE LEAF GATE. INCLUDES TWO POWDER COATED GATE POSTS CHAIN TO BE ATTACHED TO GATE TO ALLOW LOCKING OF DOUBLE GATES WITH PADLOCK (BCC SUPPLIED AND INSTALLED CONTACT BCC ASSET SERVICES, REFER BSD-10003 FOR CONTACT DETAILS). GATES TO BE JOINED BY LOOP LATCH.

#### G14. OTHER SPECIFICATIONS:

- GATE POSTS (CAPPED) 50NB (60.3 OD, 3.6 THICK).
- GATE FRAME/BRACE 25NB.
- CHAINWIRE 50mm NOMINAL MESH WITH 2.5mm PVC COATED WIRE.
- CABLES & STRINGERS PVC COATED 3.15mm
- G15. FOR REFUSE BIN AND LOCKABLE STAND REQUIREMENTS, CONTACT TO WASTE AND RESOURCE RECOVERY SERVICES ON 07 3403 8888.
- G16. ALL DIMENSIONS IN MILLIMETRES (U.N.O.).

#### FIXTURES/FITTINGS & METAL WORK NOTES

- F1. ALL WORKMANSHIP AND MATERIAL SHALL BE IN ACCORDANCE WITH AS4100 & AS/NZS1554.
- F2. ALL METAL FINISHES TO BE IN ACCORDANCE WITH AS4506.
- F3. ALL FIXTURES/FITTINGS UNLESS SPECIFIED ARE TO BE HOT DIPPED GALVANISED. IN VICINITY OF SALTWATER/SPRAY, ENSURE ALL FASTENERS ARE STAINLESS STEEL. PLASTIC SEPARATORS SHALL BE PROVIDED TO AVOID CONTACT BETWEEN DISSIMILAR MATERIALS. STAINLESS STEEL GRADE 316 TO BE USED. WHERE POSSIBLE ALL FIXINGS TO BE TAMPER/VANDAL PROOF TO MINIMISE DAMAGE OR THEFT.
- F4. ALL WELDS TO BE CONTINUOUS FILLET WELDS, GROUND OFF SMOOTH & FLUSH IN ACCORDANCE WITH AS1554. GRIND SMOOTH EDGES & WELDS PRIOR TO HOT DIPPED GALVANISING OR APPLIED FINISHES.

#### CONCRETE WORK NOTES

- C1. ALL WORKMANSHIP AND MATERIAL SHALL BE IN ACCORDANCE WITH AS 3600.
- C2. AT A MINIMUM ALL CONCRETE TO BE GRADE N25. CONCRETE SHALL BE NORMAL CLASS CONCRETE UNLESS DIRECTED OTHERWISE. N25 SHALL MEAN NORMAL CLASS CONCRETE WITH A 28 DAY CHARACTERISTIC STRENGTH OF 25MPa. CONCRETE MIX DESIGN SHALL BE SUBMITTED TO THE SITE SUPERINTENDENT FOR APPROVAL FIVE (5) DAYS PRIOR TO ORDERING.
- C3. ALL CEMENT TO BE TYPE GP OR GB TO AS 3972 UNLESS SPECIFIED OTHERWISE.
- C4. NORMAL AGGREGATE SIZE TO BE 20mm, SLUMP TO BE NOT GREATER THAN 80mm.
- C5. THE BOTTOMS OF ALL FOOTINGS ARE TO BE CLEANED OF ALL LOOSE MATERIAL AND WATER PRIOR TO PLACING CONCRETE.

#### **CONCRETE WORK NOTES**

- C1. ALL WORKMANSHIP AND MATERIAL SHALL BE IN ACCORDANCE WITH AS 3600.
- C2. AT A MINIMUM ALL CONCRETE TO BE GRADE N25. CONCRETE SHALL BE NORMAL CLASS CONCRETE UNLESS DIRECTED OTHERWISE. N25 SHALL MEAN NORMAL CLASS CONCRETE WITH A 28 DAY CHARACTERISTIC STRENGTH OF 25MPa. CONCRETE MIX DESIGN SHALL BE SUBMITTED TO THE SITE SUPERINTENDENT FOR APPROVAL FIVE (5) DAYS PRIOR TO OPDERING.
- C3. ALL CEMENT TO BE TYPE GP OR GB TO AS 3972 UNLESS SPECIFIED OTHERWISE.
- C4. NORMAL AGGREGATE SIZE TO BE 20mm, SLUMP TO BE NOT GREATER THAN 80mm.
- C5. THE BOTTOMS OF ALL FOOTINGS ARE TO BE CLEANED OF ALL LOOSE MATERIAL AND WATER PRIOR TO PLACING CONCRETE.

REFER TO BSD-7032 SHEET 2 OF 2 FOR ASSOCIATED DETAILS.

THE PURPOSE OF THIS STANDARD DRAWING IS TO PROVIDE TYPICAL DETAILS THAT SUPPORT THE DESIRED OUTCOMES OF THE BRISBANE CITY PLAN 2014 AND ASSOCIATED PLANNING SCHEME POLICIES. THE FITNESS FOR PURPOSE OF THIS STANDARD DRAWING FOR A SPECIFIC PROJECT SHOULD BE ASSESSED AND ACCEPTED BY AN APPROPRIATELY QUALIFIED DESIGNER AND/OR REGISTERED PROFESSIONAL ENGINEER OF QUEENSLAND (RPEQ).



BRISBANE CITY COUNCIL STANDARD DRAWING

GATES
DOG OFF LEASH AREA - GENERAL NOTES
SHEET 1 OF 2

JUN 2023

SCALE


AS SHOWN

DRAWING NUMBER

BSD-7032

D

ORIGINAL SIZE REVISION

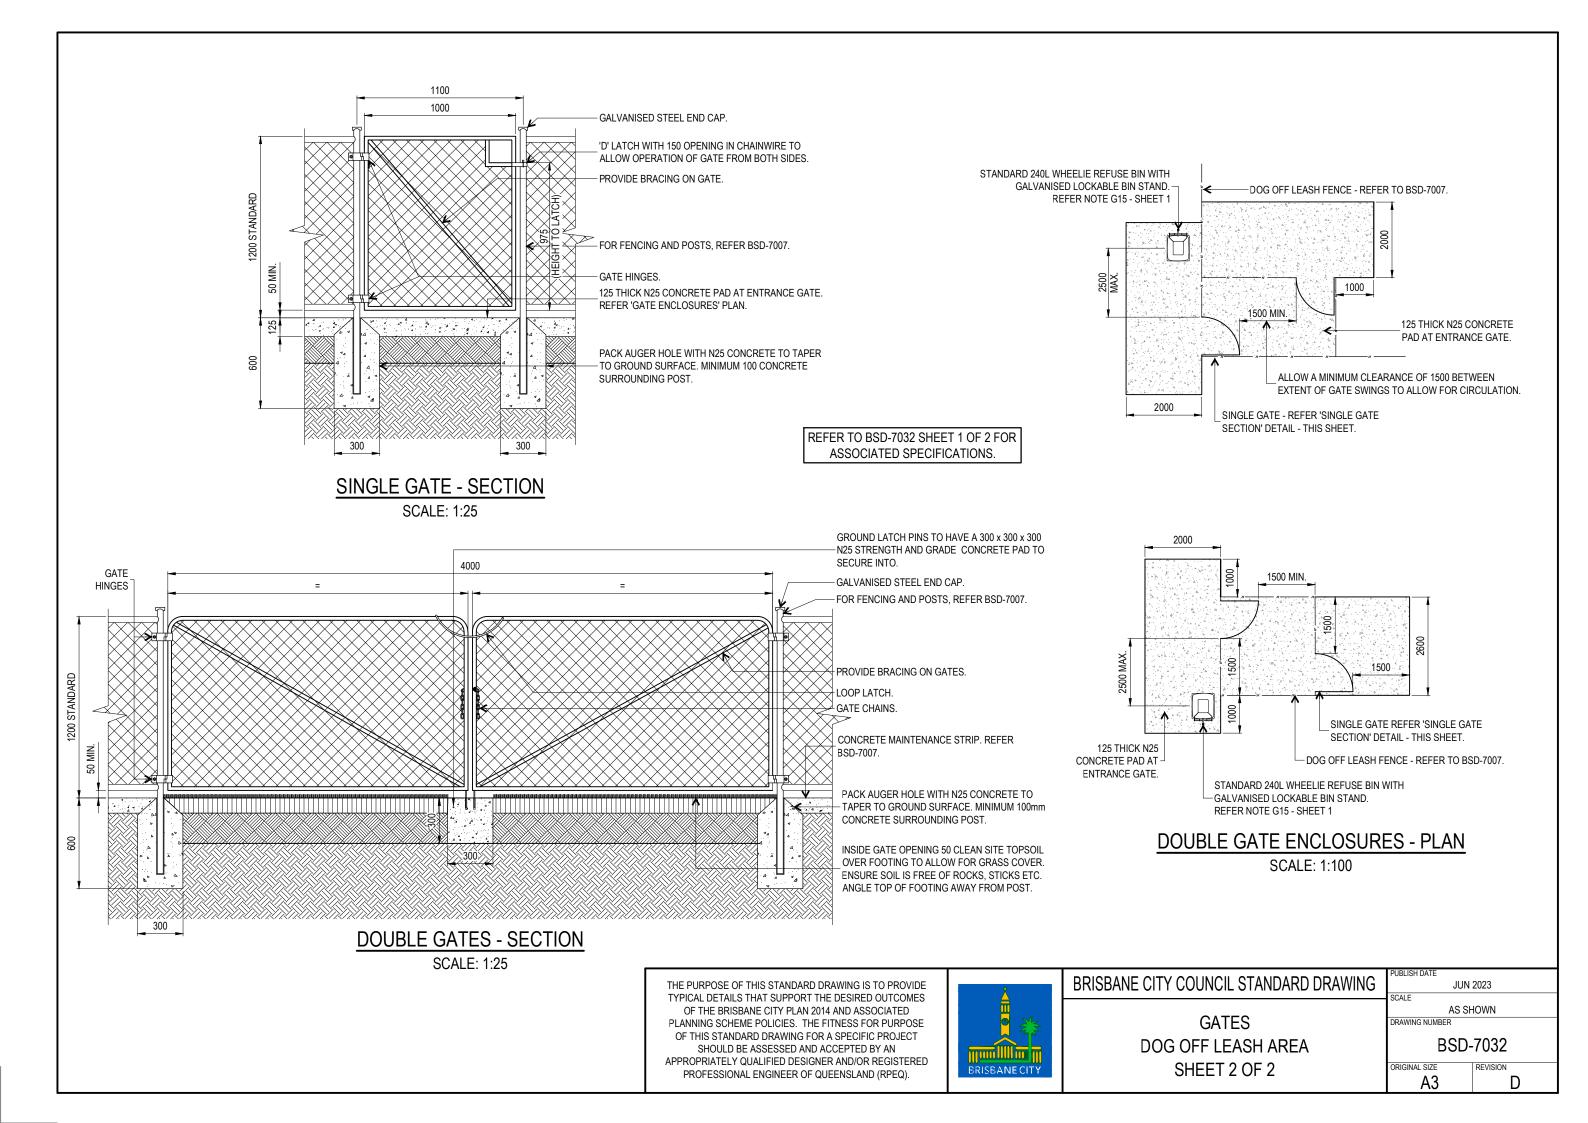

#### GENERAL NOTES:

- G1 THE BUILDER SHALL BE RESPONSIBLE FOR MAINTAINING STABILITY OF THE STRUCTURE UNTIL COMPLETION OF CONSTRUCTION AND SHALL ENSURE THAT NO PART OF THE STRUCTURE IS OVERSTRESSED.
- G2 THE BUILDER SHALL CHECK ALL DIMENSIONS AND ALL EXISTING CONDITIONS BEFORE COMMENCING CONSTRUCTION.
- G3 ANY DAMAGE CAUSED BY THE CONTRACTOR SHALL BE MADE GOOD AT THEIR OWN COST.
- G4 ALL MATERIALS AND WORKMANSHIP SHALL BE IN ACCORDANCE WITH THE CURRENT EDITIONS OF THE FOLLOWING AUSTRALIAN STANDARDS, EXCEPT WHERE VARIED BY THE SPECIFICATIONS AND/OR DRAWINGS: —

AS 1684.2(2010) RESIDENTIAL TIMBER FRAMED CONSTRUCTION

AS 1720.1(2010) TIMBER STRUCTURES

AS 2870(2011) RESIDENTIAL SLABS AND FOOTINGS

AS 3600 CONCRETE STRUCTURES

AS 3798 GUIDELINES ON EARTHWORKS FOR COMMERCIAL AND RESIDENTIAL DEVELOPMENTS

AS 4100 STEEL STRUCTURES

- G5 DIMENSIONS SHALL NOT BE OBTAINED BY SCALING THE STRUCTURAL DRAWINGS.
- G6 ALL DIMENSIONS ARE IN MILLIMETRES UNLESS NOTED OTHERWISE U.N.O.

G7 U.N.O. DENOTES UNLESS NOTED OTHERWISE.

- THE CONTRACTOR SHALL VISIT THE SITE PRIOR TO TENDERING TO FAMILIARISE THEMSELVES WITH ACCESS SITE CONDITIONS
- G9 THE CONTRACTOR MAY OFFER FOR CONSIDERATION ALTERNATIVE PROVEN EQUAL PRODUCTS TO THOSE INDICATED. ALTERNATIVE PRODUCTS ARE NOT TO ADVERSELY AFFECT THE PROJECT AND CANNOT BE SUBSTITUTED WITHOUT PRIOR APPROVAL.
- G10 EXISTING SERVICES TO BE LOCATED BEFORE CONSTRUCTION COMMENCES. G11 THE DETAILS OF BUSHFIRE WATER SUPPLY SHELTER INCLUDED IN
- DRAWING SHEETS 1 TO 4.
- G12 CONSULT BCC ARCHITECTS FOR COLOUR SCHEME OF THE STRUCTURE.

#### DESIGN CRITERIA:

WIND LOADS : REGION B TERRAIN CATEGORY 1.5

ULTIMATE WIND SPEED = 54.0 m/s

SHELTER IS DESIGNED FOR THE CONDITION "BLOCKED UNDER"

ACCORDING TO AS 1170.2 (2011)
DESIGN LIFE : 50 YEARS WITH ROUTINE MAINTENANCE

LIVE LOADS: : FLOOR = 5.0 kPa. ROOF = 0.25 kPa / 1.4 kN.

STRUCTURE IS DESIGNED TO REMAIN OPEN — NO SCREENS(IMPERMEABLE OR PERMEABLE BARRIERS) TO BE INSTALLED. TERRAIN CATEGORY 1.5 CORRESPONDS TO AN ENVIRONMENT WITH OPEN WATER SURFACES SUBJECTED TO SHOALING WAVES AT SERVICEABILITY AND ULTIMATE WIND SPEEDS.

#### FOUNDATIONS AND SLAB ON GROUND:

- F1 ALL FOOTINGS ARE TO BE FOUNDED IN THE NATURAL UNDISTURBED SOIL PROFILE WITH A MINIMUM ALLOWABLE SOIL BEARING CAPACITY OF 100kPa UNLESS NOTED OTHERWISE. IF SITE CONDITION IS DIFFERENT, CONSULT A STRUCTURAL ENGINEER
- F2 SOIL TEST IS REQUIRED TO CONFIRM BEARING CAPACITY AND SITE CLASSIFICATION TO AS 2870.
- F3 FOUNDATIONS ARE TO BE CHECKED AND CERTIFIED BY A REGISTERED PROFESSIONAL GEOTECHNICAL ENGINEER, QUEENSLAND (RPEQ).
- F4 COMPACT AND PREPARE THE BASE TO PROVIDE A SOUND PLATFORM AND ANY ORGANIC, SOFT OR LOOSE MATERIALS REMOVED AND REPLACED WITH COMPACTED FILL BCC SPECIFICATION S300 QUARRY PRODUCT CLASS I MATERIAL
- F5 FOR CONTROL JOINT LOCATIONS, REFER TO DRAWINGS.
- F6 SLABS ON GRADE SHALL BE UNDERLAIN WITH CONTINUOUS LAYER OF 200 MICRON (0.2mm) THICK POLYETHYLENE DAMPPROOF MEMBRANE AS PER AS 2870, LAPPED AND TAPED TO MANUFACTURER'S SPECIFICATION.

#### **EARTHWORKS:**

- E1 STRIP ALL HUMUS MATERIAL FROM THE AREA OF THE BUILDING IMPRINT AND 1000 BEYOND.
- E2 PROOF ROLL THE AREAS TO BE CONCRETED AND PAVED. REMOVE ANY WEAK MATERIAL.
- E3 COMPACTED FILL SHALL BE COMPACTED IN LAYERS NOT EXCEEDING 150mm LOOSE DEPTH TO 98% MAXIMUM DRY DENSITY IN ACCORDANCE WITH AS1289. 5.1.1 (STANDARD COMPACTION). CARRY OUT DENSITY TESTS AT A RATE OF 2 PER LEVEL OF FILL. EVERY TEST MUST PASS.

#### TIMBER NOTES:

- T1 ALL WORKMANSHIP AND MATERIAL SHALL BE IN ACCORDANCE WITH AS 1720 AND AS 1684.
- T2 TIMBER GRADES SHALL BE AS SHOWN ON THE DRAWINGS. ALL TIMBER TO BE SEASONED OR KILN DRIED GRADE MGP12 MINIMUM U.N.O WITH NATURAL DURABILITY CLASS 4 (ABOVE GROUND) OR BETTER.
- T3 ALL FASTENERS SHALL BE HOT DIP GALVANISÉD. BOLTS TO BE METRIC HEX-HEAD M16 MINIMUM WITH WASHERS U.N.O. CLEAT PLATES TO BE 10mm THICK U.N.O.

T4 TIMBER JOINT GROUP JD4 OR BETTER.

- T5 ALL TIMBER SHALL BE FULLY DRESSED AND ALL EDGES, ENDS AND CORNERS TO BE 6mm DRESSED.
- T6 PROTECT ENDS OF EXPOSED MEMBERS. USE A HIGH QUALITY EXTERIOR PAINT OR OIL FINISH.
- T7 ALL TIMBER FRAMING SHALL BE NATURALLY TERMITE RESISTANT OR TREATED USING LOSP OR ACQ CHEMICALS TO A HAZARD RESISTANCE LEVEL H3 IN ACCORDANCE WITH AS 1684.2 APPENDIX B.
- T8 ALL TIMBER TO BE OILED OR PAINTED PRIOR TO FIXING INTO FINAL POSITION. REFER TO PROJECT SPECIFICATION FOR EACH PROJECT.

#### CONCRETE NOTES:

- C1 ALL WORKMANSHIP AND MATERIAL SHALL BE IN ACCORDANCE WITH AS 3600.
- C2 ALL CONCRETE SHALL BE PREMIXED BY AN APPROVED SUPPLIER.

C3 ALL CEMENT SHALL BE TYPE GP OR GB.

MESH

- C4 CONCRETE SPECIFICATION: NOMINAL AGGREGATE SIZE TO BE 20mm, SLUMP TO BE NOT GREATER THAN 80mm.
- C5 CONCRETE STRENGTH AND CLEAR CONCRETE COVER TO REINFORCEMENT SHALL BE IN ACCORDANCE WITH THE FOLLOWING TABLE

U.N.O. ELEMENT: F'C (MPa) REINFORCEMENT COVER
PIERS 25 75 MIN.
SLAB 25 50 MIN.

6 ALL LAPS IN REINFORCEMENT SHALL BE AS SHOWN IN THE TABLE BELOW UNLESS NOTED OTHERWISE.

BAR LAP LENGTH (mm) N12 500 N16 650

C7 REINFORCEMENT SYMBOLS:

- R STRUCTURAL PLAIN ROUND GRADE 250R TO AS 4671.
  - N DEFORMED BAR GRADE D500N TO AS 4671.

350

- SL HARD DRAWN STEEL REINFORCING FABRIC GRADE D500L TO AS 4671.
- C8 SIZES OF CONCRETE ELEMENTS DO NOT INCLUDE THICKNESS OF APPLIED FINISHES.
- C9 NO HOLES, CHASES OR EMBEDMENT OF PIPES OTHER THAN THOSE SHOWN ON THE STRUCTURAL DRAWINGS SHALL BE MADE IN CONCRETE MEMBERS WITHOUT PRIOR APPROVAL BY THE SUPERINTENDENT.
- C10 ALL CONCRETE SHALL BE COMPACTED USING A MECHANICAL VIBRATION PROCESS.
- C11 ALL REINFORCEMENT SHALL BE SECURELY SUPPORTED IN ITS CORRECT POSITION DURING CONCRETING BY APPROVED BAR CHAIRS, SPACERS OR SUPPORT BARS.
- C12 CONSTRUCTION JOINTS SHALL BE PROPERLY FORMED AND USED ONLY WHERE SHOWN OR SPECIFICALLY APPROVED BY THE SUPERINTENDENT.

#### STEELWORK NOTES

- S1. ALL WORKMANSHIP & MATERIALS SHALL BE IN ACCORDANCE WITH AS4100 & AS/NZS1554.
- S2. ALL STEEL SHALL BE IN ACCORDANCE WITH:

  AS1163 GRADE C350LO FOR RECTANGULAR AND SQUARE HOLLOW SECTIONS
  UNO
- S3. ALL BOLTS TO BE METRIC HEXAGONAL TO AS 1252 U.N.O. ALL BOLTS TO BE M16 4.6/S TO AS/NZS 1252 U.N.O. ALL BOLTS TO BE HOT DIP GALVANISED TO AS 1214 U.N.O.
- S4. ALL CLEATS AND GUSSETS SHALL BE 10mm PLATE TO AS/NZS3678 GRADE 250 U.N.O.
- S5. METAL ROOF CLADDING TO BE 0.42 BMT LYSAGHT CUSTOM ORB WITH A COLORBOND FINISH OR APPROVED EQUAL FIXED AS PER MANUFACTURER'S SPECIFICATIONS COLORBOND COLOUR AS PER SPECIFICATION.
- S6. ALL WELDS TO BE 6mm CONTINUOUS FILLET WELDS (CFW) STRUCTURAL PURPOSE (SP) WELDS U.N.O. ALL WELDS TO BE MADE USING E48XX OR W50X GRADE 1 (OR BETTER) ELECTRODES TO AS/NZS 1554. GRIND ALL CORNERS & WELDS SMOOTH.
- S7. ALL STEELWORK TO BE HOT DIP GALVANISED IN ACCORDANCE WITH AS/NZS 2312 HDG600 SPECIFICATION. SURFACE PREPARATION FOR CORROSION PROTECTION COATING IS TO BE CLASS 2½ TO AS 1627 AND PICKLED PRIOR GALVANISING. HOT DIPPED GALVANISED COATING SHALL BE IN ACCORDANCE WITH AS/NZS 4680.
- S8. ANY POST GALVANISING DAMAGE TO BE MADE GOOD WITH HIGH QUALITY
  TWO PACK EPOXY ZINC RICH PAINT CONFORMING TO AS/NZS 3750.9 WITH
  A MINIMUM DRY FILM THICKNESS OF 100 MICRONS. SURFACE PREPARATION
  TO BE ACCORDING TO PAINT MANUFACTURER'S RECOMMENDATIONS.
- S9. THE ENDS OF ALL TUBULAR OR HOLLOW MEMBERS ARE TO BE SEALED WITH 6mm THICK PLATES AND CONTINUOUS FILLET WELDED U.N.O.
- S10. PROTECTIVE COATINGS TO BE APPLIED AFTER ALL FABRICATION COMPLETED. NO WELDING ETC TO BE CARRIED OUT DURING OR AFTER APPLICATION OF COATING SYSTEM.
- S11. THE PRINCIPAL CONTRACTOR SHALL CONFER WITH THE FABRICATOR AND GALVANISER TO ENSURE VENT HOLES ARE PROVIDED IN ACCORDANCE WITH AS/NZS 4680.

#### INSPECTION AND CERTIFICATION NOTES:

A1 THE CONTRACTOR'S ENGINEER (RPEQ) SHALL UNDERTAKE INSPECTIONS DURING CONSTRUCTION TO ENSURE ALL CONSTRUCTION WORKS ARE IN ACCORDANCE WITH THE MOST CURRENT ISSUE OF THE STRUCTURAL DRAWINGS AND THE CONTRACT DOCUMENT. THE RPEQ SHALL CERTIFY ALL CONSTRUCTION WORK (FORM 16). ANY ALTERNATIVE TECHNIQUE USED IN CONSTRUCTION SHALL BE FOLLOWED BY A DESIGN CERTIFICATE (FORM 15) BY THE CONTRACTOR'S PROFESSIONAL ENGINEER (RPEQ)

ISSUE	AMENDMENT	DRAWN DATE	CHK'D DATE	APPR'D DATE	S
А	ORIGINAL ISSUE	DEC '14	DEC '14	DEC '14	
В	Drawing Title Amended	FEB '16	JUL '16	JUL '16	
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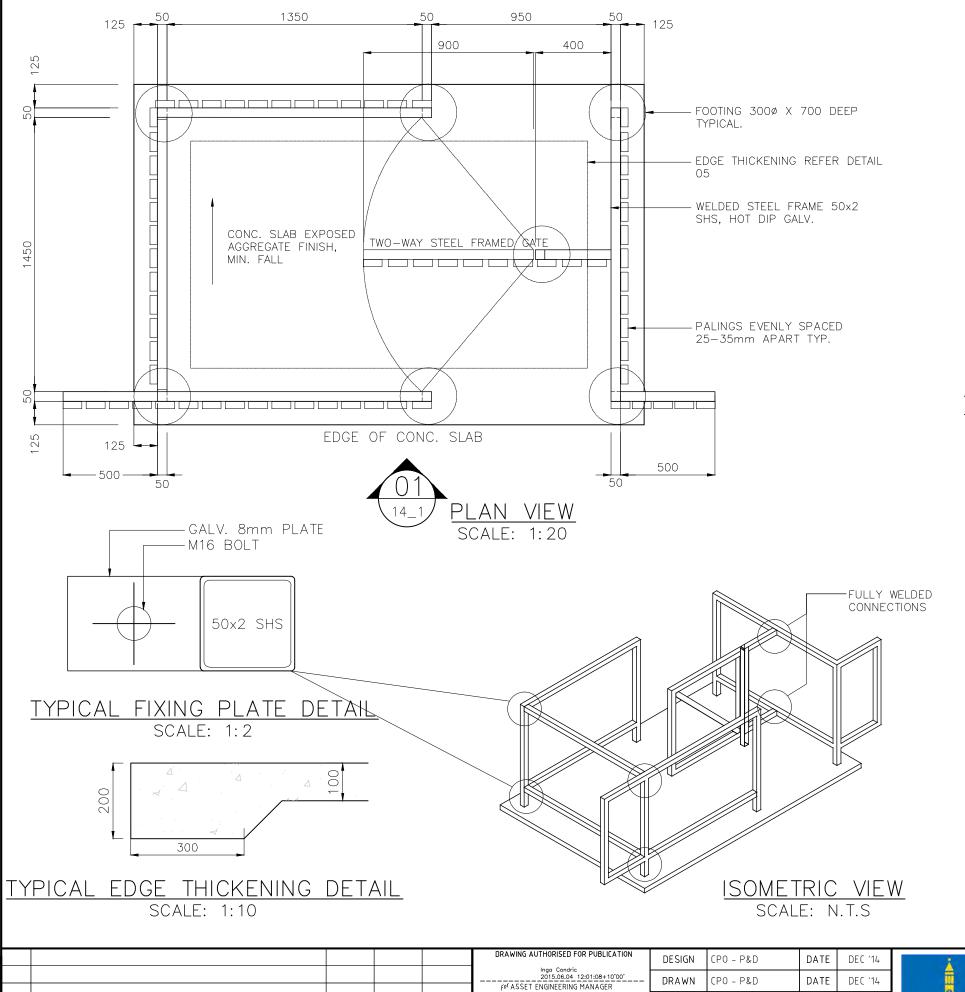
DRAWING AUTHORISED FOR PUBLICATION CPO - P&D DATE DESIGN DEC '14 Inga Condric 2015.06.04 11:53:10 +10'00' DRAWN CPO - P&D DATE DEC '14 FOT ASSET ENGINEERING MANAGER STRATEGIC ASSET MANAGEMENT CHECKED BI - FSG - AS DATE DEC '14 DESIGN APPROVED BSD-7033 (B) Gate - Natural area - Pedestrian entry - General notes - Sheet 1 of 3.dm FILENAME SENIOR CO-ORDINATOR NATURAL ENVIRONMENT ASSET SERVICES/BRISBANE INFRASTRUCTURE ASSOCIATED PLANS BSD-7033-Sheets 2 & 3




#### **BRISBANE CITY COUNCIL STANDARD DRAWING**

GATE — NATURAL AREA — PEDESTRIAN ENTRY — GENERAL NOTES — SHEET 1 OF 3

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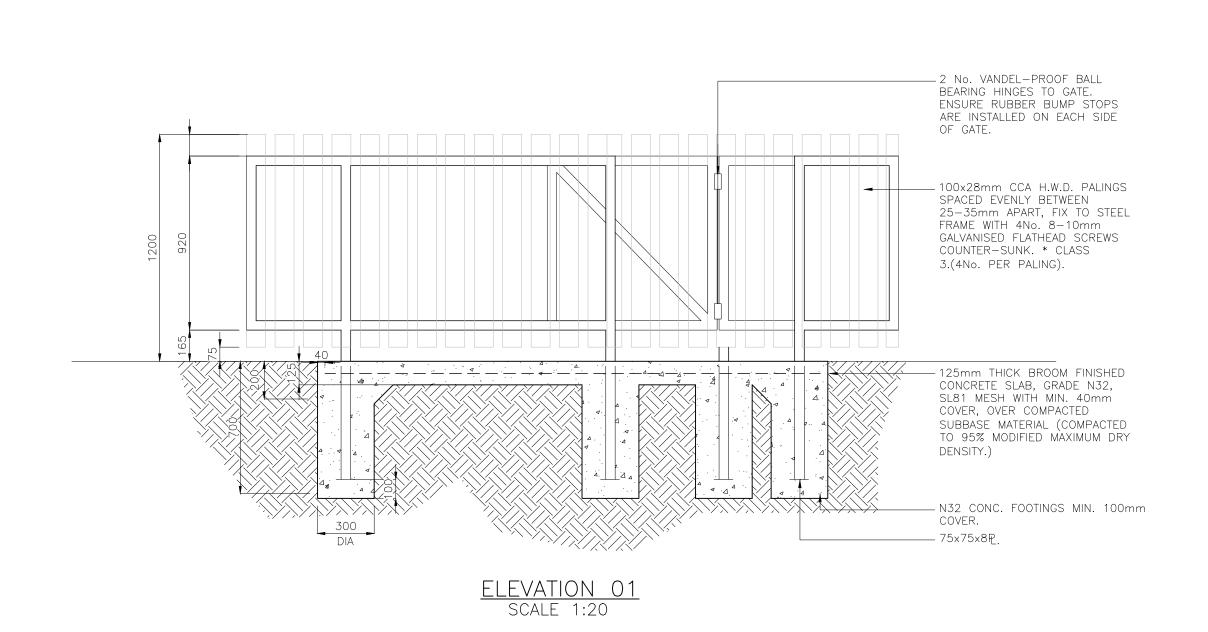


**BRISBANE CITY COUNCIL STANDARD DRAWING** 

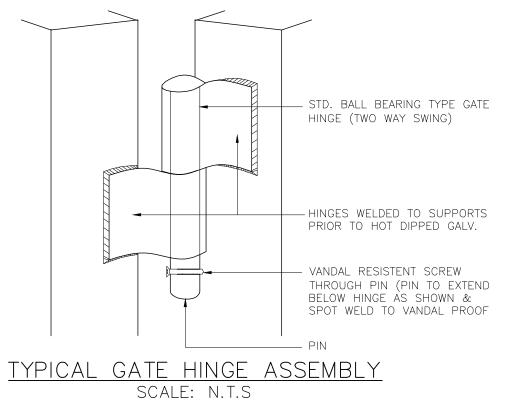GATE — NATURAL AREA — PEDESTRIAN ENTRY — DETAILS SHEET 2 OF 3

	SCALE AS	SHOWN
	DWG No.	
5	BSD	<b>-</b> 7033
	ORIGINAL SIZE	REVISION
	Α3	В
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ISSUE	AMENDMENT	DRAWN	CHK'D	APPR'D	SENIOR CO-ORDINATOR NATURAL ENVIRONMENT	ASSOCIATED	BSD-7033-Sheets 1 & 3		
Α	ORIGINAL ISSUE	DEC '14	DEC '14	DEC '14	C.Wood	DRAWING FILENAME	BSD-7033 (B) Gate - Natural area - Pedo	estrian entry - De	tails - Sheet 2 of 3.dwg
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					STRATEGIC ASSET MANAGEMENT	CHECKED	ח רככ גכ	DATE	DEC 141
					2015.06.04 12:01:08+10'00' fo <sup>f</sup> ASSET ENGINEERING MANAGER	DRAWN	CPO – P&D	DATE	DEC '14
					Inga Condric				
					DRAWING AUTHORISED FOR PUBLICATION	DESIGN	CPO - P&D	DATE	DEC '14




ISSUE	AMENDMENT	DRAWN DATE	CHK'D DATE	APPR'D Date	SENIOR CO-ORDINATOR NATURAL ENVIRONMENT ASSET SERVICES/BRISBANE INFRASTRUCTURE	ASSOCIATED PLANS	BSD-7033-Sheets 1 & 2		
А	ORIGINAL ISSUE	DEC '14	DEC '14	DEC '14	C.Wood	DRAWING FILENAME	BSD-7033 (B) Gate - Natural area - Pedi	estrian entry - De	tails - Sheet 3 of 3.dwg
В	Drawing Title Amended	FEB '16	JUL '16	JUL '16	DESIGN APPROVED		BI - FSG - AS	DATE	DEC '14
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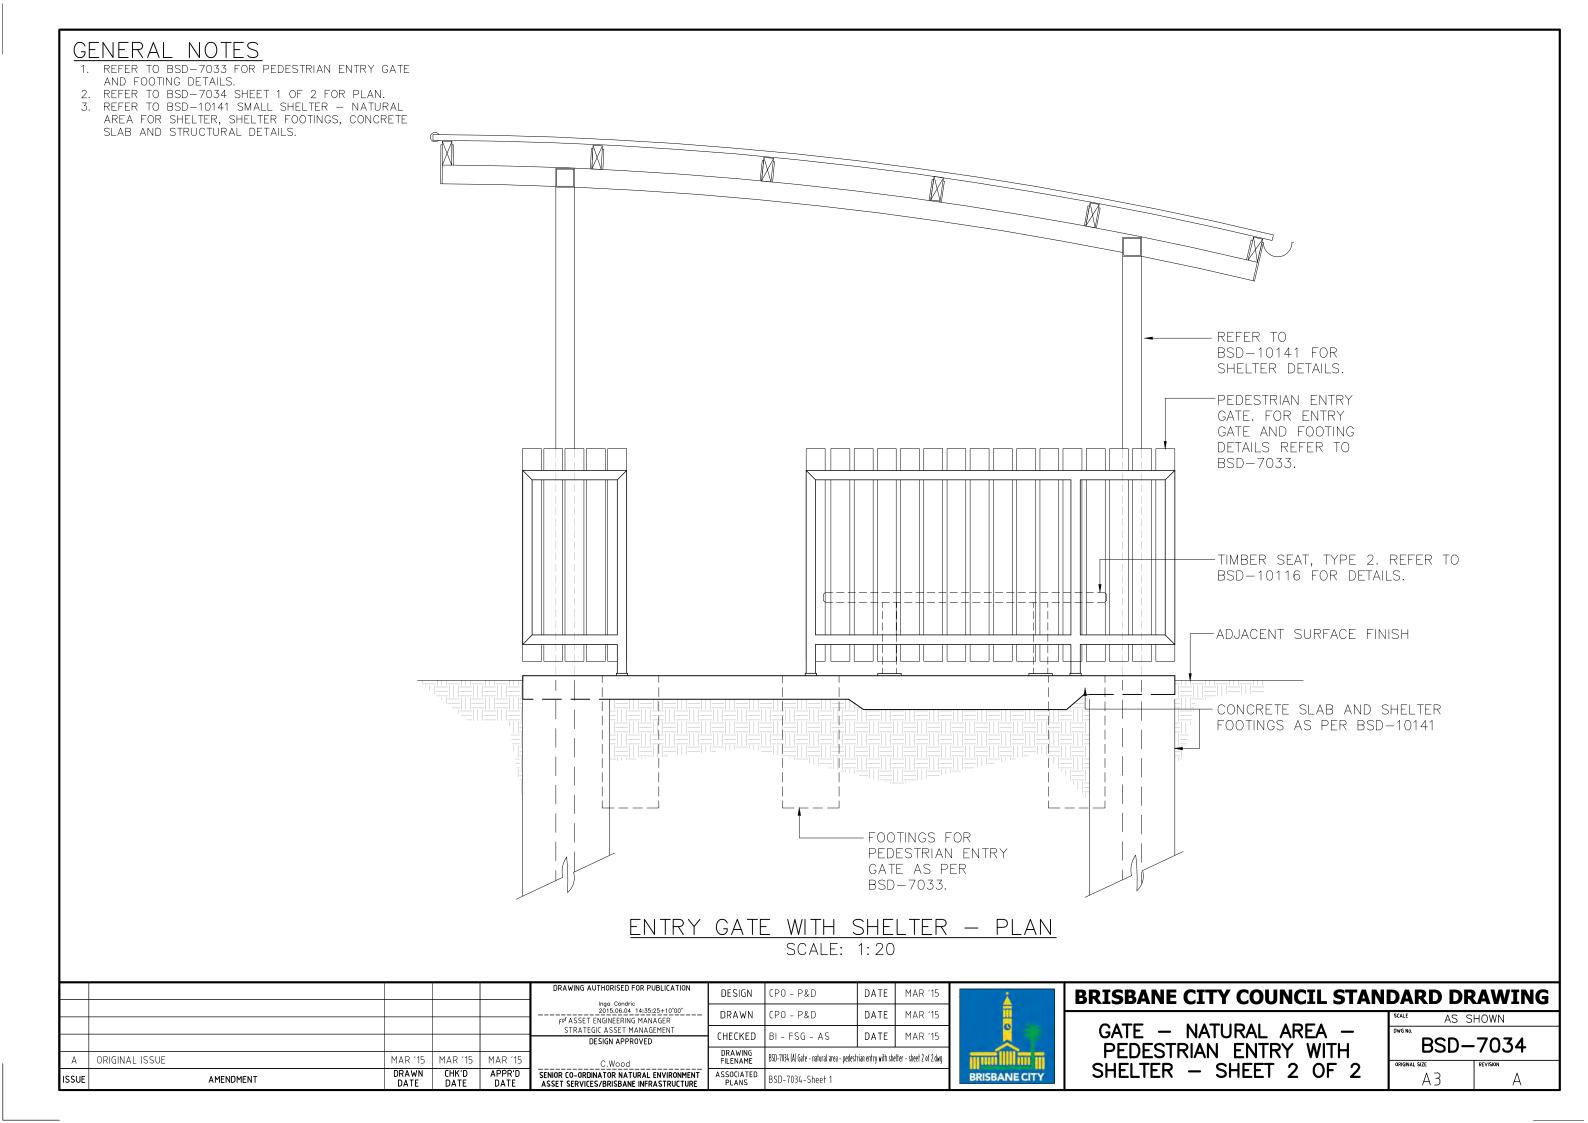


#### **BRISBANE CITY COUNCIL STANDARD DRAWING**

GATE - NATURAL AREA - PEDESTRIAN ENTRY - DETAILS SHEET 3 OF 3

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#### **GENERAL NOTES & SPECIFICATIONS**

- ENSURE ENTRANCE BARRIERS ARE LOCATED IN ACCORDANCE WITH THE PARKS CHAPTER OF INFRASTRUCTURE DESIGN PLANNING SCHEME POLICY.
- 2. POSITION GATES AWAY FROM MAIN PEDESTRIAN AREAS.
- 3. ENSURE THAT MAINTENANCE VEHICLES CAN ACCESS THE GATE VIA THE STREET OR PATHWAY AREAS WITHIN THE PARK.
- 4. STOP SIGN TO R1-1 SIGN SPECIFICATIONS IN THE MANUAL OF UNIFORM TRAFFIC CONTROL DEVICES (MUTCD).
- 5. POSTS TO POSITIONED IN A STRAIGHT LINE WITH ADJOINING BOLLARDS OR BARRIERS AT 1500mm CENTRES.
- 6. ENSURE ENTRANCE BARRIERS ARE CLEANED OF CONCRETE SLURRY OR SPRAY WHEN INSTALLED TO PREVENT STAINING OR DAMAGE TO APPLIED FINISHES.
- 7. AUSTRALIAN STANDARDS SHALL BE IN ACCORDANCE WITH THE CURRENT EDITIONS OF THE REFERENCED AUSTRALIAN STANDARDS EXCEPT WHERE VARIED BY SPECIFICATIONS AND/OR DRAWINGS.
- 8. POSITION LOCKRAILS AWAY FROM MAIN PEDESTRIAN AREAS. ENSURE THAT MAINTENANCE VEHICLES CAN ACCESS THE LOCKRAIL VIA THE STREET OR ROADS AREAS WITHIN THE PARK.
- 9. PROVIDE A SETBACK OR QUEUING AREA AND FORMED DRIVEWAY BETWEEN THE LOCKRAIL AND STREET AS REQUIRED UNDER THE INFRASTRUCTURE DESIGN PLANNING SCHEME POLICY; TRANSPORT, ACCESS, PARKING AND SERVICING PLANNING SCHEME POLICYOR AS SHOWN ON THE PLAN.
- 10. ALL DIMENSIONS IN MILLIMETRES (U.N.O.).
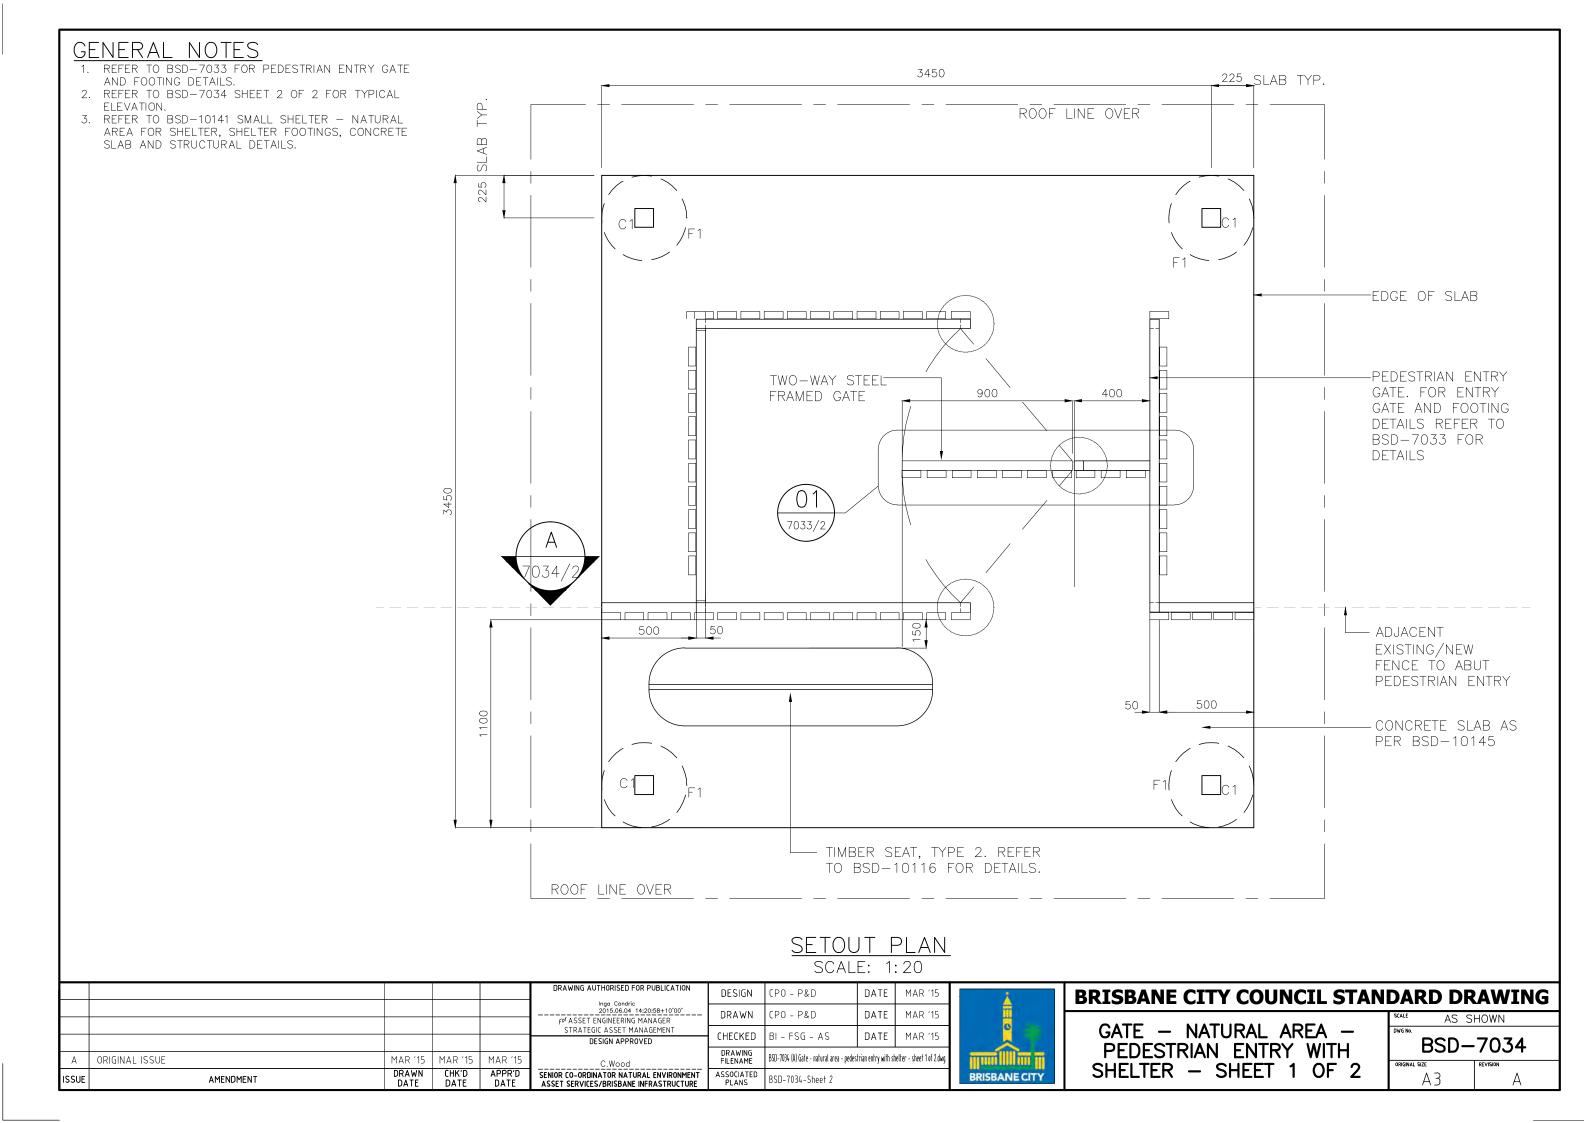
#### FIXTURES/FITTINGS/METAL WORK NOTES

- F1. ENTIRE FABRICATION TO BE MILD STEEL HOT-DIPPED GALVANISED TO THE FOLLOWING AUSTRALIANS STANDARDS
  - FERROUS OPEN SECTIONS TO AS4791.
  - FERROUS HOLLOW SECTIONS TO AS4792.
- F2. METAL WORK WITHIN FOOTINGS TO BE COAL TAR EPOXIED.
- F3. ENSURE ALL WELDS ARE 5mm THICK CONTINUOUS FILLET WELDS (C.F.W.) TO AS/NZS1554 WITH COLD GALVANISING TREATMENT TO COMPLETED WELDS
- F4. RAILS TO BE GALVANISED STEEL TUBE TO AS1163 OF THE FOLLOWING SIZES:
  - 65NB x 3.6mm WALL (MEDIUM DUTY) FOR USE WITH STEEL POSTS.
  - 80NB x 4.0mm WALL (MEDIUM DUTY) FOR USE WITH TIMBER POSTS.
- F5. ARRIS ALL LEADING EDGES, ENSURING ALL WELDING SLAG AND BARBS ARE REMOVED PRIOR TO GALVANISING AND APPLIED FINISHES.
- F6. POWDERCOAT FINISH AFTER GALVANISING TO AS4506 TO POSTS AFTER GALVANISING. FINISH COLOUR TO BE BSD-1003 BRISBANE CITY COUNCIL CORPORATE COLOUR PALLETTE (& AS2700 EQUIVALENT) "YELLOW 5" (AS2700S-1996 "Y11 CANARY" EQUIV.). APPLY REFLECTIVE TAPE IN SPIRAL PATTERN ACROSS RAIL.
- F7. APPLY CLASS 1A RETROREFLECTIVE TAPE IN PATTERN ACROSS TOP RAIL AND POSTS (IF APPLICABLE) AS SHOWN IN ASSOCIATED DETAILS REFER BSD-7053, BSD-7054 & BSD-7055.
- F8. COUNCIL TO SUPPLY AND INSTALL PADLOCKS. CONTACT COUNCIL ON 3403 8888.
- F9. WHERE POSSIBLE ALL FIXINGS TO BE TAMPER/VANDAL PROOF TO MINIMISE DAMAGE OR THEFT.

#### **CONCRETE WORK NOTES**

- C1. ALL WORKMANSHIP AND MATERIAL SHALL BE IN ACCORDANCE WITH AS3600.
- C2. AT A MINIMUM ALL CONCRETE TO BE GRADE N25. CONCRETE SHALL BE NORMAL CLASS CONCRETE UNLESS DIRECTED OTHERWISE.

  N25 SHALL MEAN NORMAL CLASS CONCRETE WITH A 28 DAY CHARACTERISTIC STRENGTH OF 25MPa. CONCRETE MIX DESIGN SHALL BE SUBMITTED TO THE SITE SUPERINTENDENT FOR APPROVAL FIVE (5) DAYS PRIOR TO ORDERING.
- C3. ALL CEMENT TO BE TYPE GP OR GB TO AS3972 UNLESS SPECIFIED OTHERWISE.
- C4. NOMINAL AGGREGATE SIZE TO BE 20mm, SLUMP TO BE NOT GREATER THAN 80mm.
- C5. THE BOTTOMS OF ALL FOOTINGS ARE TO BE CLEANED OF ALL LOOSE MATERIAL AND WATER PRIOR TO PLACING CONCRETE.

#### TIMBER WORK NOTES

- T1. TIMBER SHOULD BE SOURCED FROM LEGAL AND SUSTAINABLE SOURCES. TIMBERS ARE CONSIDERED ACCEPTABLE WHERE THERE IS A HIGH DEGREE OF CERTAINTY THAT THEY ARE FROM FORESTS, EITHER NATIVE OR PLANTATION, THAT ARE LEGALLY HARVESTED AND SUSTAINABLY MANAGED. THE CONTRACTOR IS TO SUBMIT EVIDENCE THAT THE TIMBER HAS BEEN OBTAINED FROM A LEGAL AND SUSTAINABLE SOURCE.
- T2. ALL TIMBER TO BE ACQ PRESSURE TREATED OR TANALITH E (COPPER AZOL) TO AS1608 TREATED ROUGH SAWN APPEARANCE GRADE HARDWOOD OF ONE SPECIES.
- T3. ALL EXPOSED EDGES TO RECEIVE MIN. 5mm WIDE ARRIS.
- T4. PRIOR TO INSTALLATION, ALL CUTS, EDGES, JOINTS TO RECEIVE LIBERAL COATINGS WITH AN APPROVED TIMBER PRESERVATIVE.
- T5. ALL TIMBER IN CONTACT WITH GROUND TO BE PRESERVATIVE TREATED HAZARD CLASS H5 TO AS 1604 AND HAVE A DURABILITY CLASS 1 OR 2 TO AS5604
- T6. ALL TIMBER TO BE FREE OF KNOTS, SPLINTERS, CRACKS OR ANY MAJOR DEFECT.
- T7. TIMBER PRESERVATIVES WHERE NO FINISH SPECIFIED, ALL TIMBER TO RECEIVE 3 x COATS OF CLEAR APPROVED TIMBER PRESERVATIVE SUCH AS COPPER NAPTHENATE OIL (FOR ABOVE GROUND USE) AND COPPER NAPTHENATE EMULSION (FOR BELOW GROUND USE) COAT ENTIRE BOLLARD PRIOR TO PLACING.
- T8. COLOUR SELECTION WHERE APPLICABLE IN ACCORDANCE WITH BSD-1003 BRISBANE CITY COUNCIL CORPORATE COLOUR PALLETTE (& AS2700 EQUIVALENT). COAT ENTIRE BOLLARD PRIOR TO PLACING.

REFER TO BSD-7053, BSD-7054 & BSD-7055 FOR ASSOCIATED DETAILS



BRISBANE CITY COUNCIL STANDARD DRAWING

ENTRANCE BARRIERS - GENERAL NOTES

PUBLISH DATE

MAR 2021


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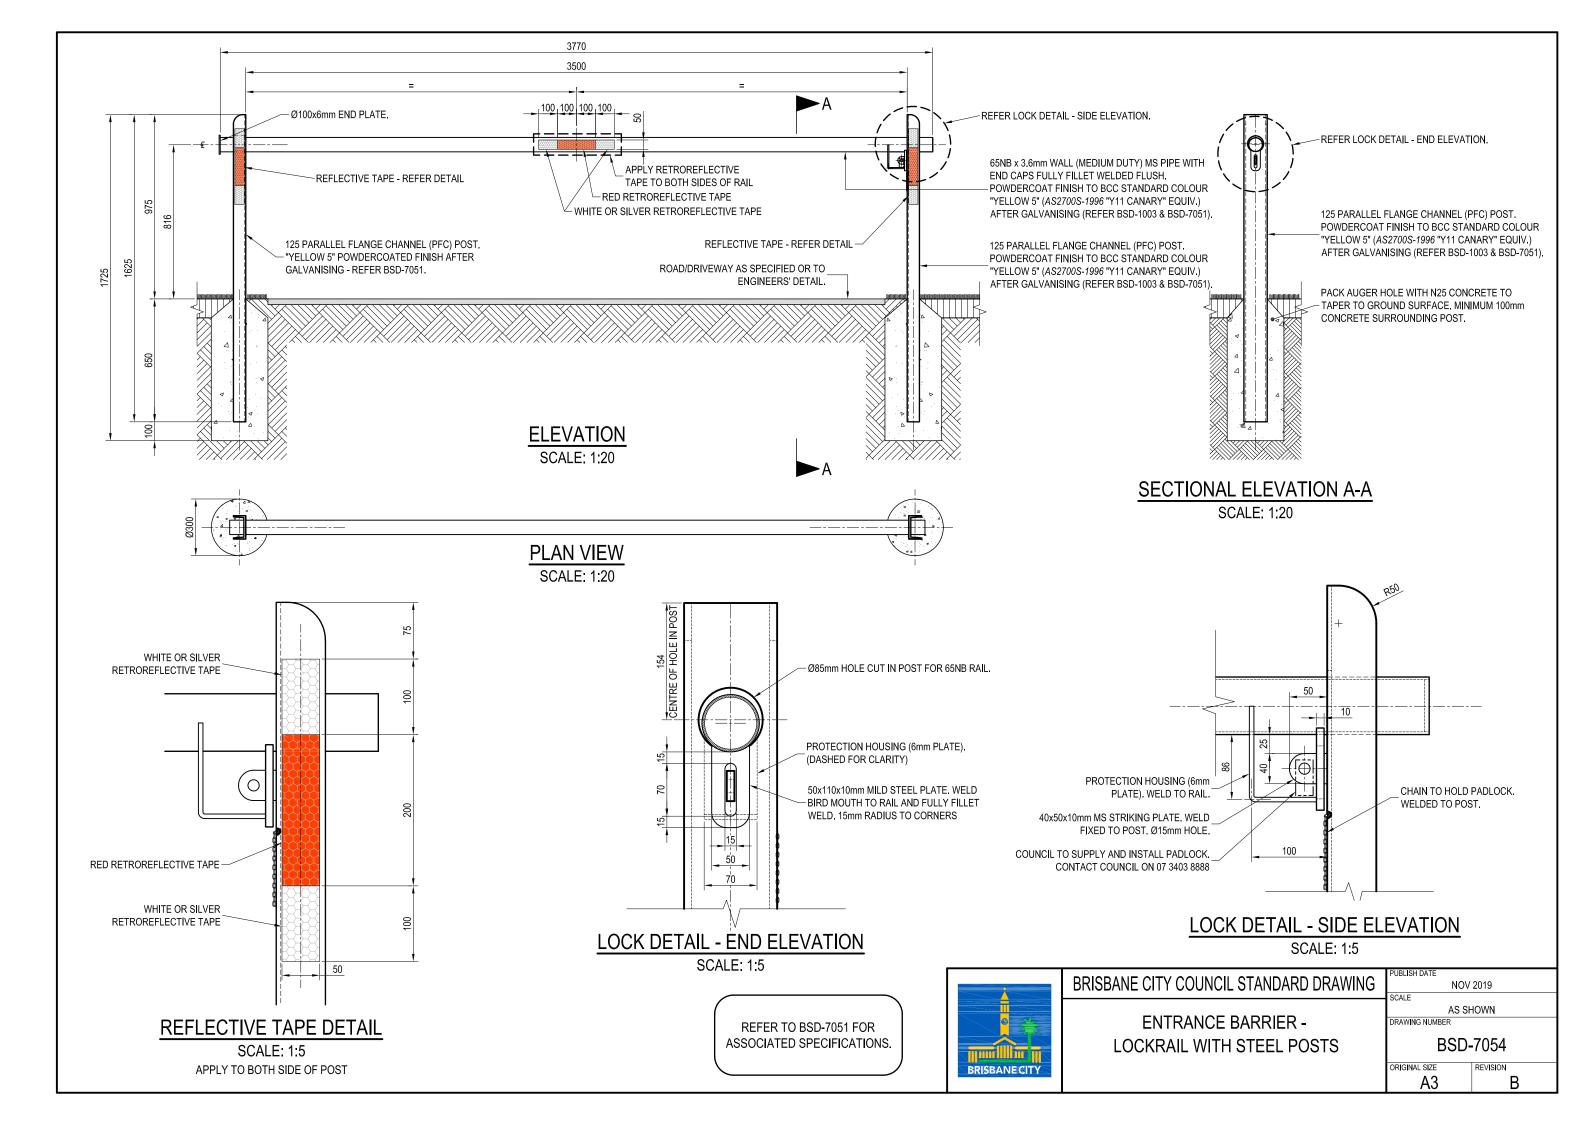
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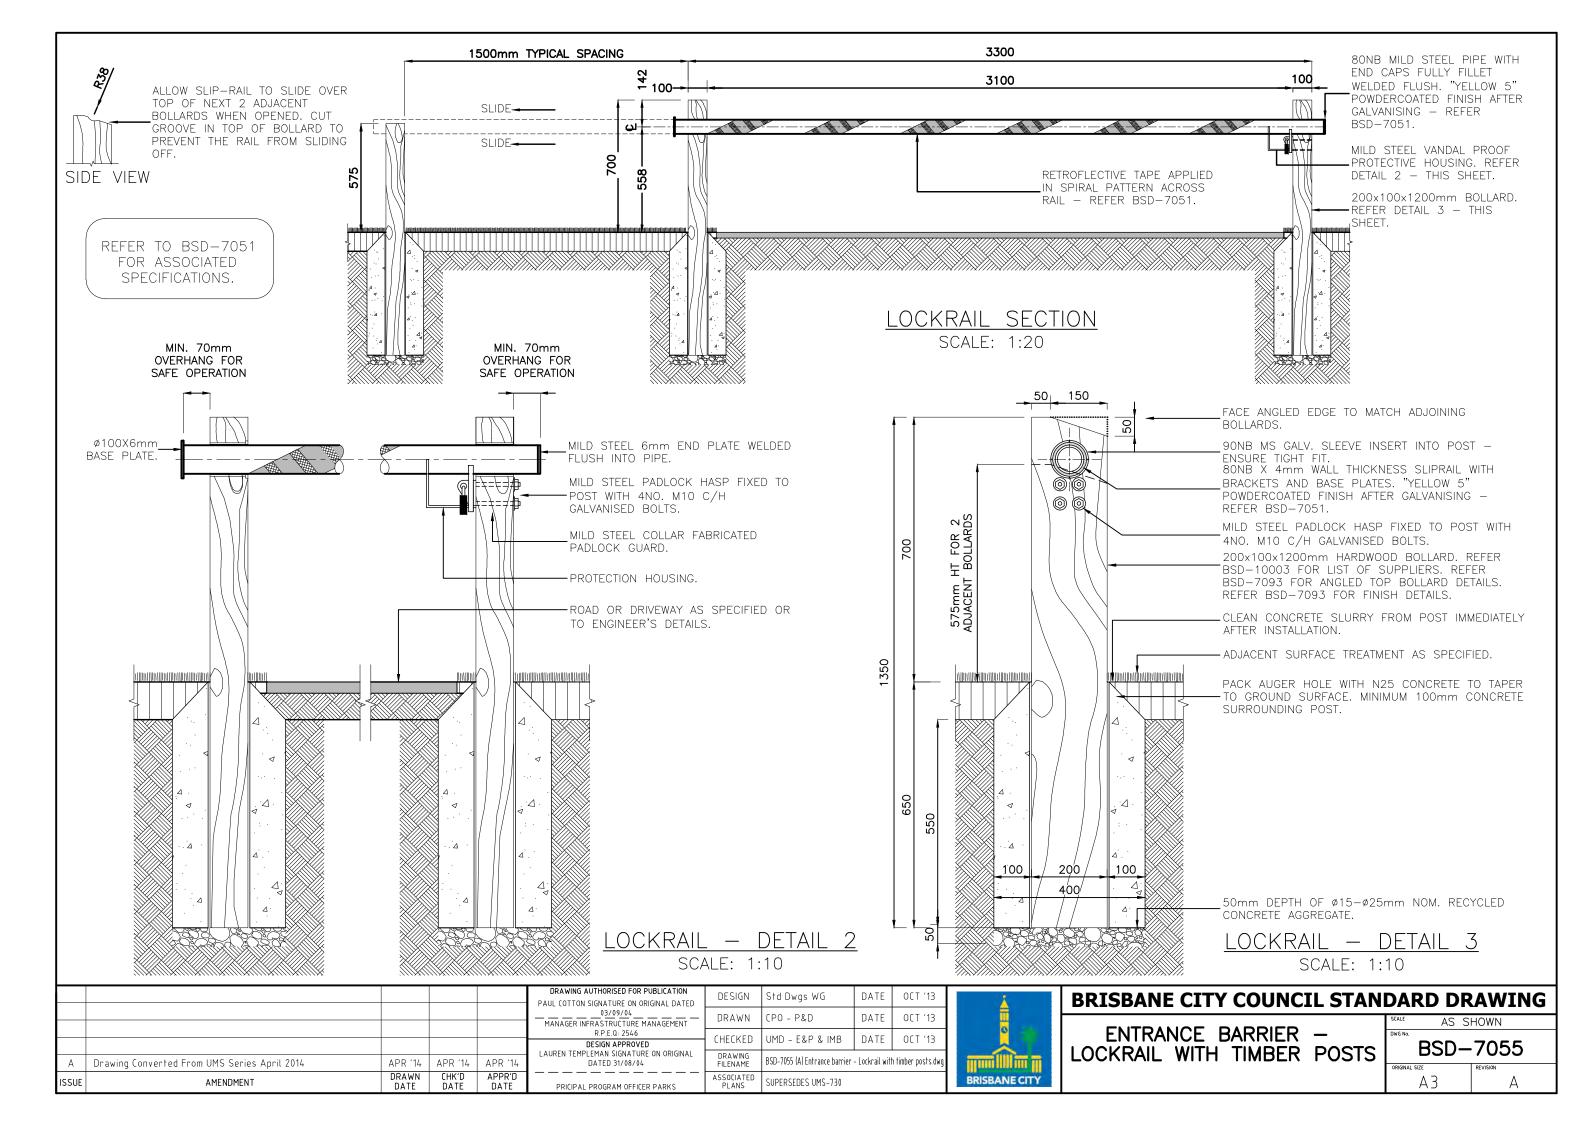
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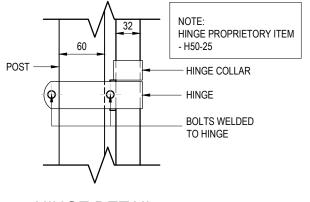
#### PLAN SCALE: 1:20 3985 32 OD, 3.6MM THICK PIPE. 1978 1978 g HINGE AND COLLAR LOCKING BOX. REFER TO 32 BSD - 7059 FOR LOCKING BOX OPTIONS. - SLOPE CONCRETE SURFACE AWAY FROM POST AT 1:6. В 32 200 N25 CONCRETE FOOTING. 150 X 150 X 6MM BASE PLATE WELDED TO BASE OF POST. 100 **ELEVATION** NOTE: 32 HINGE PROPRIETORY ITEM - H50-25

#### **GENERAL NOTES**

- G1. ENSURE THAT WORK IS IN ACCORDANCE WITH BRISBANE CITY COUNCIL ENVIRONMENTAL BEST PRACTICE NOTES.
- G2. SITE SETOUT TO BE VERIFIED BY SUPERINTENDENT OR LANDSCAPE ARCHITECT PRIOR TO THE COMMENCEMENT OF CONSTRUCTION WORKS.
- G3. VERIFY LOCATION OF ALL SERVICES AND EASEMENTS PRIOR TO THE COMMENCEMENT OF WORKS.
- G4. WRITTEN DIMENSIONS TAKE PRECEDENCE OVER SCALED DISTANCES.
- G5. VERIFY ALL DIMENSIONS ON SITE PRIOR TO CONSTRUCTION.
- G6. STRUCTURES HAVE BEEN DESIGNED ON THE ASSUMPTION THAT THE MINIMUM ALLOWABLE BEARING CAPACITY FOR SOIL IS 100KPa AND TERRAIN CATEGORY = 2.5.
- G7. IN EACH CASE ENGINEERING CERTIFICATION AND MODIFICATION AS NECESSARY WILL BE REQUIRED FOR PARTICULAR SOIL AND SITE CONDITIONS.
- G8. THE COPYRIGHT OF THIS DRAWING REMAINS THE PROPERTY OF THE BRISBANE CITY COUNCIL.
- G9. REFER TO BSD 7059 FOR LOCKING BOX TYPE AND DETAILS.

#### **NOTES**

- N1. WHERE STANDARD IS FOR USE IN A NON-MARINE ENVIRONMENT (UP TO 1km FROM THE FORESHORE), THE FOLLOWING PROTECTION TREATMENT IS REQUIRED:
  - HOT DIP GALVANISING: FERROUS OPEN SECTIONS TO AS4791.
  - FERROUS HOLLOW SECTIONS TO AS4792.
  - STEEL WORK TO BE POWDERCOATED TO AS4506 COLOUR 'YELLOW'.
- N2. WHERE STANDARD IS REQUIRED FOR USE WITHIN MARINE ENVIRONMENT, THE FOLLOWING PROTECTION TREATMENT IS REQUIRED:
  - STEELWORK HOT DIP GALVANISING: 85 MICRONS (600g/m²) MIN;
  - SWEEP ABRASIVE BLAST;
  - STEELWORK FIRST COAT: EPOXY PRIMER 75 MICRONS MIN;
  - STEELWORK SECOND COAT: TWO PACK ACRYLIC OR POLYURETHANE GLOSS 75 MICRONS MIN;
- N3. PAINT SYSTEMS TO BE IN ACCORDANCE WITH AS2312 AND IS DESIGNATED HDG600P6 AND HDG600P.
- N4. GATE POSTS TO BE 60NB GALVANISED STEEL TUBE TO AS/NZ1163.
- N5. RAILS TO BE 320D, 3.6mm THICK GALVANISED STEEL TUBE TO AS/NZ1163.
- N6. POSTS TO BE VERTICAL.
- N7. ALL RAILS ARE SWAGED AND WELDED.
- N8. ALL JOINTS TO BE FULLY WELDED. WELDS TO BE 5 THICK C.F.W (CONTINUOUS FILLET WELDS) TO AS/NZS1554.1.
- N9. GATE AND ADJACENT POSTS TO BE POWDER COATED 'YELLOW'.

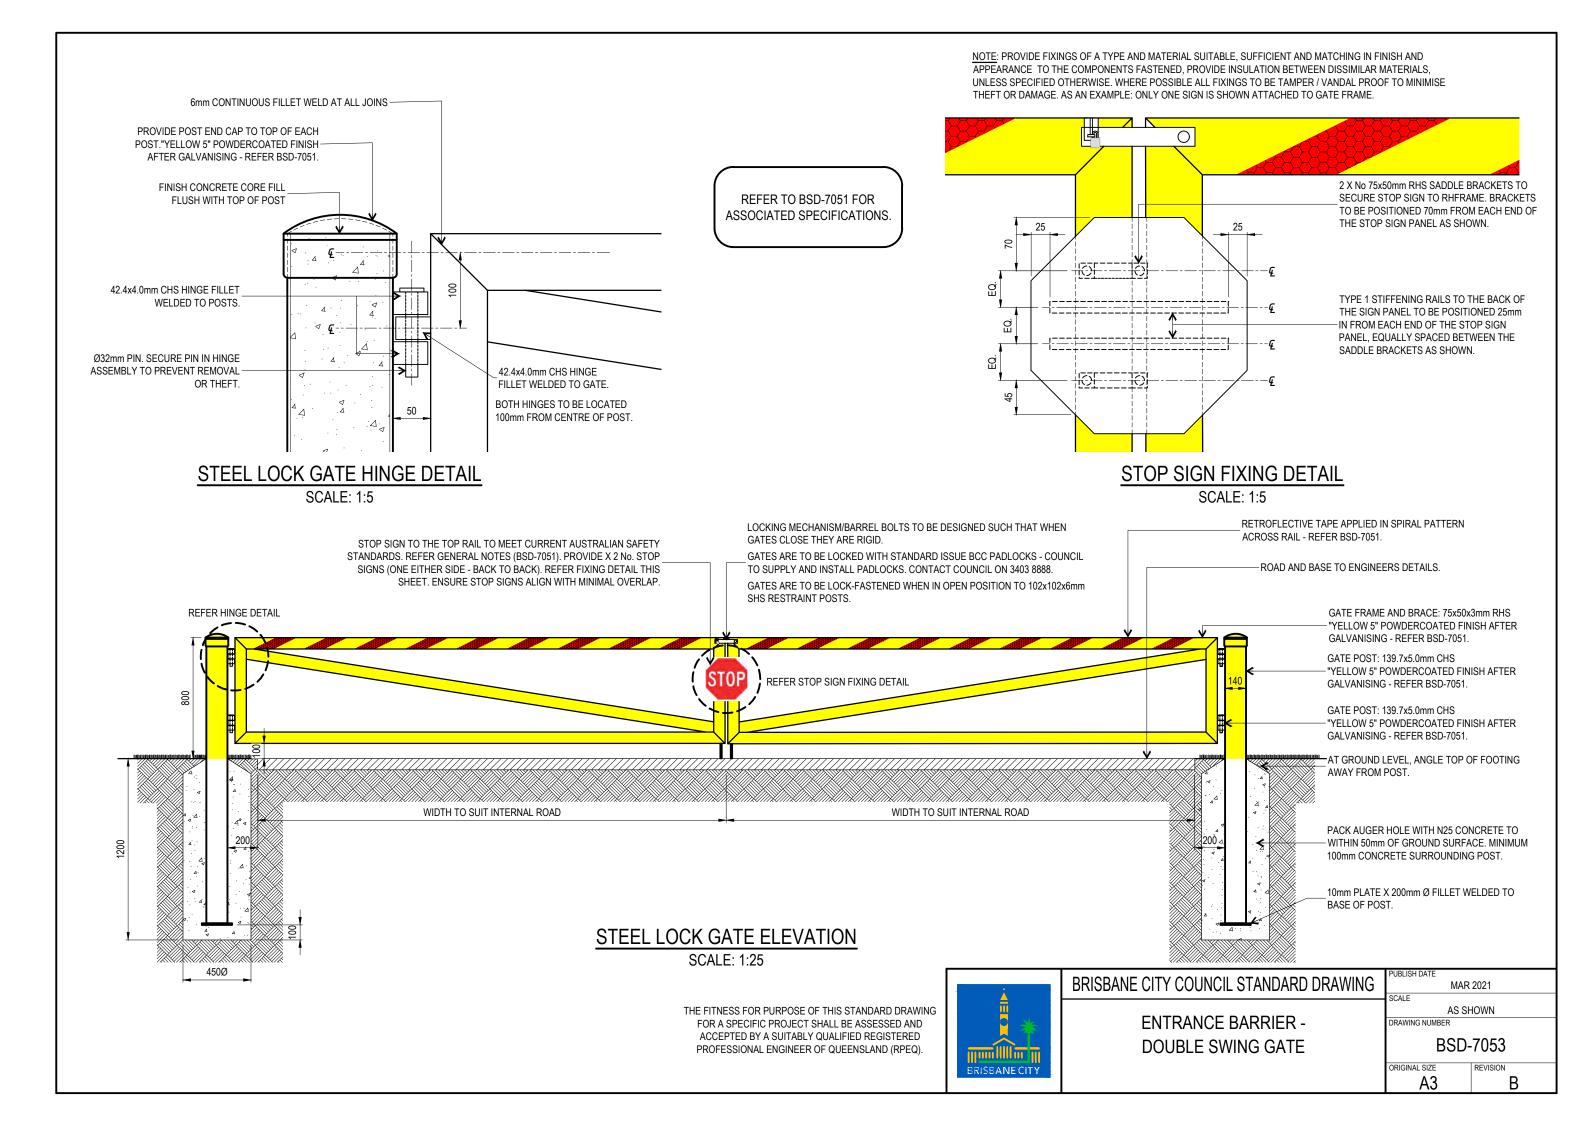

HINGE DETAIL SCALE: 1:5


ISSUE	AMENDMENT	DRAWN DATE	CHK'D DATE	APPR'D DATE	SENIOR CO-ORDINATOR NATURAL ENVIRONMENT ASSET SERVICES/BRISBANE INFRASTRUCTURE	ASSOCIATED PLANS			
Α	ORIGINAL ISSUE	DEC '14	DEC '14	DEC '14	C.Wood	DRAWING FILENAME	BSD-7056 (B) Vehicle access gate - Natural area - Light		ea - Light duty.dwg
В	Note Numbers Added/Updated, AS/NZS Reference in Note N8 Corrected	SEP '18	APR '19	APR '19	DESIGN APPROVED		BI - FSG - AS	DATE	DEC '14
					FO <sup>r</sup> ASSET ENGINEERING MANAGER STRATEGIC ASSET MANAGEMENT				
					Inga Condric 2015.06.04 14:36:17+10'00'	DRAWN	CPO - P&D	DATE	DEC '14
					DRAWING AUTHORISED FOR PUBLICATION	DESIGN	CPO - P&D	DATE	DEC '14



#### **BRISBANE CITY COUNCIL STANDARD DRAWING**

VEHICLE ACCESS GATE NATURAL AREA LIGHT DUTY

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SCALE AS SH	IOWN
BSD-	7056
ORIGINAL SIZE	REVISION
A3	В

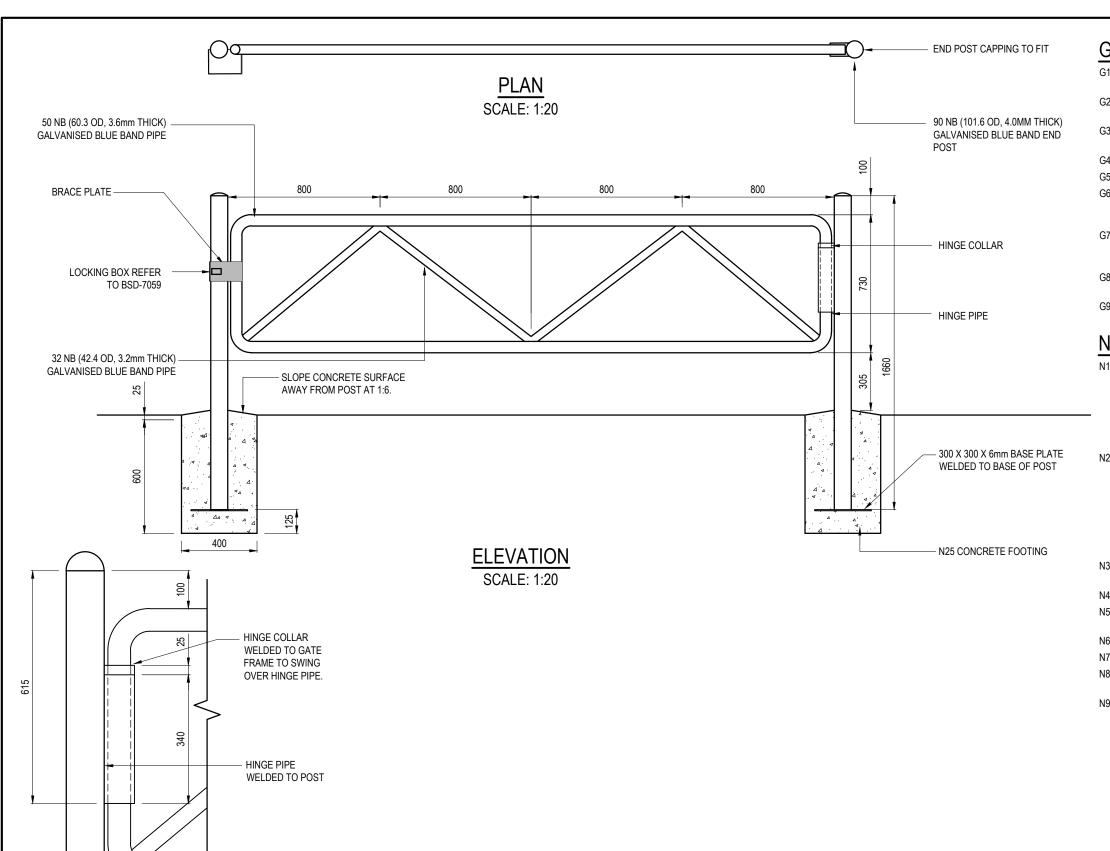

#### **GENERAL NOTES**

- G1. ENSURE THAT WORK IS IN ACCORDANCE WITH BRISBANE CITY COUNCIL ENVIRONMENTAL BEST PRACTICE NOTES.
- G2. SITE SETOUT TO BE VERIFIED BY SUPERINTENDENT OR LANDSCAPE ARCHITECT PRIOR TO THE COMMENCEMENT OF CONSTRUCTION WORKS.
- G3. VERIFY LOCATION OF ALL SERVICES AND EASEMENTS PRIOR TO THE COMMENCEMENT OF WORKS.
- G4. WRITTEN DIMENSIONS TAKE PRECEDENCE OVER SCALED DISTANCES.
- G5. VERIFY ALL DIMENSIONS ON SITE PRIOR TO CONSTRUCTION.
- G6. STRUCTURES HAVE BEEN DESIGNED ON THE ASSUMPTION THAT THE INIMUM ALLOWABLE BEARING CAPACITY FOR SOIL IS 100KPa AND TERRAIN CATEGORY = 2.5.
- G7. IN EACH CASE ENGINEERING CERTIFICATION AND MODIFICATION AS NECESSARY WILL BE REQUIRED FOR PARTICULAR SOIL AND SITE CONDITIONS.
- G8. THE COPYRIGHT OF THIS DRAWING REMAINS THE PROPERTY OF THE BRISBANE CITY COUNCIL.
- G9. REFER TO BSD 7059 FOR LOCKING BOX TYPE AND DETAILS.

#### **NOTES**

- N1. WHERE STANDARD IS FOR USE IN A NON-MARINE ENVIRONMENT (UP TO 1km FROM THE FORESHORE), THE FOLLOWING PROTECTION TREATMENT IS REQUIRED:
  - HOT DIP GALVANISING: FERROUS OPEN SECTIONS TO AS4791.
  - FERROUS HOLLOW SECTIONS TO AS4792.
  - STEEL WORK TO BE POWDERCOATED TO AS4506 COLOUR 'YELLOW'.
- N2. WHERE STANDARD IS REQUIRED FOR USE WITHIN MARINE ENVIRONMENT, THE FOLLOWING PROTECTION TREATMENT IS REQUIRED:
  - STEELWORK HOT DIP GALVANISING: 85 MICRONS (600g/m²) MIN;
  - SWEEP ABRASIVE BLAST;
  - STEELWORK FIRST COAT: EPOXY PRIMER 75 MICRONS MIN;
  - STEELWORK SECOND COAT: TWO PACK ACRYLIC OR POLYURETHANE GLOSS 75 MICRONS MIN;
- N3. PAINT SYSTEMS TO BE IN ACCORDANCE WITH AS2312 AND IS DESIGNATED HDG600P6 AND HDG600P.
- N4. GATE POSTS TO BE 90NB GALVANISED STEEL TUBE TO AS/NZ1163.
- N5. RAILS TO BE 500D (60.30D), 3.6mm THICK GALVANISED STEEL TUBE TO AS/NZ1163.
- N6. POSTS TO BE VERTICAL.
- N7. ALL RAILS ARE SWAGED AND WELDED.
- ALL JOINTS TO BE FULLY WELDED. WELDS TO BE 5 THICK C.F.W. (CONTINUOUS FILLET WELDS) TO AS/NZS1554.1.
- N9. GATE AND ADJACENT POSTS TO BE POWDER COATED 'YELLOW'.

		DRAWN	CHK'D	APPR'D	SENIOR CO-ORDINATOR NATURAL ENVIRONMENT	ASSOCIATED			
Α	ORIGINAL ISSUE	DEC '14	DEC '14	DEC '14	C.Wood	DRAWING FILENAME	BSD-7057 (B) Vehicle access gate - Natural area - Medi		Medium duty.dwg
В	Note Nymbers Added/Updated, AS/NZS Reference in Note N8 Corrected	SEP '18	APR '19	APR '19	DESIGN APPROVED		BI - FSG - AS	DATE	DEC '14
					r <sup>of</sup> ASSET ENGINEERING MANAGER STRATEGIC ASSET MANAGEMENT				
					Inga Condric 2015.06.04 14:37:10+10'00'	DRAWN	CPO - P&D	DATE	DEC '14
					DRAWING AUTHORISED FOR PUBLICATION	DESIGN	CPO - P&D	DATE	DEC '14

HINGE DETAIL



#### **BRISBANE CITY COUNCIL STANDARD DRAWING**

VEHICLE ACCESS GATE NATURAL AREA MEDIUM DUTY

AND DI	MILLIO
SCALE AS SH	HOWN
BSD-	-7057
ORIGINAL SIZE	REVISION
Α3	В


#### 58 NB GALVANISED BLUE-GATE POSTS TO BE CONCRETE FILLED BAND GATE & GATE POSTS AND CAPPED. 500 4050 500 4000 THREE RAIL FENCE. REFER TO ADJACENT THREE RAIL 788 EQ EQ EQ 788 BSD-7008. FENCE WITH 100 NB POST TO END GATE LOCKING ASSEMBLY TO BE CONTAINED IN PROTECTIVE LOCK BOX. REFER TO BSD-7059 FOR LOCK BOX OPTIONS. 200 600x4850x700mm DEEP -MASS CONCRETE FOOTING TO GATE. CONCRETE, **BROOM FINISHED** 4000 **ELEVATION**

#### **GENERAL NOTES**


- ENSURE THAT WORK IS IN ACCORDANCE WITH BRISBANE CITY COUNCIL ENVIRONMENTAL BEST PRACTICE NOTES.
- 22. SITE SETOUT TO BE VERIFIED BY SUPERINTENDENT OR LANDSCAPE ARCHITECT PRIOR TO THE COMMENCEMENT OF CONSTRUCTION WORKS.
- G3. VERIFY LOCATION OF ALL SERVICES AND EASEMENTS PRIOR TO THE COMMENCEMENT OF WORKS.
- G4. WRITTEN DIMENSIONS TAKE PRECEDENCE OVER SCALED DISTANCES.
- G5. VERIFY ALL DIMENSIONS ON SITE PRIOR TO CONSTRUCTION.
- G6. STRUCTURES HAVE BEEN DESIGNED ON THE ASSUMPTION THAT THE MINIMUM ALLOWABLE BEARING CAPACITY FOR SOIL IS 100KPa AND TERRAIN CATEGORY = 2.5.
- G7. IN EACH CASE ENGINEERING CERTIFICATION AND MODIFICATION AS NECESSARY WILL BE REQUIRED FOR PARTICULAR SOIL AND SITE CONDITIONS
- G8. THE COPYRIGHT OF THIS DRAWING REMAINS THE PROPERTY OF THE BRISBANE CITY COUNCIL.
- G9. REFER TO BSD-7059 FOR LOCKING BOX TYPE AND DETAILS.

#### **NOTES**


- WHERE STANDARD IS FOR USE IN A NON-MARINE ENVIRONMENT (UP TO 1KM FROM THE FORESHORE), THE FOLLOWING PROTECTION TREATMENT IS REQUIRED.
- HOT DIP GALVANISING: FERROUS OPEN SECTIONS TO AS4791.
- FERROUS HOLLOW SECTIONS TO AS4792.
- STEEL WORK TO BE POWDERCOATED TO AS4506 COLOUR 'YELLOW'.
- 2. WHERE STANDARD IS REQUIRED FOR USE WITHIN MARINE ENVIRONMENT, THE FOLLOWING PROTECTION TREATMENT IS REQUIRED:
  - STEELWORK HOT DIP GALVANISING: 85 MICRONS (600g/m²) MIN;
  - SWEEP ABRASIVE BLAST;
- STEELWORK FIRST COAT: EPOXY PRIMER 75 MICRONS MIN;
- STEELWORK SECOND COAT: TWO PACK ACRYLIC OR POLYURETHANE GLOSS 75 MICRONS MIN;
- PAINT SYSTEMS TO BE IN ACCORDANCE WITH AS2312 AND IS DESIGNATED HDG600P6 AND HDG600P.
- 4. GATE POSTS TO BE 100NB (BLUE BAND) GALVANISED STEEL CONCRETE FILLED AND CAPPED TUBE TO AS/NZ1163.
- 5. RAILS TO BE 58 NB (BLUE BAND) GALVANISED STEEL TUBE TO AS/NZ1163.
- 6. ANY GATE POSTS MUST BE 100 NB (BLUE BAND) GALVANISED STEEL TUBE.
- 7. POSTS TO BE VERTICAL.
- 8. ALL RAILS ARE SWAGED AND WELDED.
- ALL JOINTS TO BE FULLY WELDED. WELDS TO BE 5 THICK C.F.W (CONTINUOUS FILLET WELDS) TO AS/NZS1554.1 WITH COLD GALVANISING TREATMENT TO COMPLETED WELDS.
- PREFERRED COLD GALVANISING TREATMENT FOR IN-SITU WELDS, CUT ENDS OR OTHER BARE STEEL IS TO APPLY 2 COATS OF INORGANIC ZINC PRIMER APPLIED BY BRUSH.
- 11. STANDARD COUPLINGS (MONOWILLS, SENTAUR JOINTS, KEE-KLAMP, SWAGED JOINTS OR SIMILAR) FOR POST TO RAIL CONNECTIONS MAY BE USED AS AN ALTERNATIVE TO WELDS WHERE APPROVED. 11° MAX REFLECTION FROM HORIZONTAL FOR STANDARD COUPLINGS. FOR ANGLES GREATER THAN 11°, SPECIALIST COUPLINGS MAY BE USED UPON APPROVAL FROM COUNCIL.
- 12. GATE AND ADJACENT POSTS TO BE POWDER COATED 'YELLOW'.

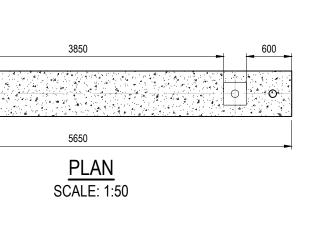

150

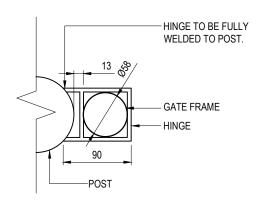

## HINGE DETAIL - PLAN

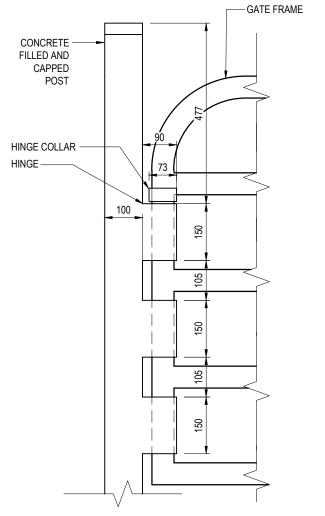

HINGE DETAIL - SECTION
SCALE: 1:10

B AS/NZS Reference in Note 9 A ORIGINAL ISSUE	00110000	DEC '14	DEC '14 CHK'D	DEC '14	C.Wood	DRAWING FILENAME	BSD-7058 (B) Vehicle access gat	te - Natural area	a - Heavy duty.dwg
B AS/NZS Reference in Note 9	001100100	SLI IO	APK 19	AFK 19	DESIGN APPROVED				
	Corrected	SEP '18	APR '19	APR '19	STRATEGIC ASSET MANAGEMENT  DESIGN APPROVED	CHECKED	BI - FSG - AS	DATE	DEC '14
					2015.06.04 14:37:57+10'00' FO <sup>®</sup> ASSET ENGINEERING MANAGER	DRAWN	CPO - P&D	DATE	DEC '14
					DRAWING AUTHORISED FOR PUBLICATION  Inga Condric	DESIGN	CPO - P&D	DATE	DEC '14



#### **BRISBANE CITY COUNCIL STANDARD DRAWING**

VEHICLE ACCESS GATE NATURAL AREA HEAVY DUTY

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	SCALE AS SH	HOWN					
	BSD-7058						
ı	יטטט	7000					
ı	ORIGINAL SIZE	REVISION					
	Α3	В					

#### **GENERAL NOTES**

- G1. ENSURE THAT WORK IS IN ACCORDANCE WITH BRISBANE CITY COUNCIL ENVIRONMENTAL BEST PRACTICE NOTES.
- G2. SITE SETOUT TO BE VERIFIED BY SUPERINTENDENT OR LANDSCAPE ARCHITECT PRIOR TO THE COMMENCEMENT OF CONSTRUCTION WORKS.
- G3.. VERIFY LOCATION OF ALL SERVICES AND EASEMENTS PRIOR TO THE COMMENCEMENT OF WORKS.
- G4. WRITTEN DIMENSIONS TAKE PRECEDENCE OVER SCALED DISTANCES.
- G5. VERIFY ALL DIMENSIONS ON SITE PRIOR TO CONSTRUCTION.
- G6. THE COPYRIGHT OF THIS DRAWING REMAINS THE PROPERTY OF THE BRISBANE CITY COUNCIL.

#### NOTES

- WHERE STANDARD IS FOR USE IN A NON-MARINE ENVIRONMENT (UP TO 1KM FROM THE FORESHORE), THE FOLLOWING PROTECTION TREATMENT IS REQUIRED:
- HOT DIP GALVANISING: FERROUS OPEN SECTIONS TO AS4791.
- FERROUS HOLLOW SECTIONS TO AS4792.
- STEEL WORK TO BE POWDERCOATED TO AS4506 COLOUR 'YELLOW'.
- 2. WHERE STANDARD IS REQUIRED FOR USE WITHIN MARINE ENVIRONMENT, THE FOLLOWING PROTECTION TREATMENT IS REQUIRED:
  - STEELWORK HOT DIP GALVANISING: 85 MICRONS (600g/m²) MIN;
  - SWEEP ABRASIVE BLAST;
- STEELWORK FIRST COAT: EPOXY PRIMER 75 MICRONS MIN;
- STEELWORK SECOND COAT: TWO PACK ACRYLIC OR POLYURETHANE GLOSS 75 MICRONS MIN;
- 3. PAINT SYSTEMS TO BE IN ACCORDANCE WITH AS2312 AND IS DESIGNATED HDG600P6 AND HDG600P
- ALL JOINTS TO BE FULLY WELDED. WELDS TO BE 5 THICK C.F.W (CONTINUOUS FILLET WELDS) TO AS/NZS1554.1 WITH COLD GALVANISING TREATMENT TO COMPLETED WELDS.
- LOCKING BOX, GATE AND ADJACENT POSTS TO BE POWDER COATED 'YELLOW'.


ISSUE	AMENDMENT	DRAWN DATE	CHK'D DATE	APPR'D DATE	SENIOR CO-ORDINATOR NATURAL ENVIRONMENT ASSET SERVICES/BRISBANE INFRASTRUCTURE	ASSOCIATED PLANS	BSD-7059-Sheet 2		
Α	ORIGINAL ISSUE	DEC '14	DEC '14	DEC '14	C.Wood	DRAWING FILENAME	BSD-7059 (C) Gate - Natural area - Locking boxes - Notes - Sheet 1 of 2		
В	Drawing Title Amended	FEB '16	FEB '16	FEB '16	DESIGN APPROVED		BI - FSG - AS	DATE	DEC '14
С	AS/NZS Rreference in Note 4 Corrected	SEP '18	APR '19	APR '19	FO <sup>F</sup> ASSET ENGINEERING MANAGER STRATEGIC ASSET MANAGEMENT				
					2015.06.30 07:32:15+10'00'	DRAWN	CPO - P&D	DATE	DEC '14
					DRAWING AUTHORISED FOR PUBLICATION	DESIGN	CPO - P&D	DATE	DEC '14




#### **BRISBANE CITY COUNCIL STANDARD DRAWING**

GATE - NATURAL AREA -LOCKING BOXES - NOTES SHEET 1 OF 2

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SCALE AS SH	HOWN	
DWG No.		
BSD-7059		
ORIGINAL SIZE	REVISION	
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#### SINGLE LOCK - LOCKING BOX - ELEVATION

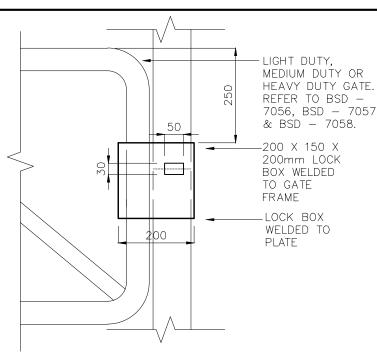

#### SINGLE LOCK - LOCKING BOX - PLAN

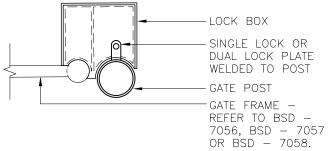SCALE: 1:5


30mm OPENING THROUGH PLATE OF LOCK BOX 10 | 150 🕴 i -150 X 150 X 200mm HOLLOW BASE SINGLE LOCK BOX. CONSTRUCT WITH 10MM PLATE.

#### SINGLE LOCK - SIDE ELEVATION SCALE: 1:10


AMENDMEN1

Drawing Title Amended

ORIGINAL ISSUE

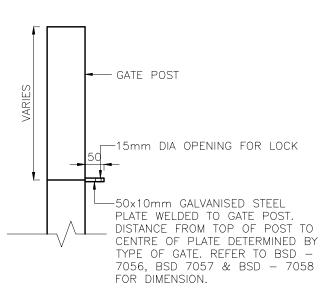

#### SINGLE LOCK - PLATE TO POST DETAIL - ELEVATION SCALE: 1:10

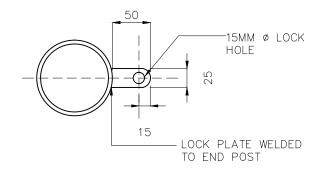

SINGLE LOCK PLATE TO POST DETAIL - PLAN SCALF: 1:5


SENIOR CO-ORDINATOR NATURAL ENVIRONMENT ASSET SERVICES/BRISBANE INFRASTRUCTURE

DEC '14


DRAWN

DEC '14


APPR'D DATE

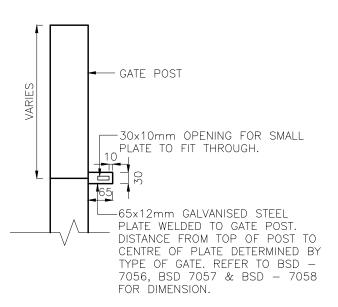

#### DUAL LOCK - PLATE TO POST DETAIL - ELEVATION SCALE: 1:10

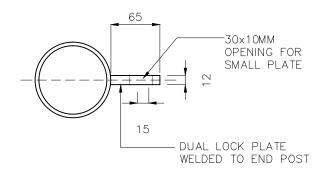

DUAL LOCK PLATE TO DETAIL - PLAN SCALE: 1:5

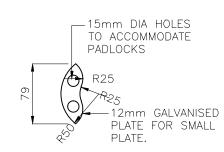


SMALL PLATE - DUAL/MULTIPLE OCK- LOCKING BOX

POST-150 150 SMALL PLATE TO BOTH OPENINGS OF LARGE PLATE. 275 X 65 X 12MM GALVANISED STEEL FLOATING LARGE PLATE. LOCKING BOXES

#### MULTIPLE LOCK -LOCKING BOX - PLAN

SCALE: 1:10

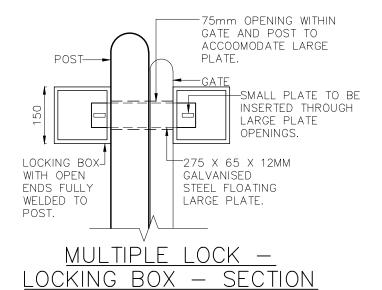

275 X 65 X 12MM GALVANISED STEEL FLOATING PLATE 30 X 10MM OPENING BOTH ENDS FOR SMALL PLATE TO FIT THROUGH 275

SCALE: 1:10

LARGE PLATE - MULTIPLE LOCK - LOCKING BOX SCALE: 1:5

				SCAL	E:
DRAWING AUTHORISED FOR PUBLICATION  Inga Condric 2015.06.04 14:38:45+10'00'  FO ASSET ENGINEERING MANAGER STRATEGIC ASSET MANAGEMENT  DESIGN APPROVED  C. WOOD	DESIGN	CPO - P&D	DATE	DEC '14	
	DRAWN	CPO - P&D	DATE	DEC '14	
	CHECKED	BI - FSG - AS	DATE	DEC '14	
	DRAWING FILENAME	BSD-7059 (B) Gate - Natural area - Locking boxes - Details - Sheet 2 of 2.dwg			

BSD-7059-Sheet 1

ASSOCIATED PLANS

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1:5


#### **BRISBANE CITY COUNCIL STANDARD DRAWING**

GATE - NATURAL AREA -LOCKING BOXES - DETAILS SHEET 2 OF 2

-			ICANTILO	_
	SCALE	AS	SHOWN	
	DWG No.			
		BSD	<del>-7059</del>	
	ORIGINAL SI	ZE	REVISION	
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# 1500 ADJACENT FENCING. 150mm DIA. RECYCLED (FREE MOVING) PLASTIC HOLLOW **BOLLARD WITH GALV. RAIL** INTERNAL. 110mm DIA. GALV. POST, CONCRETE FILLED AND CAPPED

### **PLAN VIEW**

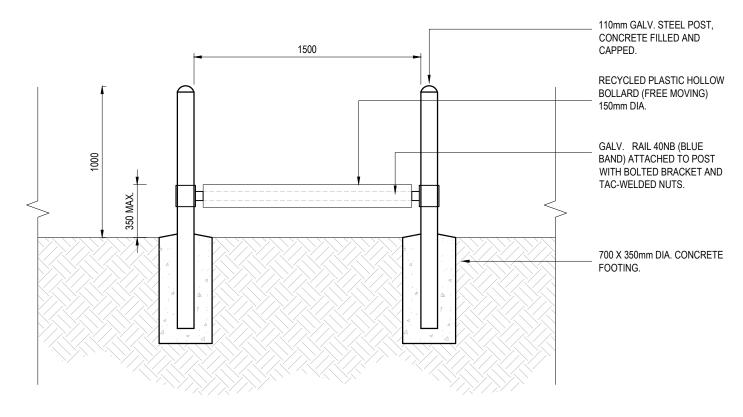

#### HORSE STILE SECTIONAL ELEVATION **SCALE 1:25**

ISSUE	AMENDMENT	DRAWN DATE	CHK'D DATE	APPR'D DATE	SENIOR CO-ORDINATOR NATURAL ENVIRONMENT ASSET SERVICES/BRISBANE INFRASTRUCTURE	ASSOCIATED PLANS			
Α	ORIGINAL ISSUE	DEC '14	DEC '14	DEC '14	DRAWING FILENAME		BSD-7070 (B) Entrance barrier - N	latural area - Sı	mall horse stile.dwg
В	Notes Numbers Amended, AS/NZS Reference to Note FN2 Corrected	SEP '18	APR '19	APR '19	STRATEGIC ASSET MANAGEMENT  DESIGN APPROVED	CHECKED	BI - FSG - AS	DATE	DEC '14
					2015.06.04 14:40:19+10'00' FO <sup>C</sup> ASSET ENGINEERING MANAGER	DRAWN	CPO - P&D	DATE	DEC '14
					DRAWING AUTHORISED FOR PUBLICATION	DESIGN	CPO - P&D	DATE	DEC '14

**GENERAL NOTES** 

- ENSURE THAT WORK IS IN ACCORDANCE WITH BRISBANE CITY COUNCIL ENVIRONMENTAL BEST PRACTICE NOTES.
- SITE SETOUT TO BE VERIFIED BY SUPERINTENDENT OR LANDSCAPE ARCHITECT PRIOR TO THE COMMENCEMENT OF CONSTRUCTION WORKS.
- VERIFY LOCATION OF ALL SERVICES AND EASEMENTS PRIOR TO THE COMMENCEMENT OF WORKS.
- WRITTEN DIMENSIONS TAKE PRECEDENCE OVER SCALED DISTANCES.
- VERIFY ALL DIMENSIONS ON SITE PRIOR TO CONSTRUCTION.
- STRUCTURES HAVE BEEN DESIGNED ON THE ASSUMPTION THAT THE MINIMUM ALLOWABLE BEARING CAPACITY FOR SOIL IS 100KPa AND TERRAIN CATEGORY = 2.5.
- IN EACH CASE ENGINEERING CERTIFICATION AND MODIFICATION AS NECESSARY WILL BE REQUIRED FOR PARTICULAR SOIL AND SITE
- THE COPYRIGHT OF THIS DRAWING REMAINS THE PROPERTY OF THE BRISBANE CITY COUNCIL.
- DIMENSIONS IN MILLIMETRES (U.N.O.).

#### STEELWORK NOTES:

- WHERE STANDARD IS FOR USE IN A NON-MARINE ENVIRONMENT (COULD BE UP TO 1KM FROM THE FORESHORE), THE FOLLOWING PROTECTION TREATMENT IS REQUIRED:
- HOT DIP GALVANISING: FERROUS OPEN SECTIONS TO AS4791.
- FERROUS HOLLOW SECTIONS TO AS4792.
- S2. WHERE STANDARD IS REQUIRED FOR USE WITHIN MARINE ENVIRONMENT, THE FOLLOWING PROTECTION TREATMENT IS REQUIRED:
  - STEELWORK HOT DIP GALVANISING: 85 MICRONS (600g/m²) MIN;
  - SWEEP ABRASIVE BLAST;
  - STEELWORK FIRST COAT: EPOXY PRIMER 75 MICRONS MIN;
  - STEELWORK SECOND COAT: TWO PACK ACRYLIC OR POLYURETHANE GLOSS 75 MICRONS MIN:
- S3. PAINT SYSTEMS TO BE IN ACCORDANCE WITH AS2312 AND IS DESIGNATED HDG600P6 AND HDG600P.
- S4. RAILS TO BE 40 NB (BLUE BAND) GALVANISED STEEL TUBE TO AS/NZ1163.
- S5. GALVANISED STEEL POSTS TO BE 110mm DIAMETER, CONCRETE FILLED AND CAPPED.

#### **FOOTINGS**

FT1. AS DETAILED. CONCRETE TO BE N25, MAX AGGREGATE SIZE 20mm, MAX

#### **FIXINGS**

FX1. STEP OVER RAILS TO BE FIXED WITH BOLTED BRACKET AND TAC-WELDED NUTS (TO ALLOW REPLACEMENT OF PLASTIC SLEEVE AS NECESSARY)

#### **FINISHES**

- FN1. ALL ADJACENT RAILS ARE SWAGED AND WELDED. SWAGES TO BE ON INSIDE OF FENCE AND NOT FACING PUBLIC ROADS, ETC).
- FN2. ALL JOINTS TO BE FULLY WELDED. WELDS TO BE 5 THICK C.F.W (CONTINUOUS FILLET WELDS) TO AS/NZS1554.1 WITH COLD GALVANISING TREATMENT TO COMPLETED WELDS.
- FN3. PREFERRED COLD GALVANISING TREATMENT FOR IN-SITU WELDS, CUT ENDS OR OTHER BARE STEEL IS TO APPLY 2 COATS OF INORGANIC ZINC PRIMER APPLIED BY BRUSH
- FN4. NO SHARP PROTRUSIONS OR UNPROTECTED RAIL ENDS WITHIN HORSE STILE STRUCTURE.

#### RECYCLED PLASTIC MATERIAL NOTES


- R1. RECYCLED PLASTIC BOLLARDS TO BE 150mm DIAMETER; (SUPPLIED BY BCC FOR INSTALL).
- R2. PLASTIC SLEEVE ON STEP-OVER RAILS TO BE FREE MOVING.
- R3. SECTIONS TO BE FORMED FROM A SINGLE CONTINUOUSLY EXTRUDED PIECE.
- R4. MATERIAL TO BE UV STABILISED.
- R5. POROSITY TO A MAXIMUM OF 15% OF CROSS SECTION.
- R6. MAXIMUM VOID LENGTH 10% OF LARGEST CROSS SECTION.
- R7. SURFACE FINISH TO BE SMOOTH AND FREE OF ANY MAJOR VOIDS OR VISIBLE DEFECTS
- R8. COLOUR TO BE CHOSEN FROM AVAILABLE SUPPLIER COLOURS, TYPICALLY GREEN.
- R9. MATERIAL TO HAVE FLAMMABILITY TESTING TO AS/ISO9239.1 AND/OR FIRE HAZARD RATING TO AS/NZS1530.3.
- R10. DEMONSTRATED CHEMICAL RESISTANCE.

<u> </u>	BRIS
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BRISBANE CITY	

#### SBANE CITY COUNCIL STANDARD DRAWING

**ENTRANCE BARRIER** NATURAL AREA SMALL HORSE STILE

_	DAND DI	MILLIO
	SCALE AS SH	IOWN
	DWG No. BSD-	7070
	ORIGINAL SIZE	REVISION B

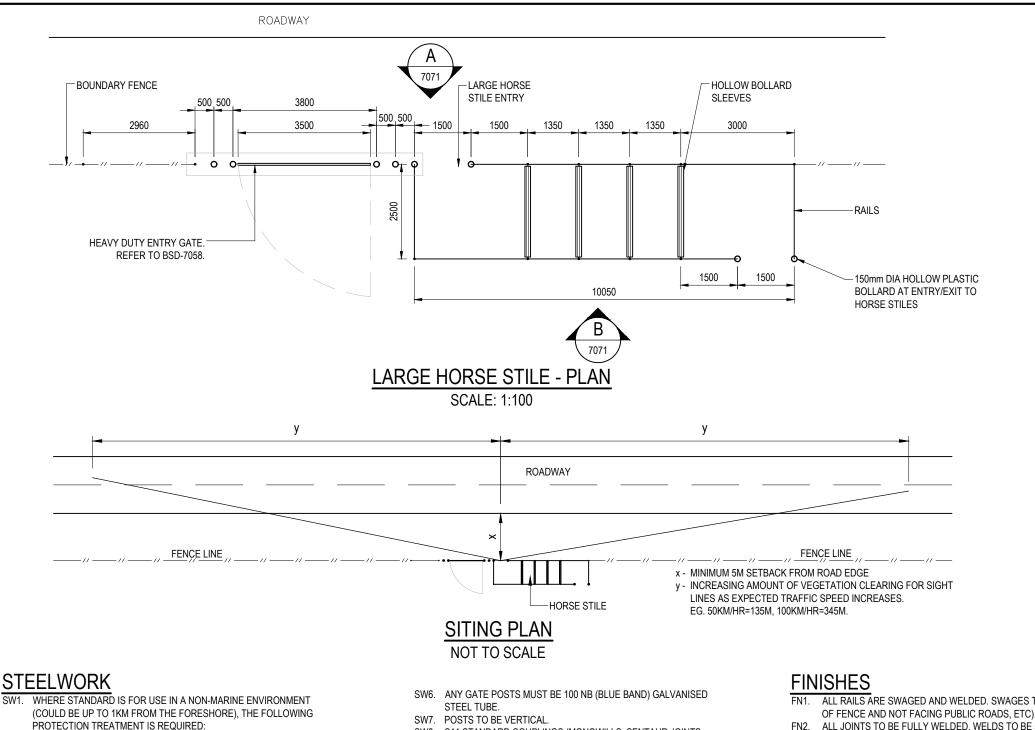

- ALL RAILS ARE SWAGED AND WELDED. SWAGES TO BE ON INSIDE
- ALL JOINTS TO BE FULLY WELDED. WELDS TO BE 5 THICK C.F.W (CONTINUOUS FILLET WELDS) TO AS/NZS1554.1 WITH COLD GALVANISING TREATMENT TO COMPLETED WELDS.
- PREFERRED COLD GALVANISING TREATMENT FOR IN-SITU WELDS, CUT ENDS OR OTHER BARE STEEL IS TO APPLY 2 COATS OF INORGANIC ZINC PRIMER APPLIED BY BRUSH.
- GATE HINGES TO BE WELDED (NOT BOLTED BRACKETS).
- NO SHARP PROTRUSIONS OR UNPROTECTED RAIL ENDS WITHIN HORSE STILE STRUCTURE.

#### **GENERAL NOTES**

- ENSURE THAT WORK IS IN ACCORDANCE WITH BRISBANE CITY COUNCIL ENVIRONMENTAL BEST PRACTICE NOTES.
- SITE SETOUT TO BE VERIFIED BY SUPERINTENDENT OR LANDSCAPE ARCHITECT PRIOR TO THE COMMENCEMENT OF CONSTRUCTION WORKS
- VERIFY LOCATION OF ALL SERVICES AND EASEMENTS PRIOR TO THE COMMENCEMENT OF WORKS.
- WRITTEN DIMENSIONS TAKE PRECEDENCE OVER SCALED DISTANCES.
- VERIFY ALL DIMENSIONS ON SITE PRIOR TO CONSTRUCTION.
- STRUCTURES HAVE BEEN DESIGNED ON THE ASSUMPTION THAT THE MINIMUM ALLOWABLE BEARING CAPACITY FOR SOIL IS 100KPa AND TERRAIN CATEGORY = 2.5.
- IN EACH CASE ENGINEERING CERTIFICATION AND MODIFICATION AS NECESSARY WILL BE REQUIRED FOR PARTICULAR SOIL AND SITE CONDITIONS
- THE COPYRIGHT OF THIS DRAWING REMAINS THE PROPERTY OF THE BRISBANE CITY COUNCIL.
- DIMENSIONS IN MILLIMETRES (UNO).

#### SITING NOTES

- SN1. IF HORSE STILE IS LOCATED NEAR A ROAD/CARRIAGEWAY. SETBACK SHOULD BE A MINIMUM OF 5m AND ROADSIDE ADVISORY SIGNS INSTALLED ACCORDING TO SIGHT LINE PRINCIPLES. DISTANCE FROM CROSSING POINT IS DEPENDENT UPON THE MAXIMUM SPEED OF APPROACHING TRAFFIC REFER TO SITING
- A HOLDING AREA OF APPROX 10 X 5m ON ROAD/CARRIAGEWAY VERGE (EDGE) WILL PROVIDE SPACE FOR HORSE AND RIDER TO WAIT UNTIL IT IS SAFE TO CROSS.
- HOLDING AREA ON ROAD VERGE NEEDS TO BE CLEAR OF VEGETATION OR OTHER OBSTRUCTIONS TO ENSURE SIGHT LINES TO AND FROM THE HORSE STILE ENTRANCE IS MAINTAINED.
- SIGHT LINES TO BE CLEAR OF VEGETATION BETWEEN 1-5m HEIGHT WITH THE COMPLETE REMOVAL OF ANY TREES/SHRUBS <150mm DBH (DIAMETER AT BREAST HEIGHT). ENSURE APPROPRIATE APPROVALS ARE RECEIVED PRIOR TO ANY REMOVALS.

#### RECYCLED PLASTIC MATERIAL

R6

- PLASTIC SLEEVE ON STEP-OVER RAILS TO BE FREE MOVING.
- SECTIONS TO BE FORMED FROM A SINGLE CONTINUOUSLY EXTRUDED PIECE.
- MATERIAL TO BE UV STABILISED.
- POROSITY TO A MAXIMUM OF 15% OF CROSS SECTION.
- MAXIMUM VOID LENGTH 10% OF LARGEST CROSS SECTION.
- SURFACE FINISH TO BE SMOOTH AND FREE OF ANY MAJOR VOIDS OR VISIBLE DEFECTS.
- COLOUR TO BE CHOSEN FROM AVAILABLE SUPPLIER COLOURS, TYPICALLY GREEN.
- MATERIAL TO HAVE FLAMMABILITY TESTING TO AS/ISO9239.1 AND/OR FIRE HAZARD RATING TO AS/NZS1530.3.
- R9. DEMONSTRATED CHEMICAL RESISTANCE.

#### COUNCIL **FOOTINGS**

HOT DIP GALVANISING: FERROUS OPEN SECTIONS TO AS4791.

STEELWORK HOT DIP GALVANISING: 85 MICRONS (600g/m²) MIN;

STEELWORK FIRST COAT: EPOXY PRIMER 75 MICRONS MIN;

ALL POSTS TO BE 50 NB (BLUE BAND) GALVANISED STEEL TUBE TO

STEELWORK SECOND COAT: TWO PACK ACRYLIC OR

RAILS TO BE 40 NB (BLUE BAND) GALVANISED STEEL TUBE TO

ENVIRONMENT, THE FOLLOWING PROTECTION TREATMENT IS

FERROUS HOLLOW SECTIONS TO AS4792.

POLYURETHANE GLOSS 75 MICRONS MIN;

DESIGNATED HDG600P6 AND HDG600P

SW3. PAINT SYSTEMS TO BE IN ACCORDANCE WITH AS2312 AND IS

SWEEP ABRASIVE BLAST:

REQUIRED:

AS/NZ1163.

SW5.

SW2. WHERE STANDARD IS REQUIRED FOR USE WITHIN MARINE

AS DETAILED, CONCRETE TO BE N25, MAX AGGREGATE SIZE 20mm. MAX SLUMP 80mm.

SW8. S11 STANDARD COUPLINGS (MONOWILLS, SENTAUR JOINTS.

KEE-KLAMP, SWAGED JOINTS OR SIMILAR) FOR POST TO RAIL

CONNECTIONS MAY BE USED AS AN ALTERNATIVE TO WELDS

SPECIALIST COUPLINGS MAY BE USED UPON APPROVAL FROM

STANDARD COUPLINGS. FOR ANGLES GREATER THAN 11°,

WHERE APPROVED. 11° MAX REFLECTION FROM HORIZONTAL FOR

#### **FIXINGS**

STEP OVER RAILS TO BE FIXED WITH BOLTED BRACKET AND TAC-WELDED NUTS (TO ALLOW REPLACEMENT OF PLASTIC SLEEVE AS NECESSARY)


#### DRAWING AUTHORISED FOR PUBLICATION DESIGN CP0 - P&D DATE DEC '14 Inga Condric 2015.06.04 14:41:05+10'00' Fo<sup>f</sup> ASSET ENGINEERING MANAGER DRAWN P0 - P&D DATE DEC '14 STRATEGIC ASSET MANAGEMENT CHECKED BI - FSG - AS DATE DEC '14 Notes Numners Amended, AS/NZS Reference to Note FN2 Corrected SEP '18 APR '19 APR '19 DESIGN APPROVED DRAWING FILENAME BSD-7071 (B) Entrance barrier - Natural area - Large horse stile - Sheet 1 of 2.dw ORIGINAL ISSUE DEC '14 DEC '14 DEC '14 DRAWN APPR'D SENIOR CO-ORDINATOR NATURAL ENVIRONMENT ASSET SERVICES/BRISBANE INFRASTRUCTURE ISSUE BSD-7071-Sheet 2 AMENDMENT DATE




#### **BRISBANE CITY COUNCIL STANDARD DRAWING**


**ENTRANCE BARRIER -**NATURAL AREA - LARGE HORSE STILE - SHEET 1 OF 2

	<u> </u>	
scale AS SH	HOWN	
BSD-7071		
ORIGINAL SIZE A3	REVISION B	

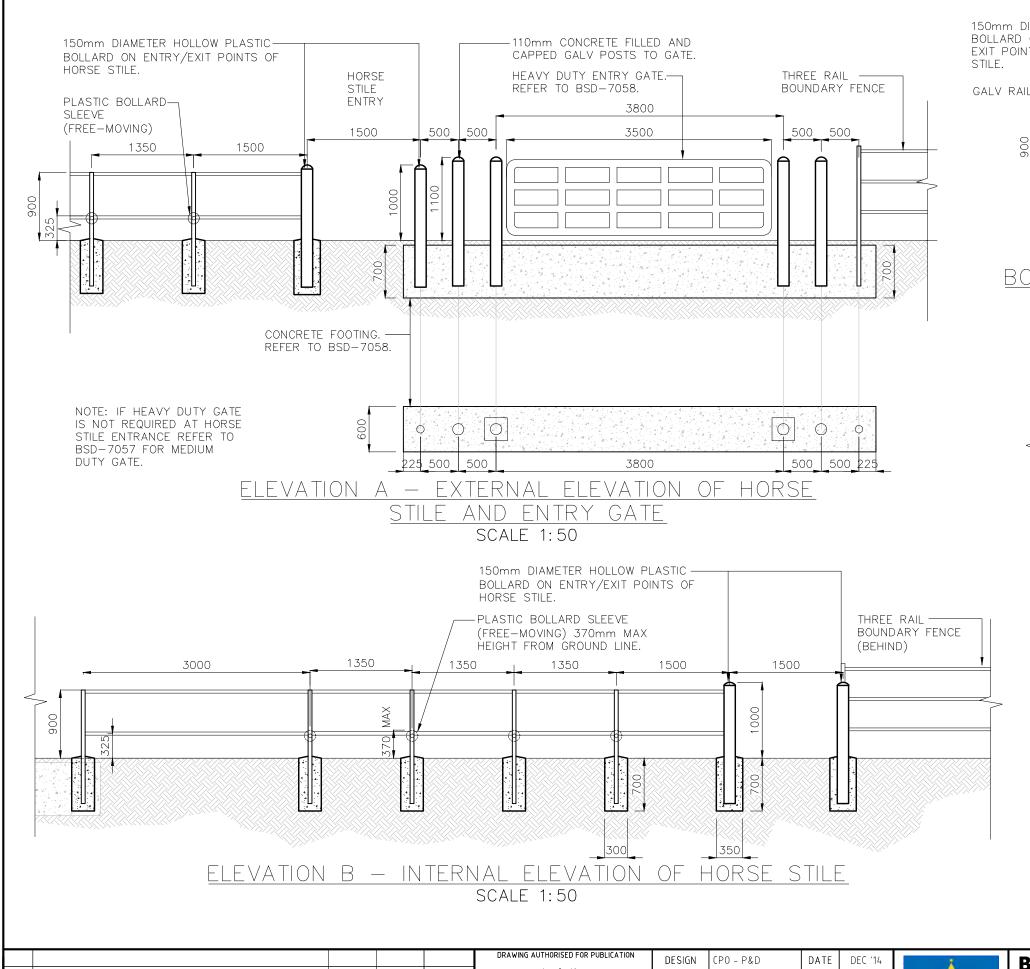

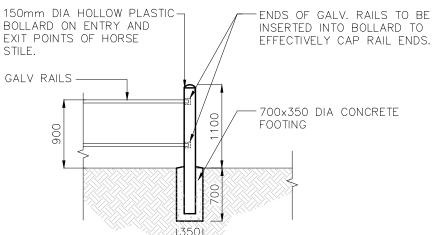

## BOLLARD AND RAIL DETAIL SCALE 1:50

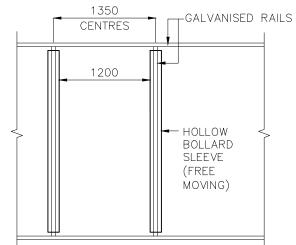

HORSE STILE DETAIL SCALE 1:50

#### NOTES

- 1. GALVANISED STEEL GATE POSTS AND BOLLARDS TO BE 110mm DIAMETER, CONCRETE FILLED AND CAPPED.
- 2. RECYCLED PLASTIC BOLLARDS TO BE 150mm DIAMETER.
- 3. GATE HINGES TO BE WELDED (NOT BOLTED BRACKETS).
- 4. GATE LOCKING ASSEMBLY TO BE EITHER HIGH TENSILE CHAIN WELDED TO GATE POST OR A PROTECTIVE BOX SET—UP TO HOUSE THE LOCK.
- 5. STEP OVER RAILS TO BE FIXED WITH BOLTED BRACKET AND TAC—WELDED NUTS. (TO ALLOW REPLACEMENT OF PLASTIC SLEEVE AS NECESSARY).
- 6. NO SHARP PROTRUSIONS OR UNPROTECTED RAIL ENDS WITHIN HORSE STILE STRUCTURE.
- 7. PLASTIC SLEEVE ON STEP-OVER RAILS NEED TO BE FREE MOVING.


ISSUE	AMENDMENT	DRAWN DATE	CHK'D DATE	APPR'D DATE	C.Wood SENIOR CO-ORDINATOR NATURAL ENVIRONMENT ASSET SERVICES/BRISBANE INFRASTRUCTURE	FILENAME ASSOCIATED PLANS	BSD-7071-Sheet 1	rea - Lai ye iivi se	SINC - SHEEL Z VI ZAMY
	ORIGINAL ISSUE	DEC '14	DEC '14	DEC '14		DRAWING	BSD-7071 (A) Entrance barrier - Natural a	ras _ l sena harca	ctila _ Shaat 2 of 2 dwn
					DESIGN APPROVED	CHECKED	BI - FSG - AS	DATE	DEC '14
					STRATEGIC ASSET MANAGEMENT	SUESWED	D. 566 16	5.75	555.44
					2015.06.04 14:41:47+10'00' FO <sup>f</sup> ASSET ENGINEERING MANAGER	DRAWN	CPO - P&D	DATE	DEC '14
					Inga Condric				
					DRAWING AUTHORISED FOR PUBLICATION	DESIGN	(P0 - P&D	DATE	DEC '14



#### **BRISBANE CITY COUNCIL STANDARD DRAWING**

ENTRANCE BARRIER —
NATURAL AREA — LARGE
HORSE STILE — SHEET 2 OF 2

SCALE AS S	HOWN
DWG No.	
BSD-	-7071
ORIGINAL SIZE	REVISION
Α3	А

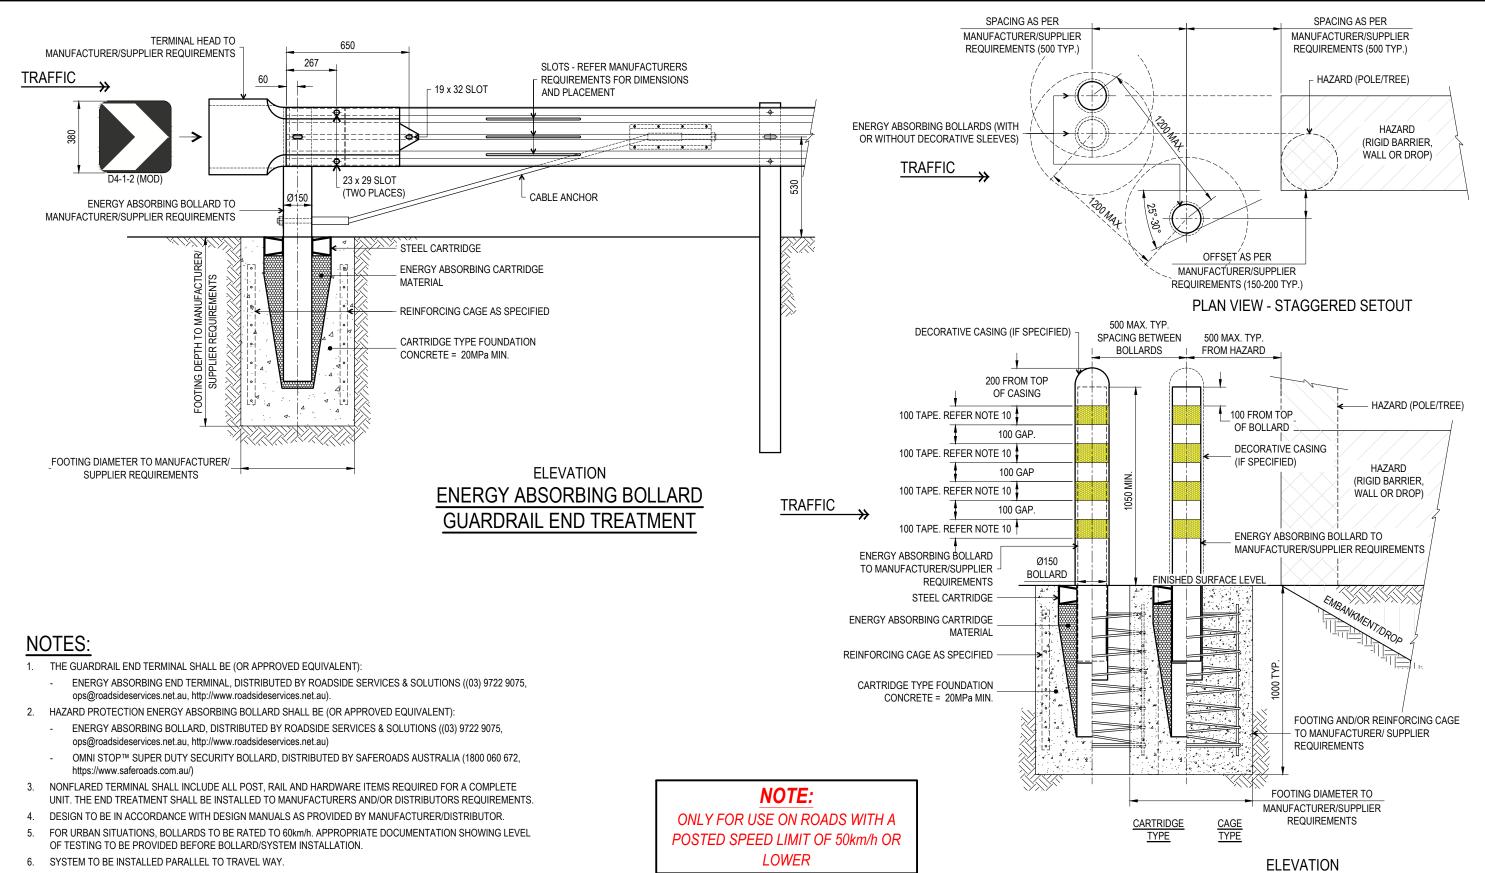

**ENERGY ABSORBING BOLLARD** HAZARD PROTECTION TREATMENT

THE PURPOSE OF THIS STANDARD DRAWING IS TO PROVIDE TYPICAL DETAILS THAT SUPPORT THE DESIRED OUTCOMES OF THE BRISBANE CITY PLAN 2014 AND ASSOCIATED PLANNING SCHEME POLICIES. THE FITNESS FOR PURPOSE OF THIS STANDARD DRAWING FOR A SPECIFIC PROJECT SHOULD BE ASSESSED AND ACCEPTED BY AN APPROPRIATELY QUALIFIED DESIGNER AND/OR REGISTERED PROFESSIONAL ENGINEER OF QUEENSLAND (RPEQ).



#### BRISBANE CITY COUNCIL STANDARD DRAWING

ENERGY ABSORBING BOLLARD **GUARDRAIL END TERMINAL** & HAZARD PROTECTION

DEC 2023 NOT TO SCALE RAWING NUMBER BSD-7091 ORIGINAL SIZE D

WHERE BOLLARD INSTALLED WITH PAINTED OR POWDERCOATED FINISH OR WITH DECORATIVE COVER, COLOUR IS TO COMPLEMENT SURROUNDING STREETSCAPE. COLOUR SELECTION IN ACCORDANCE WITH STANDARD BRISBANE CITY COUNCIL CORPORATE COLOUR PALETTE - REFER BSD-1003 FOR DETAILS. ENERGY ABSORBING BOLLARDS FOR HAZARD PROTECTION TO HAVE FOUR (4) 100mm WIDE BANDS OF CLASS 1

DELINEATOR ON GUARDRAIL END TREATMENT END BUFFER TO HAVE CLASS 1 RETROREFLECTIVE BACKGROUND

WITH BLACK NONREFLECTIVE PATTERN. DELINEATOR TO MATCH AS1742 SIGN D4-1-2 AND BE MODIFIED TO 380

ENERGY ABSORBING BOLLARD FOR HAZARD PROTECTION EITHER TO BE LEFT PLAIN (GALVANISED FINISHED), PAINTED OR POWDERCOATED, OR INSTALLED WITH SECURED DECORATIVE COVER AS SUPPLIED BY

YELLOW RETROREFLECTIVE TAPE AT 100mm SPACING.

11. ALL DIMENSIONS IN MILLIMETRES (U.N.O.).

MAX. SQUARE TO FIT END OF GUARDRAIL

#### GENERAL NOTES & SPECIFICATIONS

- ENSURE BOLLARDS & BOUNDARY MARKERS ARE LOCATED IN ACCORDANCE WITH DETAILED LANDSCAPE PLAN AND PARKS CHAPTER OF INFRASTRUCTURE DESIGN PLANNING SCHEME POLICY
- AUSTRALIAN STANDARDS SHALL BE IN ACCORDANCE WITH THE CURRENT EDITIONS OF THE REFERENCED AUSTRALIAN STANDARDS EXCEPT WHERE VARIED BY SPECIFICATIONS AND/OR DRAWINGS.
- MATERIAL CHOICES ARE TO BE DETERMINED ON THE GROUNDS OF SUSTAINABILITY, LOW
  MAINTENANCE, VANDAL RESISTANCE, PRODUCT AVAILABILITY AND SUITABILITY TO THE CLIMATIC
  CONDITIONS. WHERE POSSIBLE, MATERIALS ARE TO BE SOURCED LOCALLY.
- ENSURE BOLLARDS & POSTS ARE CLEANED OF CONCRETE SLURRY OR SPRAY WHEN INSTALLED TO PREVENT STAINING OR DAMAGE TO APPLIED FINISHES.
- COLOUR SELECTION IN ACCORDANCE WITH STANDARD BCC CORPORATE COLOUR PALETTE (& AS 2700 EQUILIVALENT). IF NO COLOUR SPECIFIED, BOLLARD AND MARKER TO BE INSTALLED AS MANUFACTURED.
- BOLLARDS TO BE LOCATED ON PARK BOUNDARY, OR SET BACK 500mm FROM EDGE OF INTERNAL ROAD, SPACE BOLLARDS AT 1500mm APART IN A STRAIGHT LINE, AS DIRECTED OR AS SHOWN ON PLAN.
- FOR BOUNDARY MARKER ONLY REFER BSD-10003 FOR SUPPLIER OF MOULD FOR THE CAST CAP ENSURE CAPPING DETAIL IS AS SHOWN ON THIS DRAWING, INCLUDING CURRENT BCC LOGO. REFER BSD-10003 FOR LIST OF MARKER SUPPLIERS. POSITION BOUNDARY MARKERS AT CORNER OF COUNCIL BOUNDARY, AT CHANGES IN BOUNDARY DIRECTIONS. INCLUDE BOLLARDS BETWEEN CORNERS AND/OR CHANGES IN DIRECTION WHERE THE PARK BOUNDARY IS NOT OBVIOUS. (OR AS OTHERWISE SPECIFIED).
- <u>FOR BOUNDARY MARKER ONLY</u> <u>-</u> LETTERING TO BE ARIAL FONT TO THE SIZES SPECIFIED IN CAST CAP DETAIL. ALL LETTERS TO BE SPACED EVENLY.
- FOR HERITAGE BOLLARDS ONLY DECORATIVE TOP TO CONSIST OF TWO ROUTED REBATES.
   REBATES TO BE STRAIGHT, PARALLEL TO EACH OTHER & AT RIGHT ANGLES TO POST. ENSURE ALL REBATES ARE CLEANED OF ANY SPLINTERS OR SHARDS.
- ALL DIMENSIONS IN MILLIMETRES (U.N.O.).

#### FIXTURES/FITTINGS & METAL WORK NOTES

- ALL WORKMANSHIP AND MATERIAL SHALL BE IN ACCORDANCE WITH AS 4100 & AS/NZS 1554.
- ALL METAL FINISHES TO BE IN ACCORDANCE WITH AS 4506.
- ALL FIXTURES/FITTINGS UNLESS SPECIFIED ARE TO BE HOT DIPPED GALVANISED UNLESS IN VICINITY OF SALTWATER/SPRAY, ENSURE ALL FASTENERS SHALL BE STAINLESS STEEL. PLASTIC SEPARATORS SHALL BE PROVIDED TO AVOID CONTACT BETWEEN DISSIMILAR MATERIALS. STAINLESS STEEL GRADE 316 TO BE USED. WHERE POSSIBLE ALL FIXINGS TO BE TAMPER/VANDAL PROOF TO MINIMISE DAMAGE OR THEFT.
- ALL WELDS TO BE CONTINUOUS FILLET WELDS, GROUND OFF SMOOTH & FLUSH IN ACCORDANCE WITH AS 1554. GRIND SMOOTH EDGES & WELDS PRIOR TO HOT DIPPED GALVANISING OR APPLIED FINISHES.

#### CONCRETE WORK NOTES

- ALL WORKMANSHIP AND MATERIAL SHALL BE IN ACCORDANCE WITH AS 3600.
- AT A MINIMUM ALL CONCRETE TO BE GRADE N25. CONCRETE SHALL BE NORMAL CLASS
   CONCRETE UNLESS DIRECTED OTHERWISE. N25 SHALL MEAN NORMAL CLASS CONCRETE WITH A
   28 DAY CHARACTERISTIC STRENGTH OF 25MPa. CONCRETE MIX DESIGN SHALL BE SUBMITTED
   TO THE SITE SUPERINTENDENT FOR APPROVAL FIVE (5) DAYS PRIOR TO ORDERING.
- ALL CEMENT TO BE TYPE GP OR GB TO AS 3972 UNLESS SPECIFIED OTHERWISE.
- NORMAL AGGREGATE SIZE TO BE 20mm, SLUMP TO BE NOT GREATER THAN 80mm.
- THE BOTTOMS OF ALL FOOTINGS ARE TO BE CLEANED OF ALL LOOSE MATERIAL AND WATER PRIOR TO PLACING CONCRETE.

#### TIMBER WORK NOTES

- TIMBER SHOULD BE SOURCED FROM LEGAL AND SUSTAINABLE SOURCES. TIMBERS ARE CONSIDERED ACCEPTABLE WHERE THERE IS A HIGH DEGREE OF CERTAINTY THAT THEY ARE FROM FORESTS, EITHER NATIVE OR PLANTATION, THAT ARE LEGALLY HARVESTED AND SUSTAINABLY MANAGED. THE CONTRACTOR IS TO SUBMIT EVIDENCE THAT THE TIMBER HAS BEEN OBTAINED FROM A LEGAL AND SUSTAINABLE SOURCE.
- ALL TIMBER TO BE ACQ PRESSURE TREATED OR TANALITH E (COPPER AZOL) TO AS1608
   TREATED ROUGH SAWN APPEARANCE GRADE HARDWOOD OF ONE SPECIES.
- ALL EXPOSED EDGES TO RECEIVE MIN. 5mm WIDE ARRIS.
- PRIOR TO INSTALLATION, ALL CUTS, EDGES, JOINTS TO RECEIVE LIBERAL COATINGS WITH AN APPROVED TIMBER PRESERVATIVE.
- ALL TIMBER IN CONTACT WITH GROUND TO BE PRESERVATIVE TREATED TO HAZARD CLASS H5
  TO AS 1604 AND HAVE A DURABILITY CLASS 1 OR 2 TO AS 5604.
- ALL TIMBER TO BE FREE OF KNOTS, SPLINTERS, CRACKS OR ANY MAJOR DEFECT.
- TIMBER PRESERVATIVES WHERE NO FINISH SPECIFIED, ALL TIMBER TO RECEIVE 3 No COATS
  OF CLEAR APPROVED TIMBER PRESERVATIVE SUCH AS COPPER NAPTHENATE OIL (FOR ABOVE
  GROUND USE) AND COPPER NAPTHENATE EMULSION (FOR BELOW GROUND USE) COAT
  ENTIRE BOLLARD PRIOR TO PLACING.
- COLOUR SELECTION WHERE APPLICABLE IN ACCORDANCE WITH STANDARD CORPORATE COLOUR PALETTE. COAT ENTIRE BOLLARD PRIOR TO PLACING.

#### RECYCLED PLASTIC NOTES

- SECTIONS TO BE FORMED FROM A SINGLE, CONTINUOUSLY EXTRUDED PIECE.
- MATERIAL TO BE UV STABILISED.
- POROSITY TO A MAXIMUM OF 15% OF CROSS SECTION.
- MAXIMUM VOID LENGTH 10% OF LARGEST CROSS SECTION.
- SURFACE FINISH TO BE SMOOTH AND FREE OF ANY MAJOR VOIDS OR VISIBLE DEFECTS.
- SIZE IS INDICATIVE VARIANCE NOT TO EXCEED APPROXIMATELY 1.5%.
- COLOUR TO BE CHOSEN FROM AVAILABLE SUPPLIER COLOURS, TYPICALLY GREEN, BLACK, GREY OR BLUE.
- MATERIAL TO HAVE FLAMMABILITY TESTING TO AS ISO TO AS/ISO 9239 AND/OR FIRE HAZARD RATING TO AS/NZS 1530.
- DEMONSTRATED CHEMICAL RESISTANCE.

REFER TO BSD-7093, BSD-7094 & BSD-7099 FOR ASSOCIATED DETAILS.


ISSUE	AMENDMENT	DRAWN DATE	CHK'D DATE	APPR'D DATE	PRICIPAL PROGRAM OFFICER PARKS	ASSOCIATED PLANS	SUPERSEDES NOTES ON U	MS-721, 722	, 723, & 724
Α	Drawing Converted From UMS Series April 2014	APR '14	APR '14	APR '14	LAUREN TEMPLEMAN SIGNATURE ON ORIGINAL DATED 31/08/04	DRAWING FILENAME	BSD-7092 (A) Park bollards and bo	undary markers	- General notes.dwg
					R.P.E.Q: 2546 DESIGN APPROVED	CHECKED	UMD - E&P & IMB	DATE	OCT '13
					03/09/0/	DRAWN	CPO - P&D	DATE	OCT '13
					DRAWING AUTHORISED FOR PUBLICATION PAUL COTTON SIGNATURE ON ORIGINAL DATED	DESIGN	Std Dwgs WG	DATE	OCT '13



#### **BRISBANE CITY COUNCIL STANDARD DRAWING**


PARK BOLLARDS AND BOUNDARY MARKERS — GENERAL NOTES

SCALE	AS	SI	HOWN	
BWG No.				
E	3SD	_	7092	
ORIGINAL SIZE			REVISION	
A	43		А	

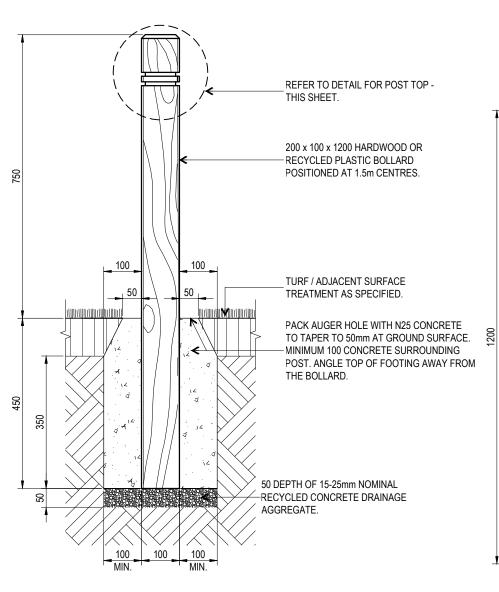


#### **HERITAGE BOLLARD - SECTION**

SCALE: 1:10

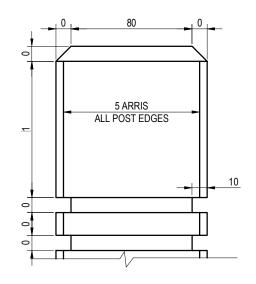


#### **POST TOP - DETAIL ELEVATION**

SCALE: 1:2

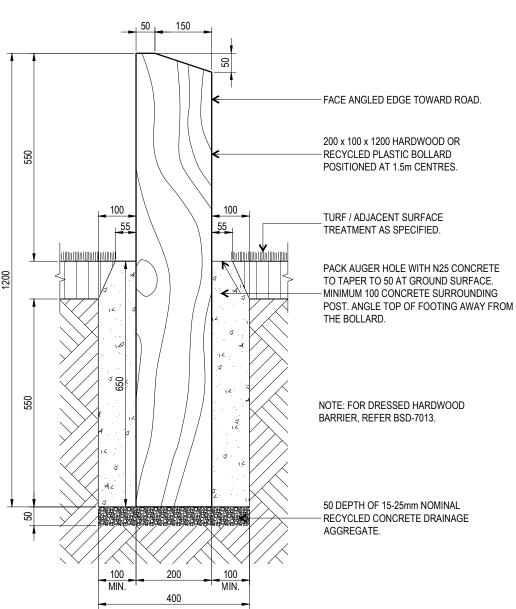

### ANGLED TOP HARDWOOD BOLLARD - SECTION

SCALE: 1:10

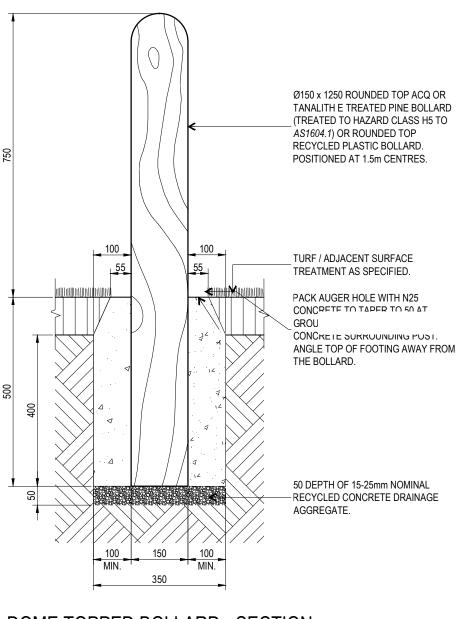

### **DOME TOPPED BOLLARD - SECTION**

SCALE: 1:10

THE PURPOSE OF THIS STANDARD DRAWING IS TO PROVIDE TYPICAL DETAILS THAT SUPPORT THE DESIRED OUTCOMES OF THE BRISBANE CITY PLAN 2014 AND ASSOCIATED PLANNING SCHEME POLICIES. THE FITNESS FOR PURPOSE OF THIS STANDARD DRAWING FOR A SPECIFIC PROJECT SHOULD BE ASSESSED AND ACCEPTED BY AN APPROPRIATELY QUALIFIED DESIGNER AND/OR REGISTERED PROFESSIONAL ENGINEER OF QUEENSLAND (RPEQ).




#### BRISBANE CITY COUNCIL STANDARD DRAWING

BOLLARD - PARKS -HERITAGE, ANGLE AND DOME-TOPPED PUBLISH DATE
JUN 2023
SCALE
AS SHOWN
DRAWING NUMBER
BSD-7093

BSD-7093


ORIGINAL SIZE REVISION

REFER TO BSD-7092 FOR ASSOCIATED SPECIFICATION NOTES.

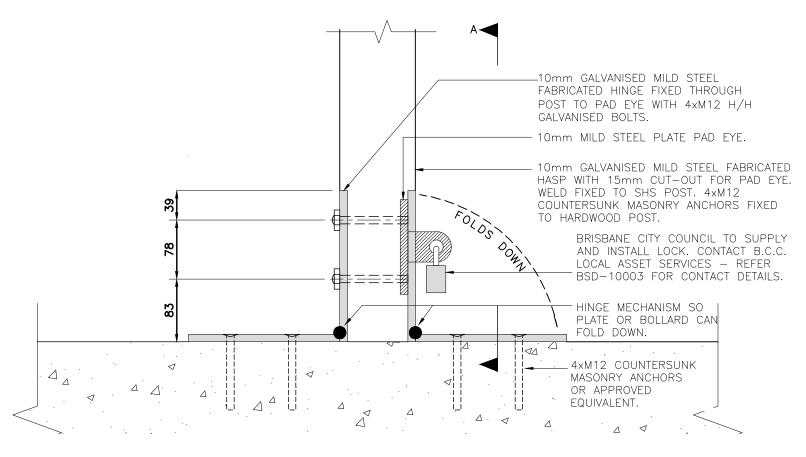


### REMOVABLE BOLLARD — HINGE DETAIL SCALE: 1:5

ISSUE	AMENDMENT	DRAWN DATE	CHK'D DATE	APPR'D DATE	PRICIPAL PROGRAM OFFICER PARKS	PAL PROGRAM OFFICER PARKS ASSOCIATED SUPERSEDES UMS-724			
А	Drawing Converted From UMS Series April 2014	APR '14	APR '14	APR '14	LAUREN TEMPLEMAN SIGNATURE ON ORIGINAL DATED 31/08/04	DRAWING FILENAME	BSD-7094 (A) Bollard - Parks ar	nd natural are	ıs - Removable.dwg
					R.P.E.Q: 2546 DESIGN APPROVED	CHECKED	UMD - E&P & IMB	DATE	OCT '13
					03/09/04 MANAGER INFRASTRUCTURE MANAGEMENT	DRAWN	CPO - P&D	DATE	OCT '13
					DRAWING AUTHORISED FOR PUBLICATION PAUL COTTON SIGNATURE ON ORIGINAL DATED	DESIGN	Std Dwgs WG	DATE	OCT '13

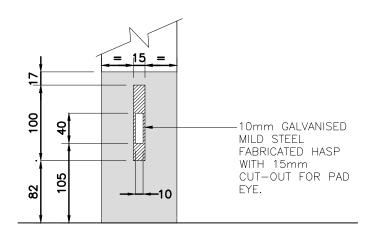

# REMOVABLE BOLLARD — SECTION A-A — PAD EYE DETAIL SCALE: 1:5

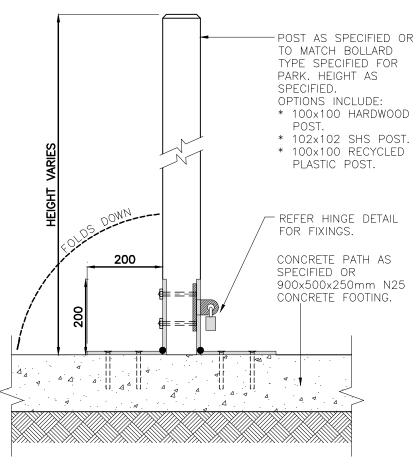


REMOVABLE BOLLARD — SECTION SCALE: 1:10



#### **BRISBANE CITY COUNCIL STANDARD DRAWING**

BOLLARD — PARKS AND NATURAL AREAS — REMOVABLE

DAN	ט ט	NAV	ATIAC
SCALE	AS	NOHZ	1
DWG No.			
F	350	_70	94
		, 0	<b>J</b> 1
ORIGINAL SIZE		REVISION	
Δ	7.3		Δ
	SCALE BWG No.	SCALE AS DWG No. BSD	BSD-70

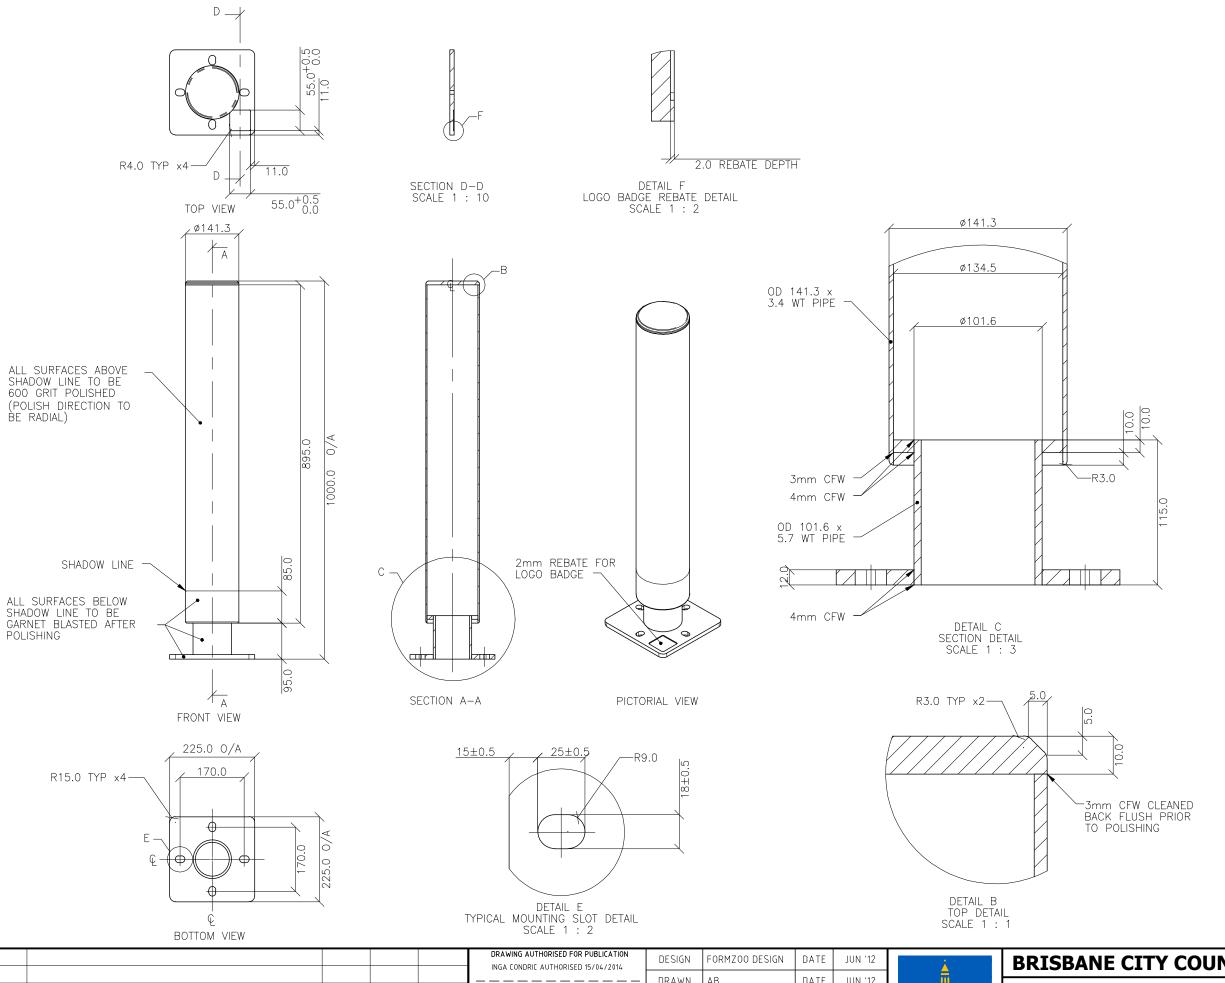

DESIGNED IN ACCORDANCE WITH, AND FABRICATION TO MEET THE FOLLOWING STANDARDS:

- AS1428.4.1:2009, TACTILE GROUND SURFACE INDICATORS FOR THE ORIENTATION OF PEOPLE WITH VISION IMPAIRMENT.
  - AS1627.4 METAL FINISHING -PREPARATION AND PRE-TREATMENT OF SURFACES - ABRASIVE BLAST CLEANING OF STEEL.
- AS2312:2002/AMDT 1:2004, GUIDE TO PROTECTION OF IRON AND STEEL AGAINST EXTERIOR ATMOSPHERIC CORROSION, 1994.
- GUIDE TO ENGINEERING PRACTICE, 'PEDESTRIANS', PART 13, AUSTROADS.
- AUSTRALIAN ROAD RULES , 1999,
- WWW.NRTC.GOV.AU
  AS4506 -2005, METAL FINISHINGTHERMOSET POWDER COATINGS.
  AS4680:2006, HOT DIP
- GALVANISING. AS 1742.10— 2009 MANUAL OF UNIFORM TRAFFIC CONTROL DEVICES: 'PEDESTRIAN CONTROL AND PROTECTION'

#### NOTES

- WELDING TO BE ACCORDANCE TO AS1554.1 CAT GP WELDING, ALL SHARP EDGES & BURRS REMOVED.
- PART SHOULD BE SUPPLIED CLEAN AND FREE FROM MARKS, BURRS, SCUFFS, DISTORTION AND WARPAGE.
- ENSURE ANTI-SEIZE IS ON ALL NUTS AND BOLTS PRIOR TO ASSEMBLY.
- DRAWING TO AS1100 DRAWING 4.
- STANDARDS.
  316 S.S AND 316 S.S FASTENERS
  TO BE USED THROUGHOUT FOR
  COASTAL INSTALLATIONS OR ANY ENVIRONMENT WITH HIGH
- ALL TOLERANCES ± 1.5mm UNLESS OTHERWISE SPECIFIED.

#### MATERIAL

- MATERIAL: 316 STAINLESS STEEL
- COLOUR: NATURAL
- FINISH: 600 GRIT POLISH / GARNET BLASTED

#### STRUCTURAL DESIGN REVIEWED AND CERTIFIED FOR ISSUE

NAME: <u>B.C. PLANT</u> \_\_ \_ \_ \_ RPEQ: <u>8807</u> SIGNATURE: ON ORIGINAL \_\_ DATE:28/6/12

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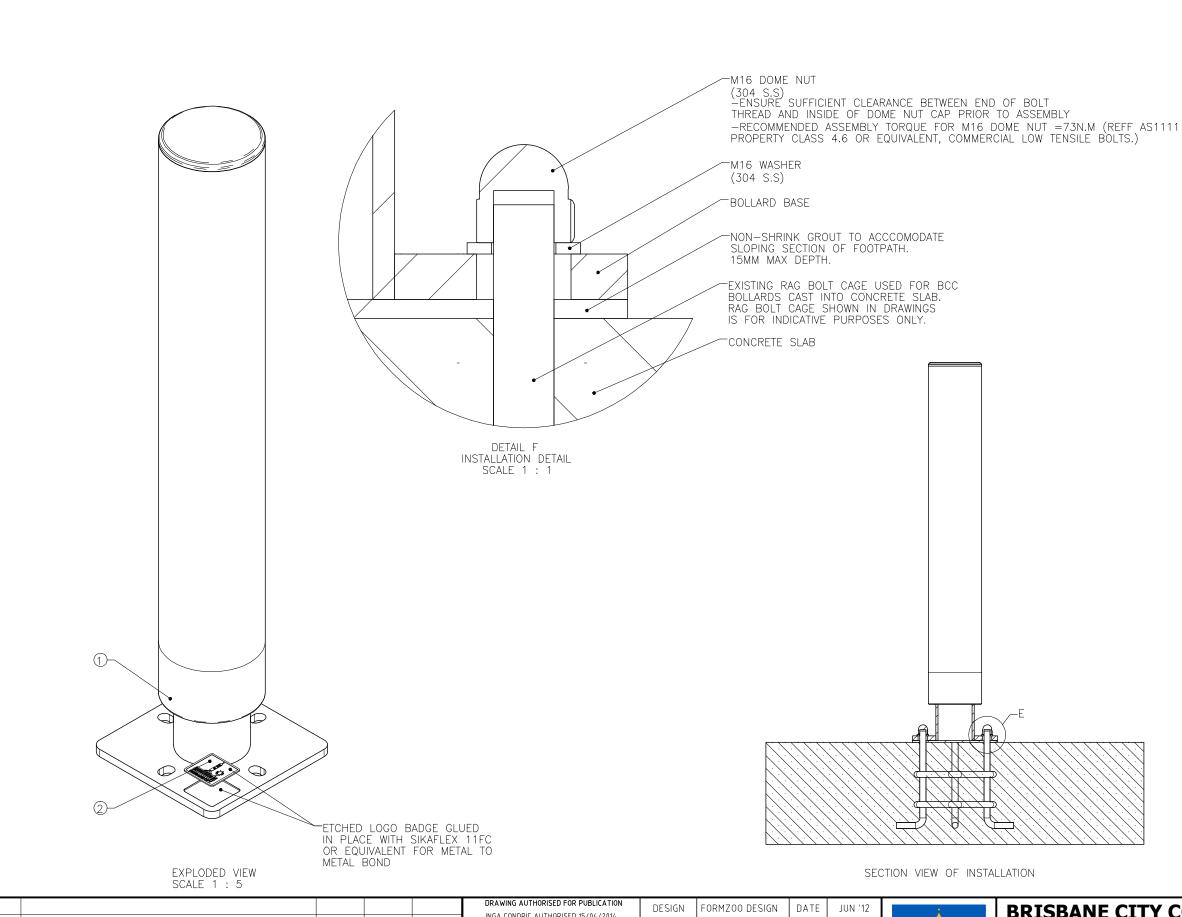
	BOLLOW VIEW									
					DRAWING AUTHORISED FOR PUBLICATION INGA CONDRIC AUTHORISED 15/04/2014	DESIGN	FORMZOO DESIGN	DATE	JUN '12	Γ
					— — ASSET ENGINEERING MANAGER	DRAWN	АВ	DATE	JUN '12	
В	Drawing Title Amended	FFB '16	JUI '16	JUL '16	STRATEGIC ASSET MANAGEMENT  DESIGN APPROVED	CHECKED	VM	DATE	APR '13	
A	Drawing Converted from UMS Series April 2014	APR '14	APR '14	APR '14	VICKI MARTIN SIGNATURE ON ORIGINAL	DRAWING FILENAME	BSD-7095 (B) Streetscape fixed bollard - Sheet 1		Sheet 1 of 2.dwg	
ISSUE	AMENDMENT	DRAWN DATE	CHK'D DATE	APPR'D DATE	PRINCIPAL PLANNING OFFICER URBAN DESIGN	ASSOCIATED PLANS	SUPERSEDES UMS-567-9			



#### **BRISBANE CITY COUNCIL STANDARD DRAWING**

STREETSCAPE FIXED BOLLARD SHEET 1 OF 2

scale NOT TO	SCALE
DWG No.	
BSD-	7095
ORIGINAL SIZE	REVISION
А3	В



DESIGNED IN ACCORDANCE WITH, AND FABRICATION TO MEET THE FOLLOWING STANDARDS:

- . AS1428.4.1:2009, TACTILE GROUND SURFACE INDICATORS FOR THE ORIENTATION OF PEOPLE WITH VISION IMPAIRMENT.
- AS1627.4 METAL FINISHING —
  PREPARATION AND PRE—TREATMENT
  OF SURFACES ABRASIVE BLAST
  CLEANING OF STEEL.
- AS2312:2002/AMDT 1:2004, GUIDE TO PROTECTION OF IRON AND STEEL AGAINST EXTERIOR ATMOSPHERIC CORROSION, 1994.
- 4. GUIDE TO ENGINEERING PRACTICE, 'PEDESTRIANS', PART 13,
- 5. AUSTRALIAN ROAD RULES , 1999, WWW.NRTC.GOV.AU
- 6. AS4506 -2005, METAL FINISHING-THERMOSET POWDER COATINGS.
- 7. AS4680:2006, HOT DIP GALVANISING.
- 8. AS 1742.10 2009 MANUAL OF UNIFORM TRAFFIC CONTROL DEVICES: 'PEDESTRIAN CONTROL AND PROTECTION'

#### NOTES

- 1. WELDING TO BE ACCORDANCE TO AS1554.1 CAT GP WELDING, ALL SHARP EDGES & BURRS REMOVED.
- 2. PART SHOULD BE SUPPLIED
  CLEAN AND FREE FROM MARKS,
  BURRS, SCUFFS, DISTORTION AND
  WARPAGE.
- 3. ENSURE ANTI-SEIZE IS ON ALL NUTS AND BOLTS PRIOR TO ASSEMBLY.
- 4. DRAWING TO AS1100 DRAWING STANDARDS.
- 5. 316 S.S AND 316 S.S FASTENERS
  TO BE USED THROUGHOUT FOR
  COASTAL INSTALLATIONS OR ANY
  ENVIRONMENT WITH HIGH
  CORROSION.
- 6. ALL TOLERANCES ± 1.5mm UNLESS OTHERWISE SPECIFIED.

#### MATERIAL

- 1. MATERIAL: SEE COMPONENT
- DRAWING 2. COLOUR: SEE COMPONENT DRAWING
- 3. FINISH: SEE COMPONENT DRAWING

STRUCTURAL DESIGN REVIEWED AND CERTIFIED FOR ISSUE	
CERTIFIED FOR 1550E	
NAME: <u>B.C. PLANT</u> RPEQ: <u>8807</u>	
SIGNATURE: ON ORIGINAL DATE: 28 / 6 / 12	

ITEM NO.	DESCRIPTION	QTY.
1	Bollard	1
2	Bollard Logo Badge	1
3	M16 304 Stainless Steel Washer	4
4	M16 304 Stainless Steel Dome Nut	4


					DRAWING AUTHORISED FOR PUBLICATION INGA CONDRIC AUTHORISED 15/04/2014	DESIGN	FORMZOO DESIGN	DATE	JUN '12
					ASSET ENGINEERING MANAGER	DRAWN	АВ	DATE	JUN '12
					STRATEGIC ASSET MANAGEMENT	CHECKED	VM	DATE	APR '13
В	Drawing Title Amended	FEB '16	JUL '16	JUL '16	DESIGN APPROVED			DATE	711 11 13
A	Drawing Converted from UMS Series April 2014	APR '14	APR '14	APR '14	VICKI MARTIN SIGNATURE ON ORIGINAL DRAWING FILENAME BSD-7095 B) Street scape fixed bollard - Ass		ssembly and instal	lation - Sheet 2 of 2.dwg	
ISSUE	AMENDMENT	DRAWN DATE	CHK'D DATE	APPR'D DATE	PRINCIPAL PLANNING OFFICER URBAN DESIGN	ASSOCIATED PLANS	SUPERSEDES UMS-567-3		




### **BRISBANE CITY COUNCIL STANDARD DRAWING**

STREETSCAPE - FIXED BOLLARD ASSEMBLY AND INSTALLATION SHEET 2 OF 2

		WILLIA
SCALE	NOT TO	SCALE
BWG No.		
[ [	BSD-	-7095
ORIGINAL SIZE		REVISION
ļ	73	В

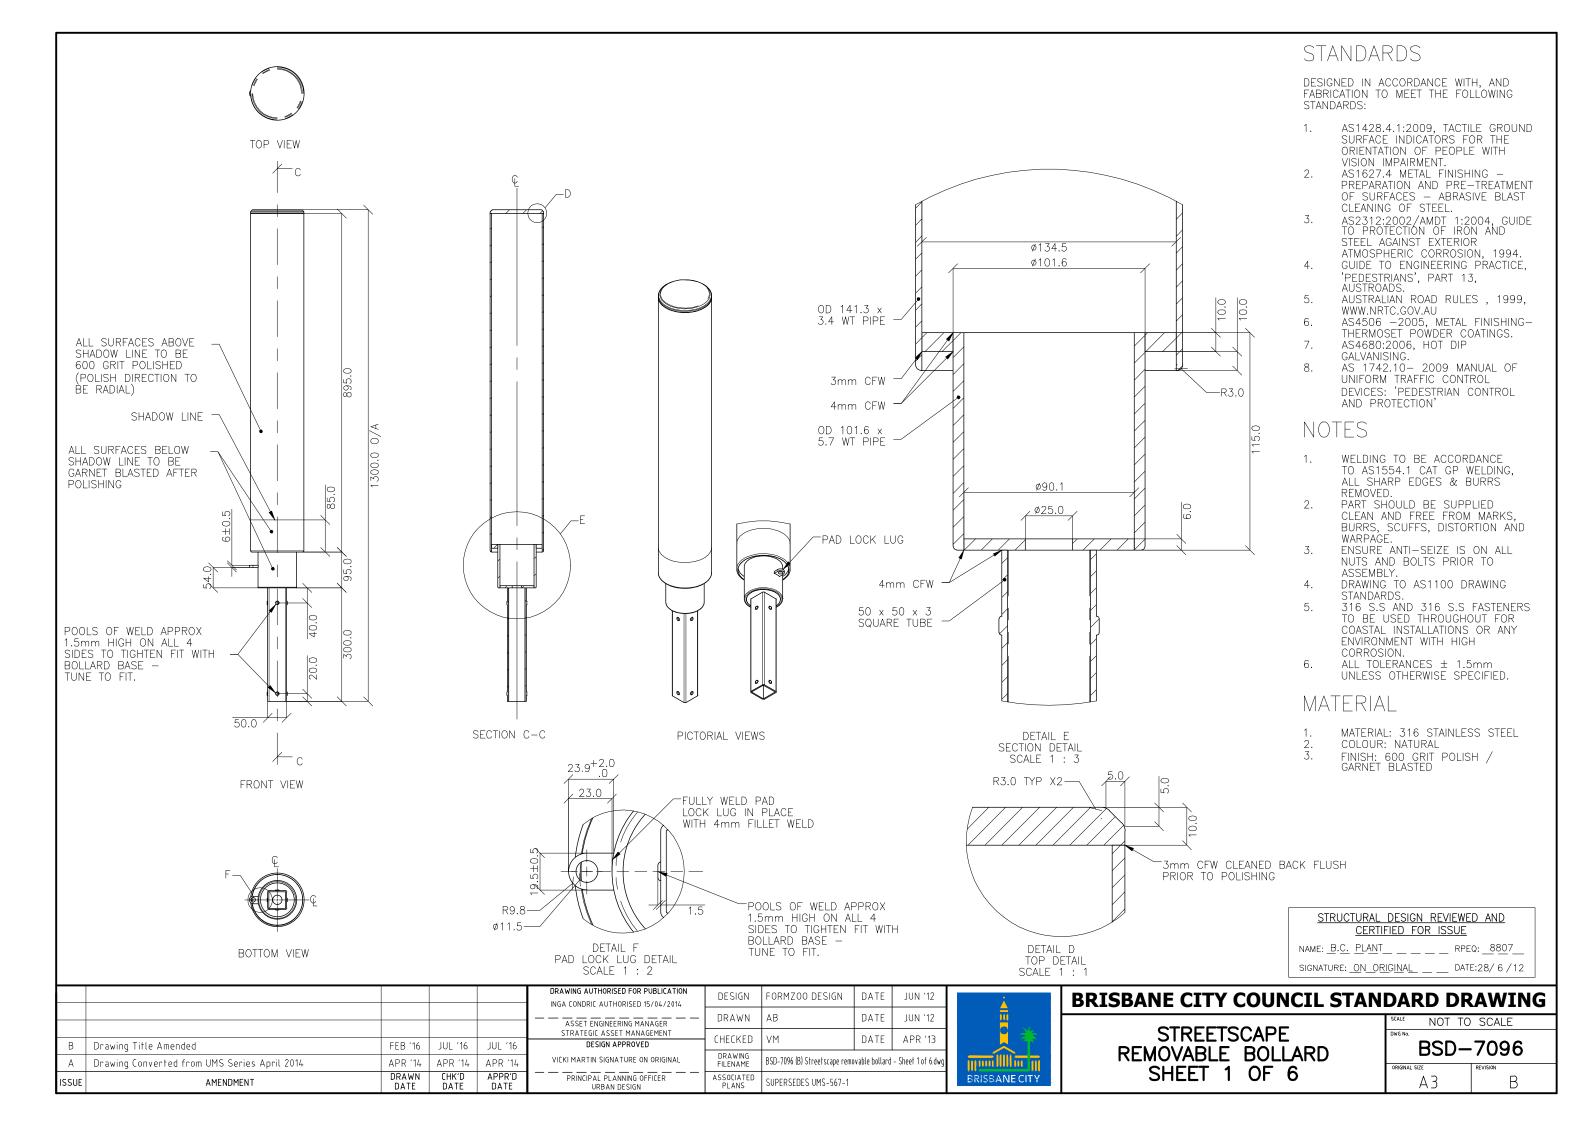

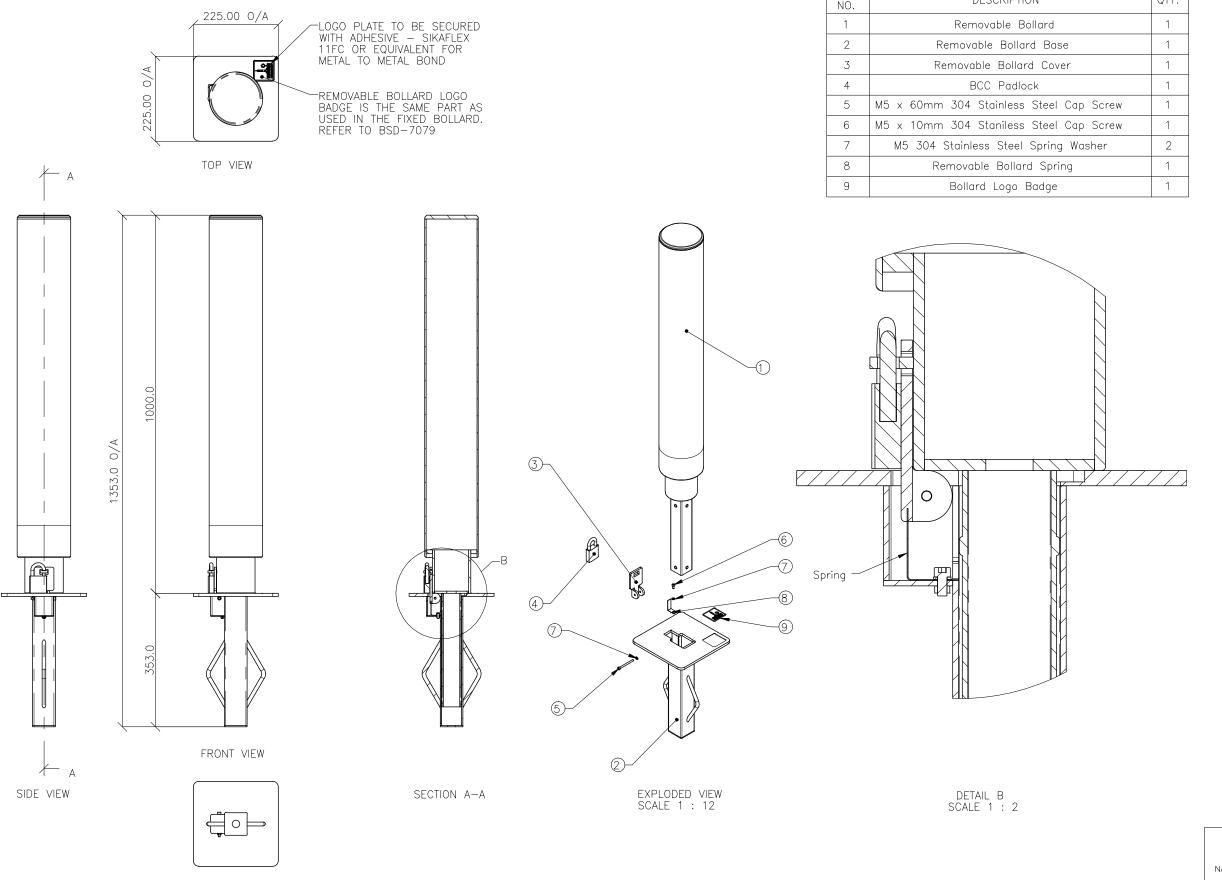

QTY.

DESIGNED IN ACCORDANCE WITH, AND FABRICATION TO MEET THE FOLLOWING STANDARDS:

- . AS1428.4.1:2009, TACTILE GROUND SURFACE INDICATORS FOR THE ORIENTATION OF PEOPLE WITH VISION IMPAIRMENT.
- AS1627.4 METAL FINISHING —
  PREPARATION AND PRE—TREATMENT
  OF SURFACES ABRASIVE BLAST
  CLEANING OF STEEL.
- AS2312:2002/AMDT 1:2004, GUIDE TO PROTECTION OF IRON AND STEEL AGAINST EXTERIOR ATMOSPHERIC CORROSION, 1994.
- . GUIDE TO ENGINEERING PRACTICE, 'PEDESTRIANS', PART 13, AUSTROADS.
- 5. AUSTRALIAN ROAD RULES , 1999, WWW.NRTC.GOV.AU
- 6. AS4506 -2005, METAL FINISHING-THERMOSET POWDER COATINGS.
- 7. AS4680:2006, HOT DIP GALVANISING.
- 8. AS 1742:10- 2009 MANUAL OF UNIFORM TRAFFIC CONTROL DEVICES: 'PEDESTRIAN CONTROL AND PROTECTION'

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- 4. DRAWING TO AS1100 DRAWING STANDARDS.
- 5. 316 S.S AND 316 S.S FASTENERS TO BE USED THROUGHOUT FOR COASTAL INSTALLATIONS OR ANY ENVIRONMENT WITH HIGH CORROSION.
- 6. ALL TOLERANCES ± 1.5mm UNLESS OTHERWISE SPECIFIED.

#### MATERIAL

- MATERIAL: SEE COMPONENT DRAWING
- . COLOUR: SEE COMPONENT
- DRAWING
- . FINISH: SEE COMPONENT DRAWING

STRUCTURAL DESIGN REVIEWED AND CERTIFIED FOR ISSUE

NAME: <u>B.C. PLANT</u> \_\_\_\_ RPEQ: <u>8807</u>

SIGNATURE: <u>ON\_ORIGINAL</u> \_\_\_ DATE:28/ 6 / 12

ISSUE	AMENDMENT	DRAWN DATE	CHK'D DATE	APPR'D DATE	PRINCIPAL PLANNING OFFICER URBAN DESIGN	ASSOCIATED PLANS	SUPERSEDES UMS-567-4		
А	Drawing Converted from UMS Series April 2014	APR '14	APR '14	APR '14	VICKI MARTIN SIGNATURE ON ORIGINAL	DRAWING FILENAME	BSD-7096 (B) Streetscape removable	bollard – Assem	bly - Sheet 2 of 6.dwg
В	Drawing Title Amended	FEB '16	JUL '16	JUL '16	DESIGN APPROVED	CHECKED	VM	DATE	APR '13
					STRATEGIC ASSET MANAGEMENT	CHECKED	1/14	DATE	V DD 143
					ASSET ENGINEERING MANAGER	DRAWN	AB	DATE	JUN '12
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					DRAWING AUTHORISED FOR PUBLICATION	DESIGN	FORMZOO DESIGN	DATE	JUN '12

BOTTOM VIEW




ITEM


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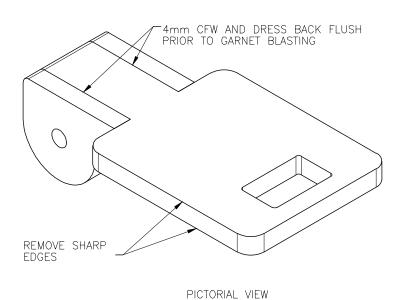
#### **BRISBANE CITY COUNCIL STANDARD DRAWING**


STREETSCAPE
REMOVABLE BOLLARD - ASSEMBLY
SHEET 2 OF 6


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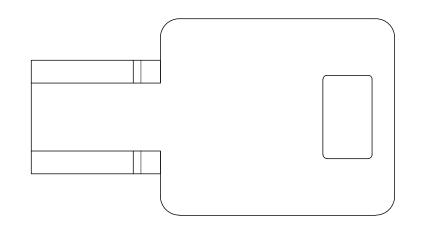




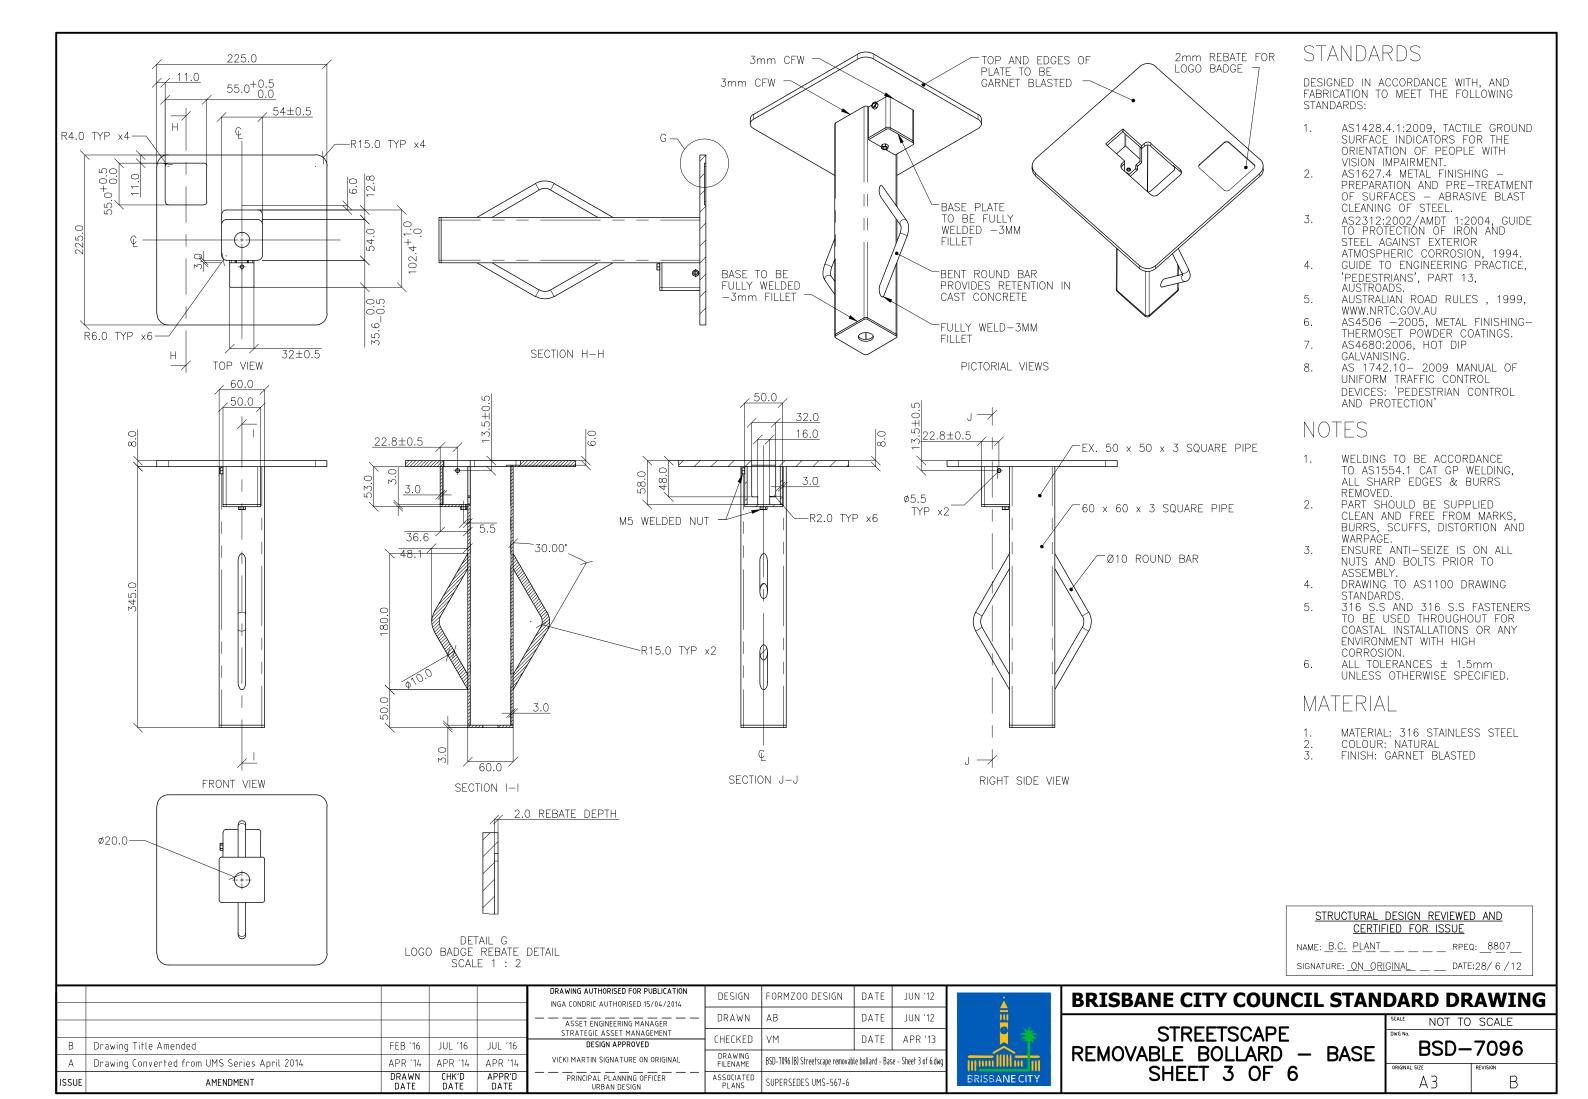


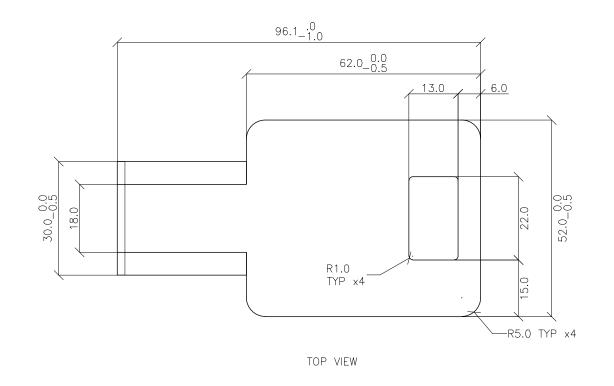

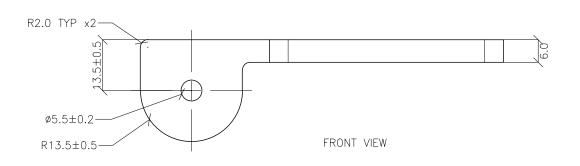

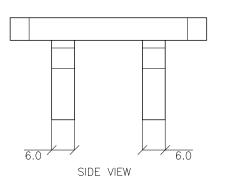

UNDERSIDE VIEW

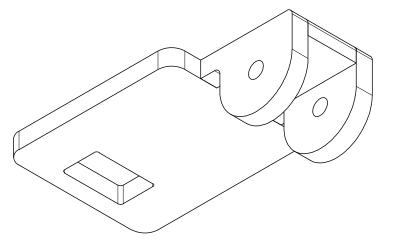

PICTORIAL VIEW

#### STANDARDS

DESIGNED IN ACCORDANCE WITH, AND FABRICATION TO MEET THE FOLLOWING STANDARDS:

- AS1428.4.1:2009, TACTILE GROUND SURFACE INDICATORS FOR THE ORIENTATION OF PEOPLE WITH VISION IMPAIRMENT.
- VISION IMPAIRMENT.
  AS1627.4 METAL FINISHING —
  PREPARATION AND PRE—TREATMENT
  OF SURFACES ABRASIVE BLAST
- OF SURFACES ABRASIVE BLAST CLEANING OF STEEL. AS2312:2002/AMDT 1:2004, GUIDE TO PROTECTION OF IRON AND STEEL AGAINST EXTERIOR ATMOSPHERIC CORROSION, 1994. GUIDE TO ENGINEERING PRACTICE,
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- AUSTRALIAN ROAD RULES , 1999, WWW.NRTC.GOV.AU
- AS4506 -2005, METAL FINISHING-THERMOSET POWDER COATINGS. 6.
- AS4680:2006, HOT DIP GALVANISING.
- AS 1742.10— 2009 MANUAL OF UNIFORM TRAFFIC CONTROL 8. DEVICES: 'PEDESTRIAN CONTROL AND PROTECTION'

#### NOTES

- WELDING TO BE ACCORDANCE TO AS1554.1 CAT GP WELDING, ALL SHARP EDGES & BURRS REMOVED.
- PART SHOULD BE SUPPLIED CLEAN AND FREE FROM MARKS, BURRS, SCUFFS, DISTORTION AND WARPAGE.
- ENSURE ANTI-SEIZE IS ON ALL NUTS AND BOLTS PRIOR TO ASSEMBLY.
- DRAWING TO AS1100 DRAWING STANDARDS.
- 316 S.S AND 316 S.S FASTENERS TO BE USED THROUGHOUT FOR COASTAL INSTALLATIONS OR ANY ENVIRONMENT WITH HIGH
- ALL TOLERANCES ± 1.5mm UNLESS OTHERWISE SPECIFIED.

#### MATERIAL

- MATERIAL: 316 STAINLESS STEEL
- COLOUR: NATURAL
- FINISH: GARNET BLASTED

STRUCTURAL	DESIGN	REVIEWED	AND
CERTI	FIED FC	R ISSUE	

NAME: B.C. PLANT \_\_\_ RPEQ: \_8807\_ SIGNATURE: ON ORIGINAL \_ \_ DATE:28/6/12

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В	Drawing Title Amended	FEB '16	JUL '16	JUL '16	Г
А	Drawing Converted from UMS Series April 2014	APR '14	APR '14	APR '14	l
ISSUE	AMENDMENT	DRAWN DATE	CHK'D DATE	APPR'D DATE	


DRAWING AUTHORISED FOR PUBLICATION INGA CONDRIC AUTHORISED 15/04/2014	DESIGN	FORMZOO DESIGN	DATE	JUN '12
ASSET ENGINEERING MANAGER	DRAWN	АВ	DATE	JUN '12
STRATEGIC ASSET MANAGEMENT  DESIGN APPROVED	CHECKED	VM	DATE	APR '13
VIČKI MARTIN SIGNATURE ON ORIGINAL	DRAWING FILENAME	BSD-7096-4.dwg		
PRINCIPAL PLANNING OFFICER URBAN DESIGN	ASSOCIATED PLANS	SUPERSEDES UMS-567-7		




#### **BRISBANE CITY COUNCIL STANDARD DRAWING**


STREETSCAPE REMOVABLE BOLLARD - COVER SHEET 4 OF 6


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PICTORIAL VIEW

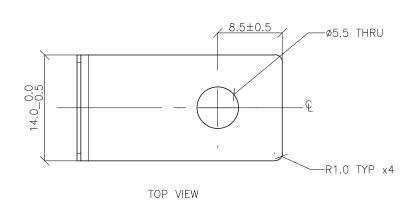

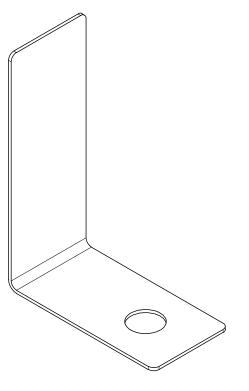

SIDE VIEW

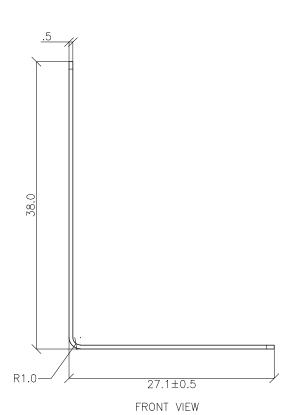DESIGNED IN ACCORDANCE WITH, AND FABRICATION TO MEET THE FOLLOWING STANDARDS:

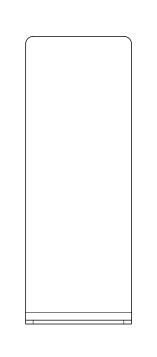- AS1428.4.1:2009, TACTILE GROUND SURFACE INDICATORS FOR THE ORIENTATION OF PEOPLE WITH VISION IMPAIRMENT.
  - AS1627.4 METAL FINISHING —
    PREPARATION AND PRE—TREATMENT
    OF SURFACES ABRASIVE BLAST
  - OF SURFACES ABRASIVE BLAST CLEANING OF STEEL. AS2312:2002/AMDT 1:2004, GUIDE TO PROTECTION OF IRON AND STEEL AGAINST EXTERIOR ATMOSPHERIC CORROSION, 1994. GUIDE TO ENGINEERING PRACTICE,
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- ALL TOLERANCES ± 1.5mm UNLESS OTHERWISE SPECIFIED.

#### MATERIAL

- MATERIAL: 316 STAINLESS SPRING STEEL
- COLOUR: NATURAL
- FINISH: NATURAL

#### STRUCTURAL DESIGN REVIEWED AND CERTIFIED FOR ISSUE

NAME: <u>B.C. PLANT</u> \_\_ \_ \_ RPEQ: <u>8807</u> SIGNATURE: ON ORIGINAL \_ DATE:28/6/12

					DRAWING AUTHORISED FOR PUBLICATION INGA CONDRIC AUTHORISED 15/04/2014	DESIGN	FORMZOO DESIGN	DATE	JUN '12
					ASSET ENGINEERING MANAGER	DRAWN	AB	DATE	JUN '12
В	Drawing Title Amended	FFB '16	JUI '16	JUL '16	STRATEGIC ASSET MANAGEMENT  DESIGN APPROVED	CHECKED	VM	DATE	APR '13
A	Drawing Converted from UMS Series April 2014	APR '14			VICKI MARTIN SIGNATURE ON ORIGINAL	DRAWING FILENAME	BSD-7096 (B) Streetscape removable	e bollard - Sprin	g - Sheet 5 of 6.dwg
ISSUE	AMENDMENT	DRAWN DATE	CHK'D DATE	APPR'D DATE	PRINCIPAL PLANNING OFFICER URBAN DESIGN	ASSOCIATED PLANS	SUPERSEDES UMS-567-8		



BRISBANE CITY COUNCIL STAN	DARD DRAWING
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STREETSCAPE	DWG No.

REMOVABLE BOLLARD - SPRING SHEET 5 OF 6

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# REMOVABLE BOLLARD REMOVABLE BOLLARD BASE SET IN CONCRETE SLAB AS PER BCC PROCEDURES CONCRETE SLAB 10

DETAIL K

INSTALLATION DETAIL

SCALE 1 : 3

#### STANDARDS

DESIGNED IN ACCORDANCE WITH, AND FABRICATION TO MEET THE FOLLOWING

- AS1428.4.1:2009, TACTILE GROUND SURFACE INDICATORS FOR THE ORIENTATION OF PEOPLE WITH VISION IMPAIRMENT.
- AS1627.4 METAL FINISHING -PREPARATION AND PRE—TREATMENT OF SURFACES — ABRASIVE BLAST CLEANING OF STEEL.
- AS2312:2002/AMDT 1:2004, GUIDE TO PROTECTION OF IRON AND STEEL AGAINST EXTERIOR ATMOSPHERIC CORROSION, 1994.
- GUIDE TO ENGINEERING PRACTICE, 'PEDESTRIANS', PART 13,
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#### MATERIAL

- MATERIAL: SEE COMPONENT DRAWING
- COLOUR: SEE COMPONENT DRAWING
- FINISH: SEE COMPONENT DRAWING

#### STRUCTURAL DESIGN REVIEWED AND CERTIFIED FOR ISSUE

NAME: B.C. PLANT RPEQ: 8807 SIGNATURE: ON ORIGINAL DATE: 28/6/12

					DRAWING AUTHORISED FOR PUBLICATION	DESIGN	FORMZOO DESIGN	DATE	JUN '12	Γ
					ASSET ENGINEERING MANAGER	DRAWN	АВ	DATE	JUN '12	l
					STRATEGIC ASSET MANAGEMENT	CHECKED	VM	DATE	APR '13	1
В	Drawing Title Amended	FEB '16	JUL '16	JUL '16	DESIGN APPROVED		VIII	DAIL		l
А	ORIGINAL ISSUE	OCT '13	OCT '13	OCT '13	VIČKI MARTIN SIGNATURE ON ORIGINAL	DRAWING FILENAME	BSD-7096 (B) Streetscape removable I	bollard - Installa	ution – Sheet 6 of 6.dw	ļ
ISSUE	AMENDMENT	DRAWN DATE	CHK'D DATE	APPR'D DATE	PRINCIPAL PLANNING OFFICER URBAN DESIGN	ASSOCIATED PLANS	SUPERSEDES UMS-567-9			


SECTION VIEW OF INSTALLATION



#### **BRISBANE CITY COUNCIL STANDARD DRAWING**

STREETSCAPE | REMOVEABLE BOLLARD - INSTALLATION SHEET 6 OF 6

SCALE NOT TO	) SCALE
BWG No.	
BSD-	-7096
ORIGINAL SIZE	REVISION
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DESIGNED IN ACCORDANCE WITH, AND FABRICATION TO MEET THE FOLLOWING STANDARDS:

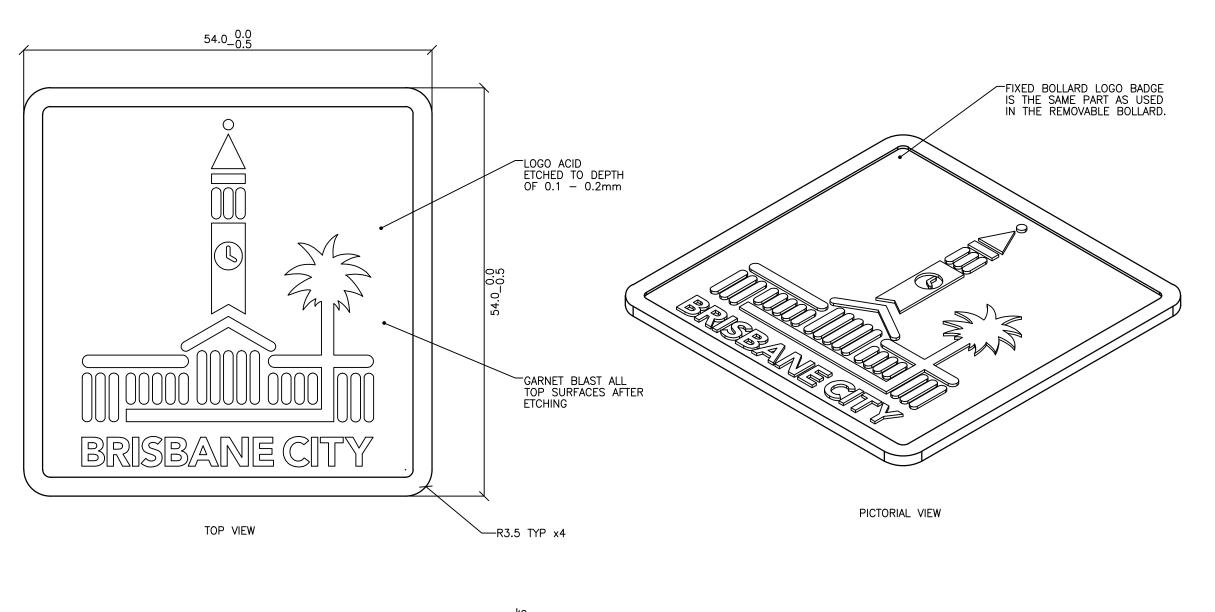- AS1428.4.1:2009, TACTILE GROUND SURFACE INDICATORS FOR THE ORIENTATION OF PEOPLE WITH VISION IMPAIRMENT.
- VISION IMPAIRMENT.
  AS1627.4 METAL FINISHING —
  PREPARATION AND PRE—TREATMENT
  OF SURFACES ABRASIVE BLAST
  CLEANING OF STEEL.
  AS2312:2002/AMDT 1:2004, GUIDE
  TO PROTECTION OF IRON AND
  STEEL AGAINST EXTERIOR
  ATMOSPHERIC CORPOSION 1994
- ATMOSPHERIC CORROSION, 1994. GUIDE TO ENGINEERING PRACTICE, 'PEDESTRIANS', PART 13, AUSTROADS.
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- DRAWING TO AS1100 DRAWING STANDARDS.
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- ALL TOLERANCES ± 1.5mm UNLESS OTHERWISE SPECIFIED.

#### **MATERIAL**

- MATERIAL: 316 STAINLESS STEEL COLOUR: NATURAL FINISH: GARNET BLASTED

STRUCTURAL	DESIGN	REVIEWED	AND
CERTI	FIED FO	r issue	

NAME: B.C. PLANT RPEQ: 8807

DATE:28/6/12 SIGNATURE: <u>ON ORIGINA</u>L\_

ISSUE	AMENDMENT	DRAWN DATE	CHK'D DATE	APPR'D DATE	PRINCIPAL PLANNING OFFICER Urban Design	ASSOCIATED PLANS	SUPERSEDES UMS-567-2		
Α	Drawing Converted from UMS Series April 2014	APR '14	APR '14	APR '14	VICKI MARTIN SIGNATURE ON ORIGINAL	DRAWING FILENAME	BSD-7097 (B) Streetscape - fixed and re	emovable bollard -	bollard logo badge.dwg
В	Drawing Title Amended	FEB '16	JUL '16	JUL '16	DESIGN APPROVED	CHECKED	VM	DATE	APR '13
C	Logo Acid Etch Depth Amended	MAY '17	MAY '17	MAY '17	ASSET ENGINEERING MANAGER STRATEGIC ASSET MANAGEMENT		· · -		
						DRAWN	AB	DATE	JUN '12
					DRAWING AUTHORISED FOR PUBLICATION INGA CONDRIC AUTHORISED 15/04/2014	DESIGN	FORMZOO DESIGN	DATE	JUN '12


FRONT VIEW



#### **BRISBANE CITY COUNCIL STANDARD DRAWING**

**STREETSCAPE** FIXED AND REMOVABLE BOLLARD **BOLLARD LOGO BADGE** 


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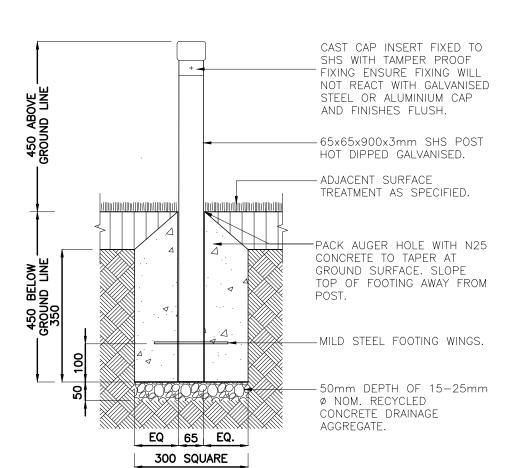
REFER TO BSD-7092 FOR ASSOCIATED SPECIFICATION NOTES.

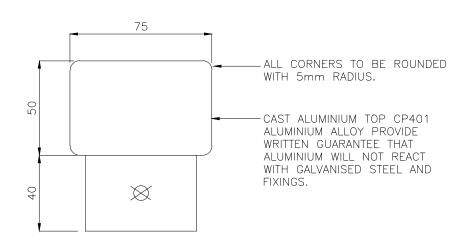


### BOUNDARY MARKER — CAST CAP DETAIL — ELEVATION VIEW SCALE: 1:2



# BOUNDARY MARKER — FOOTING — PLAN VIEW SCALE: 1:10

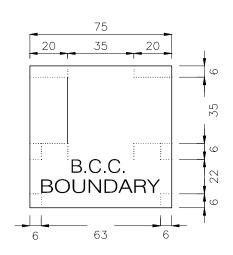

# B.C.C NATURAL AREA BOUNDARY MARKER — CAST CAP DETAIL — PLAN SCALE: 1:2

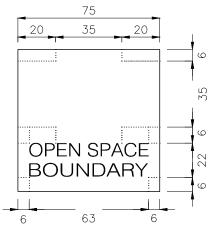

BOUNDARY MARKER — SECTION SCALE: 1:10

OPEN SPACE NATURAL AREA BOUNDARY MARKER —

CAST CAP DETAIL — PLAN

SCALE: 1:2


ISSUE	AMENDMENT	DRAWN DATE	CHK'D DATE	APPR'D DATE	PRICIPAL PROGRAM OFFICER PARKS	ASSOCIATED PLANS	SUPERSEDES UMS-723			
А	Drawing Converted From UMS Series April 2014	APR '14	APR '14	APR '14	LAUREN TEMPLEMAN SIGNATURE ON ORIGINAL DATED 31/08/04	DRAWING FILENAME	BSD-7099 (A) Parks and natura	al areas - Bou	ndary marker.dwg	
					R.P.E.Q: 2546 DESIGN APPROVED	CHECKED	UMD - E&P & IMB	DATE	OCT '13	
					03/09/04 MANAGER INFRASTRUCTURE MANAGEMENT	DRAWN	CPO - P&D	DATE	OCT '13	
					DRAWING AUTHORISED FOR PUBLICATION PAUL COTTON SIGNATURE ON ORIGINAL DATED	DESIGN	Std Dwgs WG	DATE	OCT '13	




### **BRISBANE CITY COUNCIL STANDARD DRAWING**

PARKS AND NATURAL AREAS BOUNDARY MARKER

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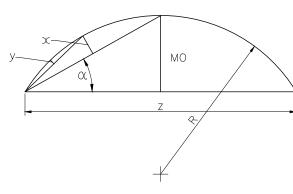

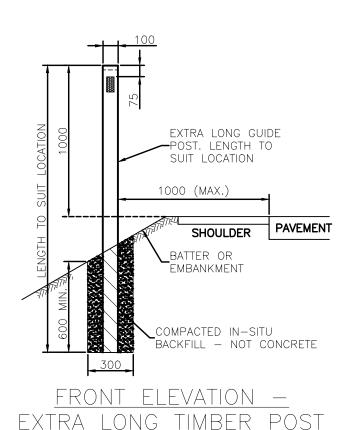
#### FRONT ELEVATION — STANDARD TIMBER POST
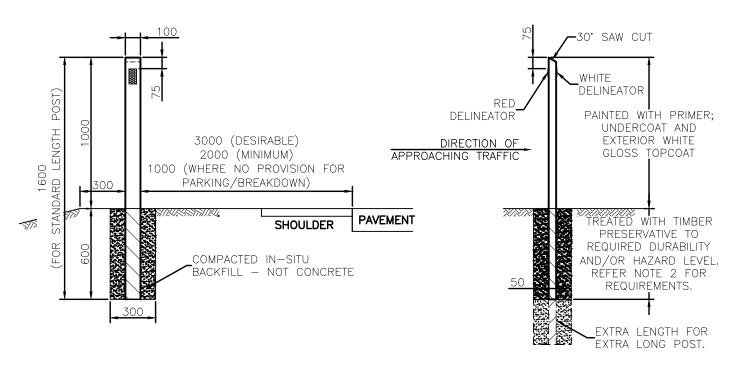
#### <u>SIDE ELEVATION —</u> TIMBER POST

#### NOTES:

- ALTERNATIVE PRODUCTS WILL BE CONSIDERED FOR APPROVAL BY MANAGER CITY ASSETS UPON RECEIPT OF FORMAL APPLICATION.
- 2. ALL POST MATERIALS, INCLUDING TIMBER PRESERVATION, ARE TO COMPLY WITH QUEENSLAND DEPARTMENT OF TRANSPORT AND MAIN ROADS (QDTMR) SPECIFICATION MRTS 11.14.
- 3. WHERE GUIDE POSTS ARE INSTALLED ON FLOODWAYS, POST SHALL BE TUBULAR STEEL AT MAXIMUM 25m SPACING IN PAIRS.
- 4. POSTS TO BE ERECTED IN PAIRS, ONE EACH SIDE OF THE ROAD FORMATION WHERE KERB AND CHANNEL DO NOT EXIST.
- 5. DELINEATORS ARE TO COMPLY WITH QDTMR SPECIFICATION MRTS 11.14 AND ARE TO BE LOCATED WITH RED FACING TRAFFIC ON THE LEFT SIDE AND WHITE FACING TRAFFIC ON RIGHT SIDE.
- 6. GUIDE POST SHALL BE POSITIONED:
  - ON STRAIGHTS OR CURVES AS PER TABLE PROVIDED;
  - SO THAT ONE PAIR IS ALWAYS VISIBLE ON EACH SIDE OF THE TOP OF THE CREST ON EACH SIDE OF THE ROAD;
- ADJACENT TO ANY CHANGE OF ROAD ALIGNMENT OR HAZARD (eg. TAPERS, BRIDGES, CULVERTS).
- 7. WHERE POSTS ARE PLACED OVER CRESTS, THE SPACING SHALL BE ARRANGED SUCH THAT A MINIMUM OF 2 PAIRS ARE VISIBLE AT ALL TIMES FROM FROM A DRIVER'S EYE HEIGHT OF 1.15m.
- 8. DELINEATORS TO BE FIXED TO GUARDRAIL AT EACH END POST AND AT A MAXIMUM SPACING OF 16m. CLOSER SPACING AS PER TABLE ABOVE MAY BE REQUIRED IN WHICH CASE DELINEATORS ARE TO BE PLACED ON THE NEAREST POST.
- 9. SPACING AND INSTALLATION TO CONFORM TO REQUIREMENTS, OF THE QUEENSLAND MANUAL OF UNIFORM TRAFFIC CONTROL DEVICES (MUTCD).
- 10. DIMENSIONS IN MILLIMETRES (UNO).



- 1.  $R = \frac{Z}{2} / \sin 2\alpha$  ;  $\alpha = \tan^{-1} 2(\frac{MO}{Z})$
- 2.  $x = \frac{MO}{4}$  ;  $y = \frac{MO}{16}$

#### MID ORDINATE DIAGRAM

- 1. USED FOR OBTAINING THE RADIUS OF A CURVE AFTER MEASURING MO & Z.
- 2. USED FOR SETTING OUT THE CURVE AFTER OBTAINING THE RADIUS

RADIUS (m)	SPACIN	G (m)
	OUTSIDE OF CURVE	INSIDE OF CURVE
<100	6	12
100-199	10	20
200-299	15	30
300-399	20	40
400-599	30	60
600-799	40	60
800-1199	60	60
1200-2000	90	90
>2000 (incl. straights)	150	150

#### <u>SPACING</u>

#### SPACING FOR SPECIAL CASES

FLOOD WAYS:— 25m FOR FLOOD WAYS < 120m LONG. 50m FOR FLOOD WAYS > 120m LONG.

NARROW FORMATIONS:- 20m FOR SHORT HIGH FILLS OR DEEP DRAINAGE DITCHES.

#### STANDARD TIMBER POSTS

 1600 MIN.x100x50 HARDWOOD WITH 6 ARRIS AROUND EXPOSED PERIMETER OF POST. EXTRA LENGTH AS REQUIRED TO SUIT LOCATION.


ISSUE	AMENDMENT	DRAWN DATE	CHK'D DATE	APPR'D DATE	PRINCIPAL ASSET OFFICER ROADS & DRAINAGE	ASSOCIATED PLANS	SUPERSEDES UMS-131		
А	Drawing Converted from UMS Series April 2014	APR '14	APR '14	APR '14	B. HANSEN SIGNATURE ON ORIGINAL DATED 27/06/01	DRAWING FILENAME	BSD-7121 (A) Road edge ç	juide posts.o	dwg
					STRATEGIC ASSET MANAGEMENT  DESIGN APPROVED	CHECKED	M. STEER	DATE	MAY '01
					ASSET ENGINEERING MANAGER	DRAWN	CITY DESIGN	DATE	APRIL '01
					DRAWING AUTHORISED FOR PUBLICATION  B. BALL SIGNATURE ON ORIGINAL  DATED 29/06/01 R.P.E.Q.: 3852	DESIGN	Std Dwgs Group	DATE	APRIL '01



#### **BRISBANE CITY COUNCIL STANDARD DRAWING**

ROAD EDGE GUIDE POSTS

_		\ <u>D</u> D	'   \	A1111	_
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	BWG No.				
		BSD	)—	7121	
	ORIGINAL S	IZE		REVISION	
		Α3		А	

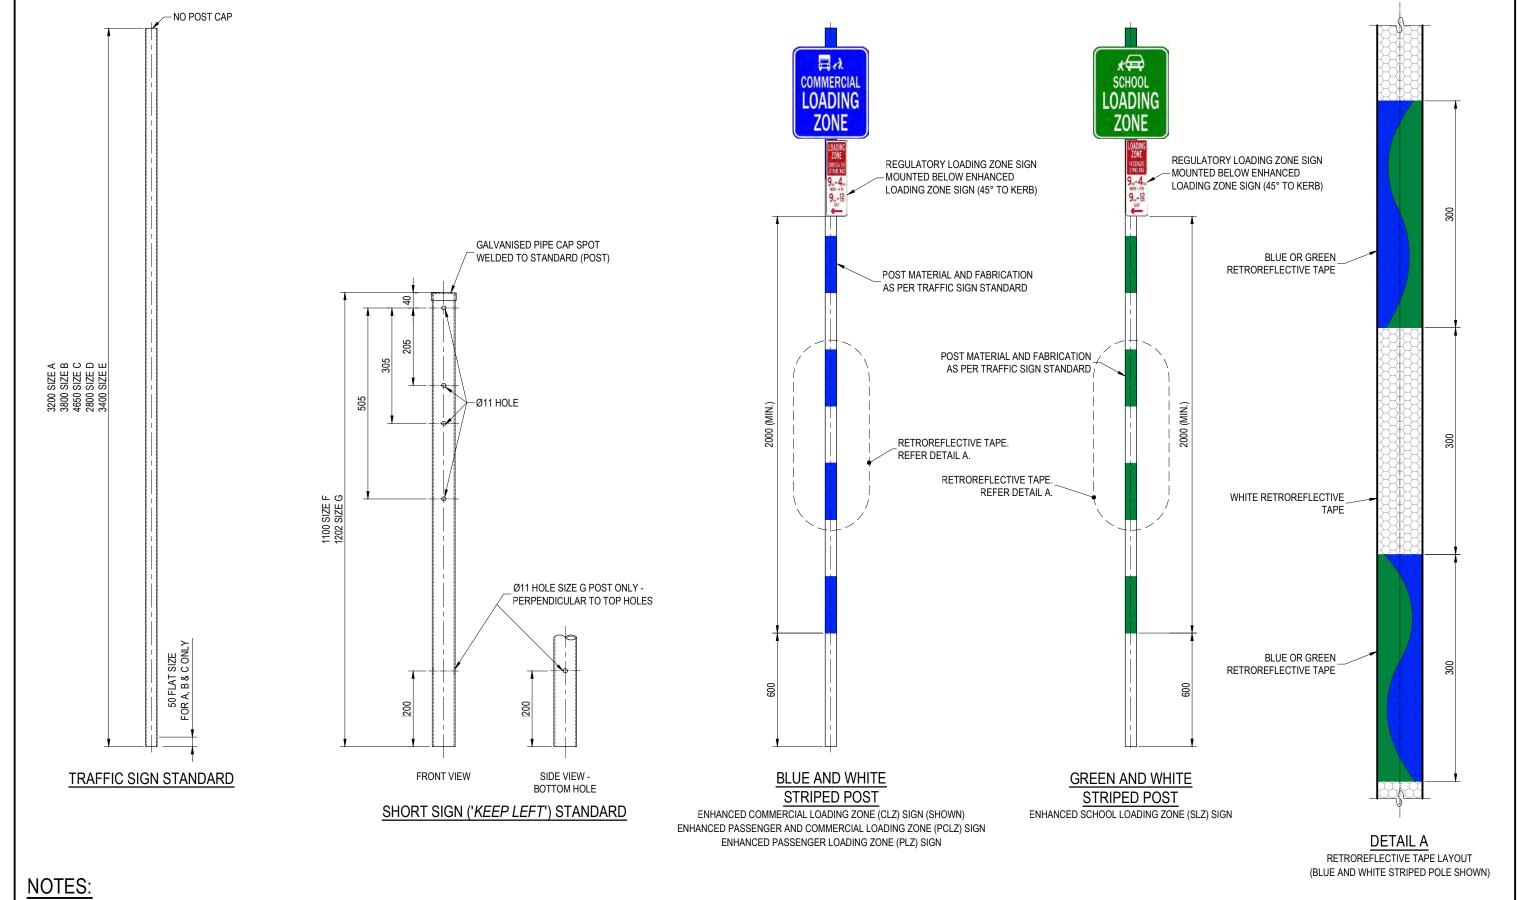

- TRAFFIC SIGN STANDARD TO BE MANUFACTURED AS PER REFERENCE SPECIFICATION S154 TRAFFIC SIGNS AND ROADSIDE FURNITURE.
- 2. SHORT SIGN ('KEEP LEFT') STANDARD:
  - NEW STOCK: MANUFACTURED AS PER REFERENCE SPECIFICATION S154 TRAFFIC SIGNS AND ROADSIDE FURNITURE: OR
  - RECYCLED/RECOVERED STOCK: CUT TO LENGTH RECYCLED (DAMAGED) TRAFFIC SIGN STANDARD AS PER NOTE 1.
- 3. STRIPED STANDARD (POLE) DIMENSIONS, MATERIALS AND FABRICATION AS PER PER TRAFFIC SIGN STANDARD.
- FOR STRIPED STANDARDS, USE ALTERNATE BANDS OF 300mm WIDE GREEN OR BLUE AND WHITE CLASS 1A RETROREFLECTIVE TAPE TO AS/NZS1906 FOR ALL STRIPES.
- 5. ALL DIMENSIONS IN MILLIMETRES (U.N.O.).

THE PURPOSE OF THIS STANDARD DRAWING IS TO PROVIDE TYPICAL DETAILS THAT SUPPORT THE DESIRED OUTCOMES OF THE BRISBANE CITY PLAN 2014 AND ASSOCIATED PLANNING SCHEME POLICIES. THE FITNESS FOR PURPOSE OF THIS STANDARD DRAWING FOR A SPECIFIC PROJECT SHOULD BE ASSESSED AND ACCEPTED BY AN APPROPRIATELY QUALIFIED DESIGNER AND/OR REGISTERED PROFESSIONAL ENGINEER OF QUEENSLAND (RPEQ).



#### BRISBANE CITY COUNCIL STANDARD DRAWING

TRAFFIC SIGN STANDARDS (POSTS) PUBLISH DATE

JUN 2023

SCALE

NOT TO SCALE


DRAWING NUMBER

BSD-7122

ORIGINAL SIZE

A3

E

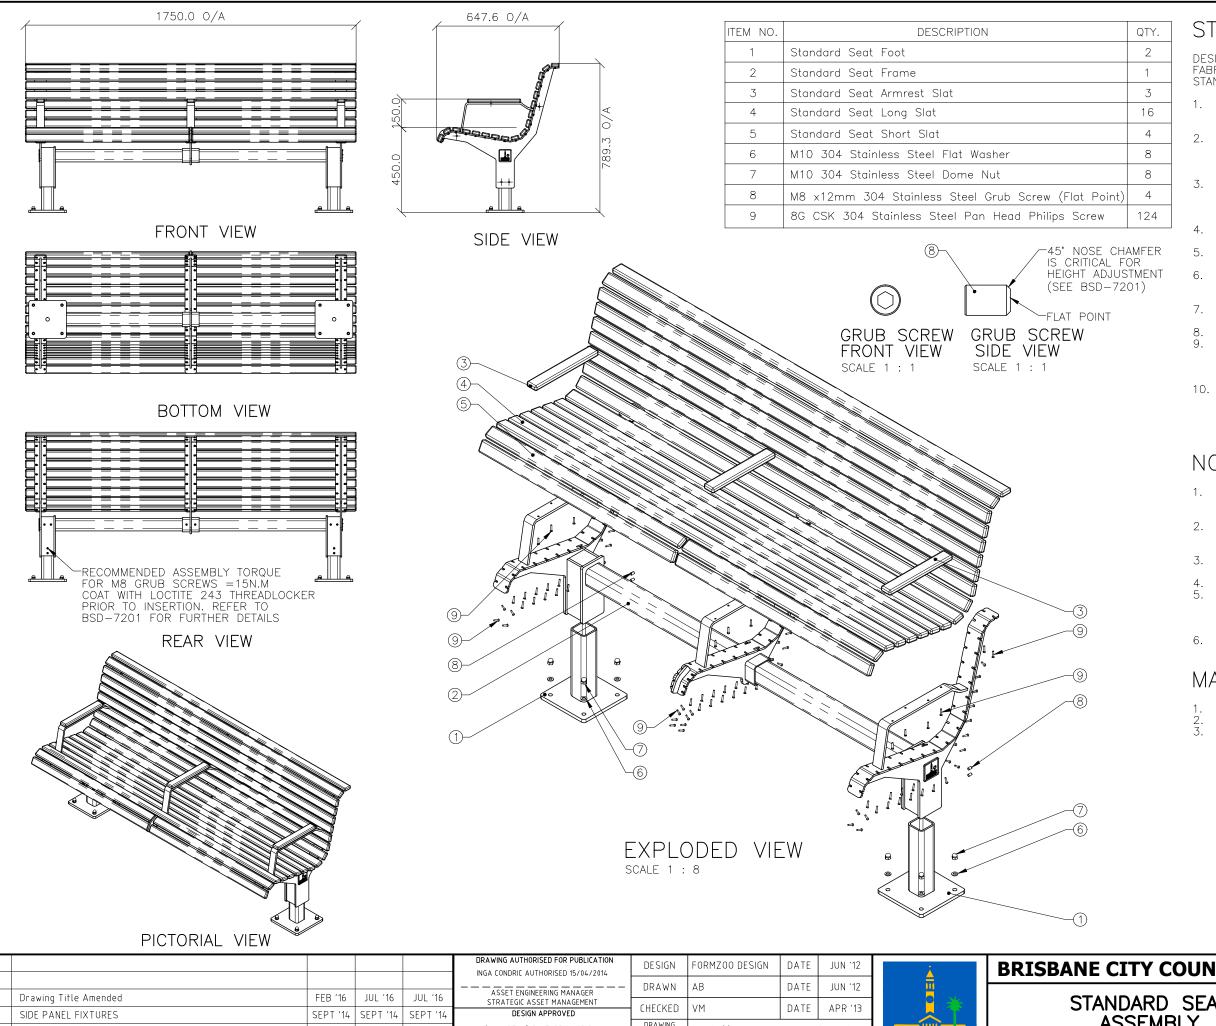

DESIGNED IN ACCORDANCE WITH, AND FABRICATION TO MEET THE FOLLOWING STANDARDS:

- PARTIALLY COMPLIANT WITH AS1428.2:1992, CLAUSE 27.2 SEATING IN PEDESTRIAN AREAS.
- AS1627.4 METAL FINISHING PREPARATION AND PRE-TREATMENT OF SURFACES - ABRASIVE BLAST CLEANING OF STEEL
- AS2312:2002/AMDT 1:2004, GUIDE TO PROTECTION OF IRON AND STEEL AGAINST EXTERIOR ATMOSPHERIC CORROSION,
- GUIDE TO ENGINEERING PRACTICE,
- 'PEDESTRIANS', PART 13, AUSTROADS. AS2796.3:1999, TIMBER FOR FURNITURE
- COMPONENTS.
  AS1604.1-2005, SPECIFICATION FOR PRESERVATIVE TREATMENT, SAWN AND ROUND TIMBER.
- AS4506 -2005, METAL FINISHING-THERMOSET POWDER COATINGS. AS4680:2006, HOT DIP GALVANISING.
- POWDERCOATING TO BE IN ACCORDANCE TO AS4506-2005 EXTERNAL EXPOSURE STANDARD WITH PRE-TREATMENT SAND
- BLAST, ZINC PHOSPHATE, ETC. WOOD TREATMENT IN ACCORDANCE WITH AS1604.1 HAZARD CLASSIFICATION H3 (EXTERIOR ABOVE GROUND) AND AS2796.3 (TIMBER FOR FURNITURE COMPONENTS.)

#### NOTES

- WELDING TO BE ACCORDANCE TO AS1554.1 CAT GP WELDING, ALL SHARP EDGES & BURRS REMOVED.
  - PART SHOULD BE SUPPLIED CLEAN AND FREE FROM MARKS, BURRS, SCUFFS, DISTORTION AND WARPAGE.
- ENSURE ANTI—SEIZE IS ON ALL NUTS AND BOLTS PRIOR TO ASSEMBLY.
- DRAWING TO AS1100 DRAWING STANDARDS 316 S.S AND 316 S.S FASTENERS TO BE USED THROUGHOUT FOR COASTAL INSTALLATIONS OR ANY ENVIRONMENT WITH HIGH CORROSION.
- ALL TOLERANCES ± 1.5mm UNLESS OTHERWISE SPECIFIED.

#### MATERIAL

- MATERIAL: SEE COMPONENT DRAWING COLOUR: SEE COMPONENT DRAWING
- FINISH: SEE COMPONENT DRAWING

#### STRUCTURAL DESIGN REVIEWED AND CERTIFIED FOR ISSUE

NAME: <u>B.C. PLANT</u> \_ \_ \_ RPEQ: <u>8807</u> SIGNATURE: <u>ON ORIGINAL</u> \_\_ DATE: 28/6/12


					DRAWING AUTHORISED FOR PUBLICATION INGA CONDRIC AUTHORISED 15/04/2014	DESIGN	FORMZOO DESIGN	DATE	JUN '12
					ASSET ENGINEERING MANAGER	DRAWN	АВ	DATE	JUN '12
C	Drawing Title Amended	FEB '16	JUL '16	JUL '16	STRATEGIC ASSET MANAGEMENT	CHECKED		D. T.	100 (10
В	SIDE PANEL FIXTURES	SEPT '14	SEPT '14	SEPT '14	DESIGN APPROVED	CHECKED	VM	DATE	APR '13
А	Drawing Converted from UMS Series April 2014	APR '14	APR '14	APR '14	VICKI MARTIN SIGNATURE ON ORIGINAL	DRAWING FILENAME	BSD-7201 (B) Standard seat -	Assembly -	Sheet 1 of 10.dwg
ISSUE	AMENDMENT	DRAWN DATE	CHK'D DATE	APPR'D DATE	PRINCIPAL PLANNING OFFICER URBAN DESIGN	ASSOCIATED PLANS	SUPERSEDES UMS-563-1		



#### **BRISBANE CITY COUNCIL STANDARD DRAWING**

STANDARD SEAT **ASSEMBLY** SHEET 1 OF 10

'		<u> </u>		ATT 2110
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		BSD	)—	7201
	ORIGINAL S	IZE		REVISION
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DESIGNED IN ACCORDANCE WITH, AND FABRICATION TO MEET THE FOLLOWING

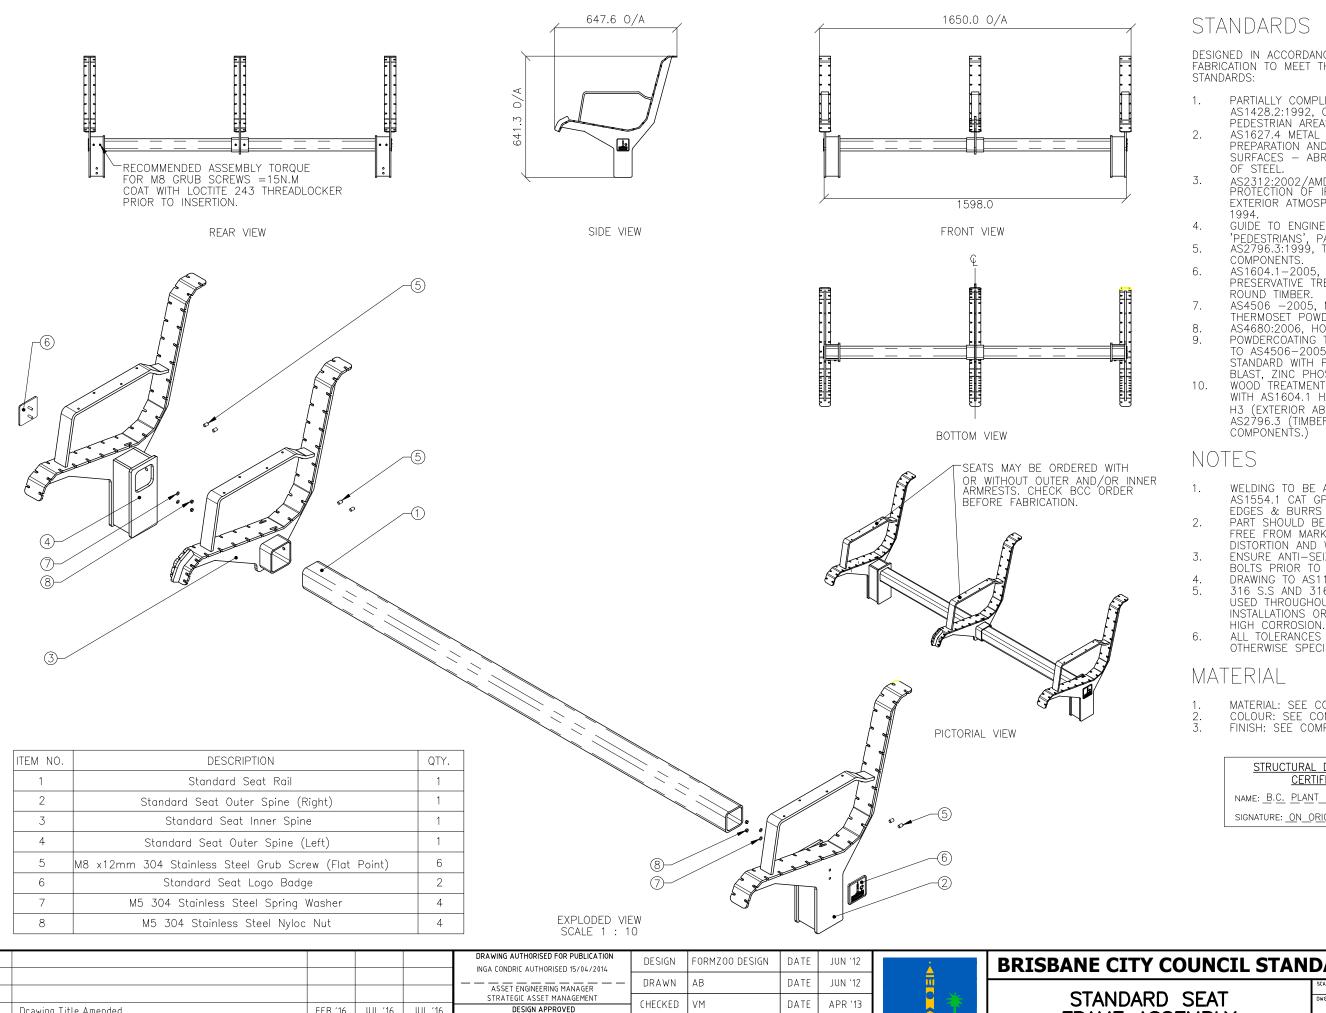- PARTIALLY COMPLIANT WITH AS1428.2:1992, CLAUSE 27.2 SEATING IN PEDESTRIAN AREAS.
  - AS1627.4 METAL FINISHING PREPARATION AND PRE—TREATMENT OF SURFACES — ABRASIVE BLAST CLEANING OF STEEL
- AS2312:2002/AMDT 1:2004, GUIDE TO PROTECTION OF IRON AND STEEL AGAINST EXTERIOR ATMOSPHERIC CORROSION,
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  - AS1604.1-2005, SPECIFICATION FOR PRESERVATIVE TREATMENT, SAWN AND ROUND TIMBER.
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- POWDERCOATING TO BE IN ACCORDANCE TO AS4506-2005 EXTERNAL EXPOSURE STANDARD WITH PRE-TREATMENT SAND
- BLAST, ZINC PHOSPHATE, ETC.
  WOOD TREATMENT IN ACCORDANCE WITH AS1604.1 HAZARD CLASSIFICATION H3 (EXTERIOR ABOVE GROUND) AND AS2796.3 (TIMBER FOR FURNITURE COMPONENTS.)

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- PART SHOULD BE SUPPLIED CLEAN AND FREE FROM MARKS, BURRS, SCUFFS, DISTORTION AND WARPAGE
- ENSURE ANTI-SEIZE IS ON ALL NUTS AND BOLTS PRIOR TO ASSEMBLY.
- DRAWING TO AS1100 DRAWING STANDARDS. 316 S.S AND 316 S.S FASTENERS TO BE USED THROUGHOUT FOR COASTAL INSTALLATIONS OR ANY ENVIRONMENT WITH
- ALL TOLERANCES ± 1.5mm UNLESS OTHERWISE SPECIFIED.

- MATERIAL: SEE COMPONENT DRAWING COLOUR: SEE COMPONENT DRAWING
- FINISH: SEE COMPONENT DRAWING

STRUCTURAL DESIGN REVIEWED AND CERTIFIED FOR ISSUE
NAME: <u>B.C. PLANT</u> RPEQ: <u>880</u> 7
SIGNATURE: ON ORIGINAL DATE:28/6/12

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					ASSET ENGINEERING MANAGER	DRAWN	АВ	DATE	Ī
					STRATEGIC ASSET MANAGEMENT	CHECKED	VM	DATE	Ī
В	Drawing Title Amended	FEB '16	JUL '16	JUL '16	DESIGN APPROVED	CHECKED	A 1.1	DAIL	L
А	Drawing Converted from UMS Series April 2014	APR '14	APR '14	APR '14	VICKI MARTIN SIGNATURE ON ORIGINAL	DRAWING FILENAME	BSD-7201 (B) Standard seat - Fr	rame assembly	-
ISSUE	AMENDMENT	DRAWN DATE	CHK'D DATE	APPR'D DATE	PRINCIPAL PLANNING OFFICER URBAN DESIGN	ASSOCIATED PLANS	SUPERSEDES UMS-563-2		




- Sheet 2 of 10.dw

#### **BRISBANE CITY COUNCIL STANDARD DRAWING**

FRAME ASSEMBLY SHEET 2 OF 10

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BSD-	7201
ORIGINAL SIZE	REVISION
Α3	В

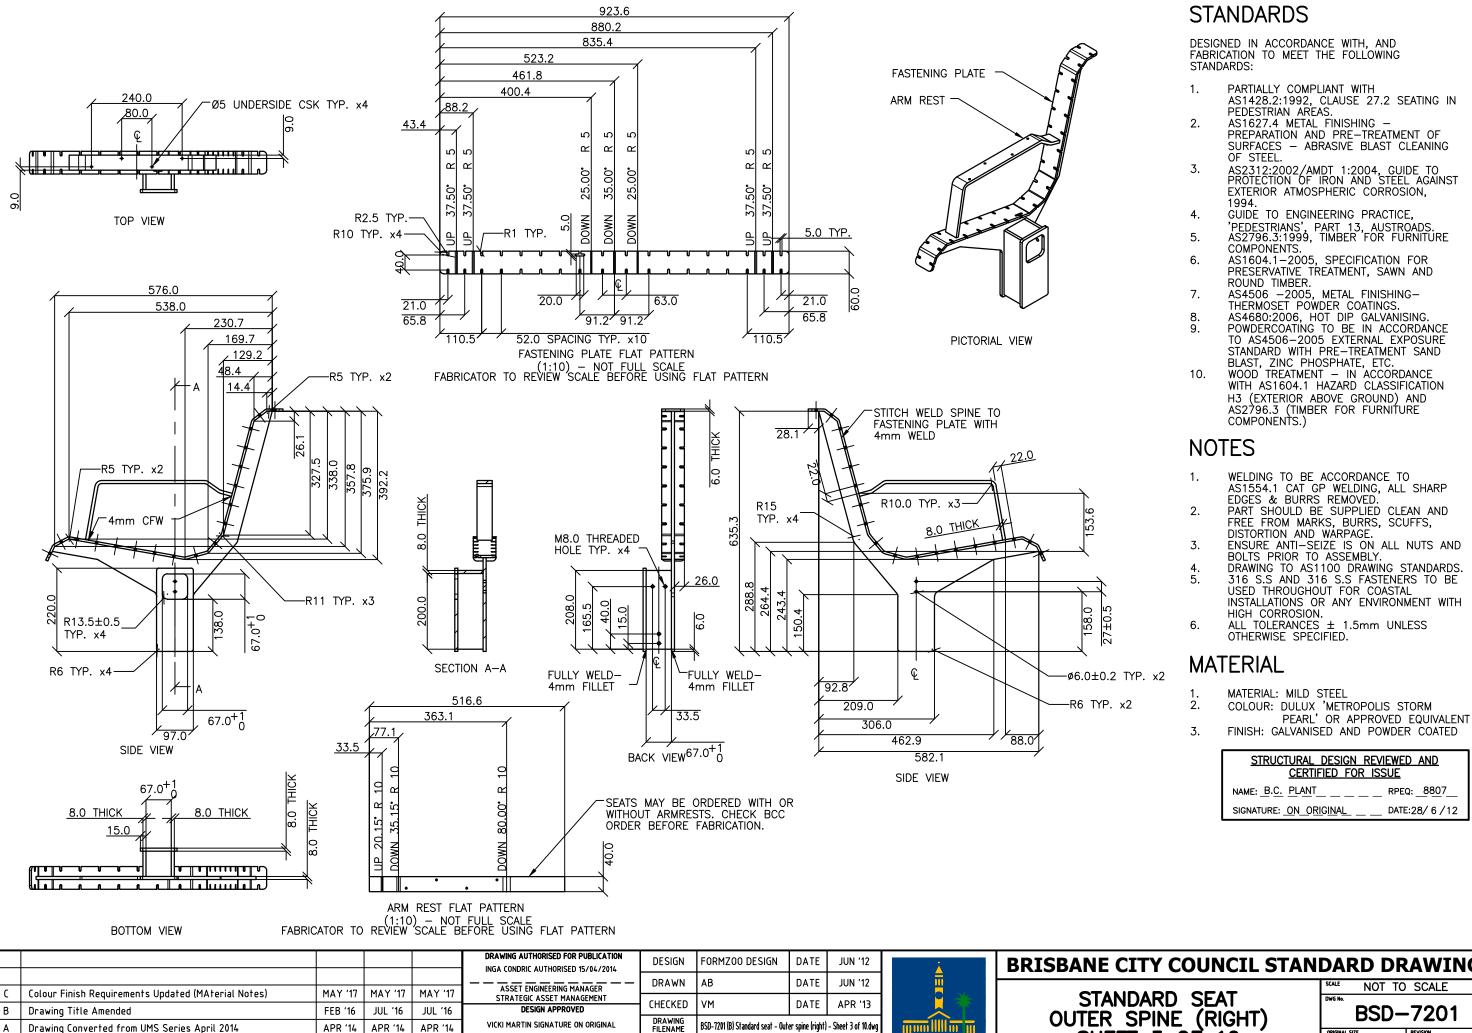

ASSOCIATED PLANS

SUPERSEDES UMS-563-3

PRINCIPAL PLANNING OFFICER URBAN DESIGN

DRAWN

ISSUE

**AMENDMENT** 

CHK'D

APPR'D

#### **BRISBANE CITY COUNCIL STANDARD DRAWING**


STANDARD SEAT OUTER SPINE (RIGHT) SHEET 3 OF 10

BRISBANECITY

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RPEQ: 8807

DATE:28/6/12

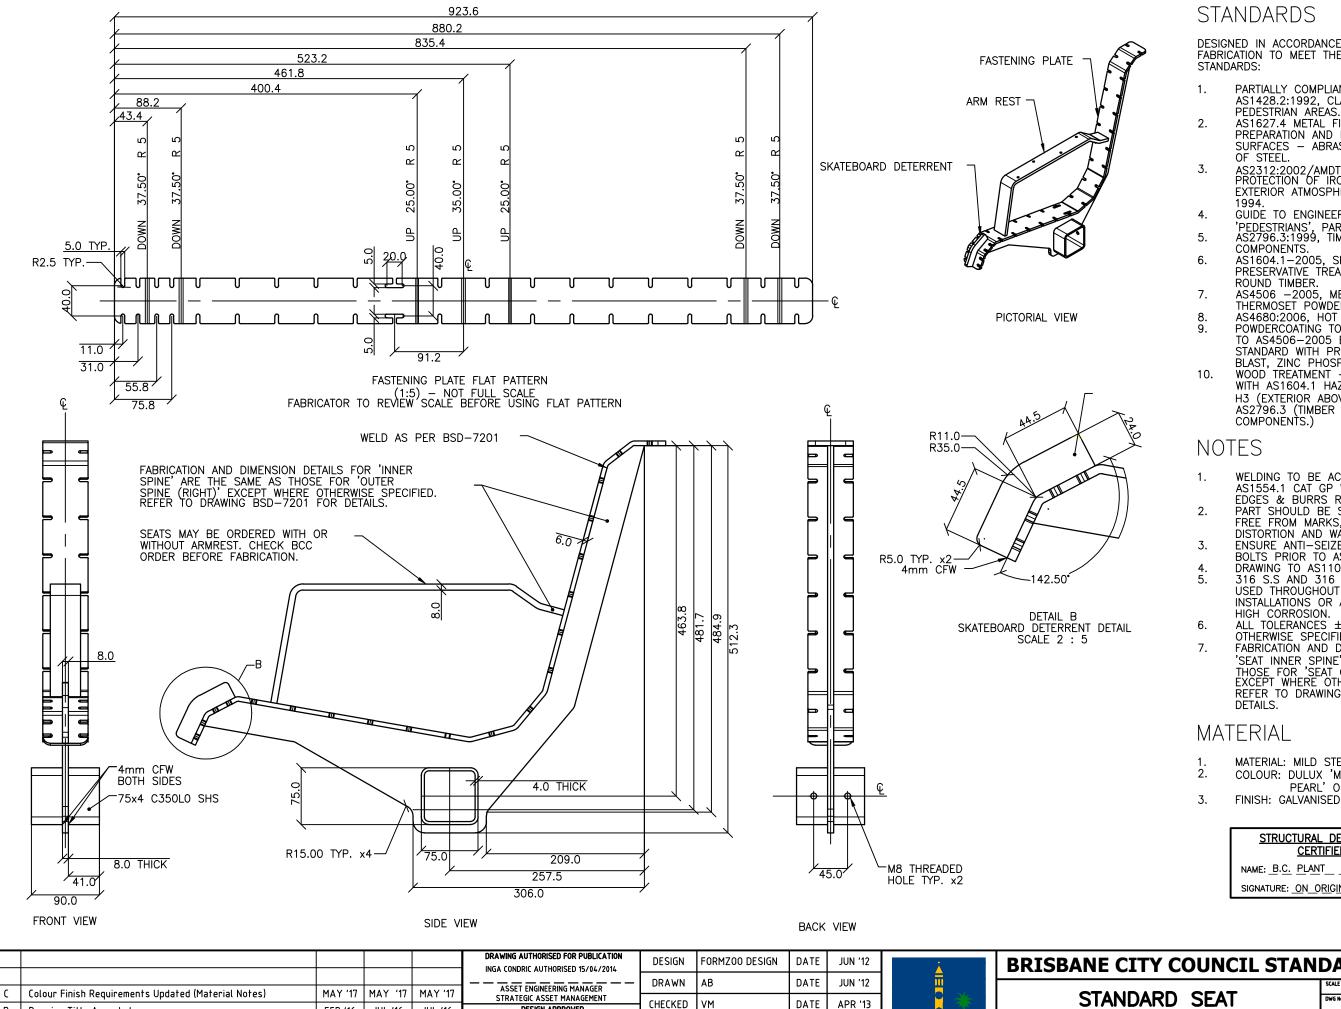

DESIGNED IN ACCORDANCE WITH, AND FABRICATION TO MEET THE FOLLOWING STANDARDS:

- PARTIALLY COMPLIANT WITH AS1428.2:1992, CLAUSE 27.2 SEATING IN
  - AS1627.4 METAL FINISHING —
    PREPARATION AND PRE—TREATMENT OF
    SURFACES ABRASIVE BLAST CLEANING
  - AS2312:2002/AMDT 1:2004, GUIDE TO PROTECTION OF IRON AND STEEL AGAINST EXTERIOR ATMOSPHERIC CORROSION,
  - GUIDE TO ENGINEERING PRACTICE,
- 'PEDESTRIANS', PART 13, AUSTROADS. AS2796.3:1999, TIMBER FOR FURNITURE
- COMPONENTS. AS1604.1-2005, SPECIFICATION FOR PRESERVATIVE TREATMENT, SAWN AND ROUND TIMBER.
- AS4506 -2005, METAL FINISHING-THERMOSET POWDER COATINGS. AS4680:2006, HOT DIP GALVANISING. POWDERCOATING TO BE IN ACCORDANCE
- TO AS4506-2005 EXTERNAL EXPOSURE STANDARD WITH PRE-TREATMENT SAND BLAST, ZINC PHOSPHATE, ETC.
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- WELDING TO BE ACCORDANCE TO AS1554.1 CAT GP WELDING, ALL SHARP EDGES & BURRS REMOVED.
- PART SHOULD BE SUPPLIED CLEAN AND FREE FROM MARKS, BURRS, SCUFFS,
- DISTORTION AND WARPAGE.
  ENSURE ANTI-SEIZE IS ON ALL NUTS AND BOLTS PRIOR TO ASSEMBLY.
  DRAWING TO AS1100 DRAWING STANDARDS.
- 316 S.S AND 316 S.S FASTENERS TO BE USED THROUGHOUT FOR COASTAL INSTALLATIONS OR ANY ENVIRONMENT WITH
- ALL TOLERANCES ± 1.5mm UNLESS OTHERWISE SPECIFIED.
- FABRICATION AND DIMENSION DETAILS FOR 'SEAT INNER SPINE' ARE THE SAME AS THOSE FOR 'SEAT OUTER SPINE (RIGHT)' EXCEPT WHERE OTHERWISE SPECIFIED.

  REFER TO DRAWING BSD—7201 FOR DETAILS
- MATERIAL: MILD STEEL
- COLOUR: DULUX 'METROPOLIS STORM
  - PEARL' OR APPROVED EQUIVALENT
- FINISH: GALVANISED AND POWDER COATED

STRUCTURAL DESIGN REVIEWED AND							
CERTIFIED FOR ISSUE							
NAME: B.C	. PLANT		R	PEQ:	8807		

SIGNATURE: ON ORIGINAL DATE:28/6/12


l	SSUE	AMENDMENT	DRAWN DATE	CHK'D DATE	APPR'D DATE	PRINCIPAL PLANNING OFFICER URBAN DESIGN	ASSOCIATED PLANS	SUPERSEDES UMS-563-4			
	Α	Drawing Converted from UMS Series April 2014	APR '14	APR '14	APR '14	VICKI MARTIN SIGNATURE ON ORIGINAL	DRAWING FILENAME	BSD-7201 (B) Standard seat - Inner spine - Sheet 4 of 10.dw		Sheet 4 of 10.dwg	
Г	В	Drawing Title Amended	FEB '16	JUL '16	JUL '16	DESIGN APPROVED		VM	DATE	APR '13	1
L	C	Colour Finish Requirements Updated (Material Notes)	MAY '17	MAY '17	MAY '17	STRATEGIC ASSET MANAGEMENT	CHECKED	104	5475	4.00.440	1
L						ASSET ENGINEERING MANAGER	DRAWN	АВ	DATE	JUN '12	ı
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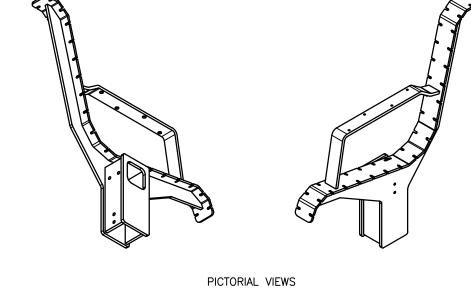
#### **BRISBANE CITY COUNCIL STANDARD DRAWING**


STANDARD SEAT INNER SPINE SHEET 4 OF 10


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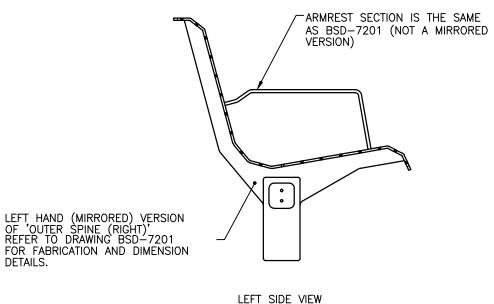


TOP VIEW




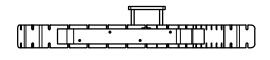

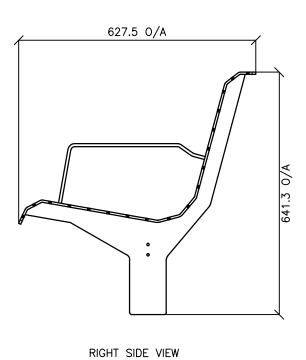

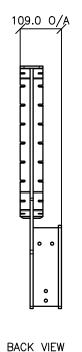


SUPERSEDES UMS-563-5

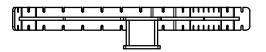

BOTTOM VIEW

**AMENDMENT** 

ISSUE

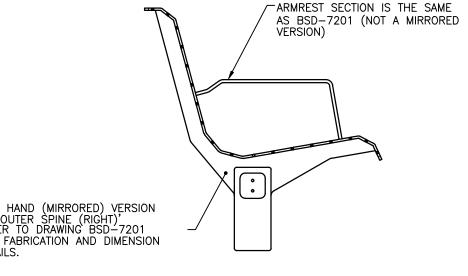

#### **BRISBANE CITY COUNCIL STANDARD DRAWING**

**STANDARDS** 

OF STEEL.

COMPONENTS.

ROUND TIMBER.

COMPONENTS.)

**NOTES** 

8.

6.

**MATERIAL** 

DESIGNED IN ACCORDANCE WITH, AND FABRICATION TO MEET THE FOLLOWING

PARTIALLY COMPLIANT WITH

AS1627.4 METAL FINISHING -

PEDESTRIAN AREAS.

AS1428.2:1992, CLAUSE 27.2 SEATING IN

PREPARATION AND PRE—TREATMENT OF SURFACES — ABRASIVE BLAST CLEANING

AS2312:2002/AMDT 1:2004, GUIDE TO PROTECTION OF IRON AND STEEL AGAINST EXTERIOR ATMOSPHERIC CORROSION,

GUIDE TO ENGINEERING PRACTICE, 'PEDESTRIANS', PART 13, AUSTROADS. AS2796.3:1999, TIMBER FOR FURNITURE

AS1604.1-2005, SPECIFICATION FOR PRESERVATIVE TREATMENT, SAWN AND

AS4506 -2005, METAL FINISHING-THERMOSET POWDER COATINGS.

BLAST, ZINC PHOSPHATE, ETC.

EDGES & BURRS REMOVED.

DISTORTION AND WARPAGE.

HIGH CORROSION.

OTHERWISE SPECIFIED.

MATERIAL: MILD STEEL

SIGNATURE: ON ORIGINAL \_\_\_\_

BOLTS PRIOR TO ASSEMBLY.

AS4680:2006, HOT DIP GALVANISING.
POWDERCOATING TO BE IN ACCORDANCE

TO AS4506-2005 EXTERNAL EXPOSURE STANDARD WITH PRE-TREATMENT SAND

WOOD TREATMENT - IN ACCORDANCE WITH AS1604.1 HAZARD CLASSIFICATION H3 (EXTERIOR ABOVE GROUND) AND AS2796.3 (TIMBER FOR FURNITURE

WELDING TO BE ACCORDANCE TO AS1554.1 CAT GP WELDING, ALL SHARP

PART SHOULD BE SUPPLIED CLEAN AND FREE FROM MARKS, BURRS, SCUFFS,

ENSURE ANTI-SEIZE IS ON ALL NUTS AND

DRAWING TO AS1100 DRAWING STANDARDS. 316 S.S AND 316 S.S FASTENERS TO BE USED THROUGHOUT FOR COASTAL INSTALLATIONS OR ANY ENVIRONMENT WITH

THIS IS A LEFT HAND (MIRRORED)
VERSION OF PART 'SEAT OUTER SPINE
(RIGHT)' — REFER TO DRAWING BSD—7201
FOR FABRICATION AND DIMENSION
DETAILS.

ALL TOLERANCES ± 1.5mm UNLESS

COLOUR: DULUX 'METROPOLIS STORM

FINISH: GALVANISED AND POWDER COATED

STRUCTURAL DESIGN REVIEWED AND CERTIFIED FOR ISSUE


NAME: <u>B.C. PLANT</u> \_ \_ \_ \_ RPEQ: <u>8807</u>

PEARL' OR APPROVED EQUIVALENT

STANDARD SEAT OUTER SPINE (LEFT) SHEET 5 OF 10


NOT TO SCALE BSD-7201


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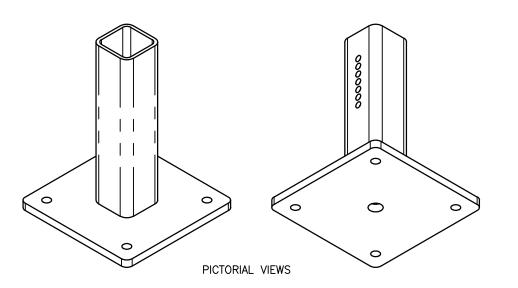


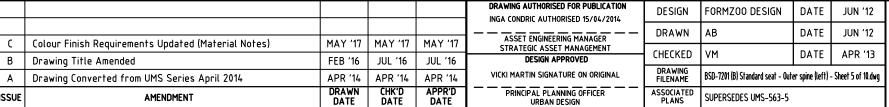DATE





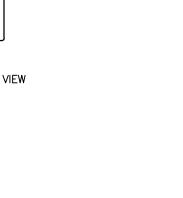

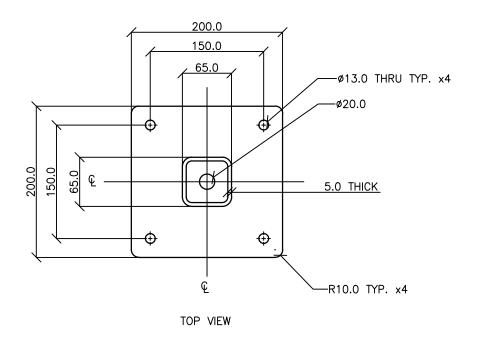

#### LEG LENGTH SUITS 450mm HIGH SEAT. LEG TO BE DOCKED TO LENGTH FOR SHORTER SEAT INSTALLATION (REFER BSD-7201). 18.0\_ 0/A 65x5mm C350L0 SHS 268.0 −D DIVOTS SPACED 12.5 CENTRES 6mm CFW DETAIL D TYPICAL GRUB SCREW DIVOT DETAIL REAR VIEW SECTION C-C FRONT VIEW SCALE 2:1

#### **STANDARDS**

DESIGNED IN ACCORDANCE WITH, AND FABRICATION TO MEET THE FOLLOWING STANDARDS:

- PARTIALLY COMPLIANT WITH AS1428.2:1992, CLAUSE 27.2 SEATING IN PEDESTRIAN AREAS.
  - AS1627.4 METAL FINISHING -PREPARATION AND PRE—TREATMENT OF SURFACES — ABRASIVE BLAST CLEANING OF STEEL.
- 3. AS2312:2002/AMDT 1:2004, GUIDE TO PROTECTION OF IRON AND STEEL AGAINST EXTERIOR ATMOSPHERIC CORROSION,
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- PART SHOULD BE SUPPLIED CLEAN AND FREE FROM MARKS, BURRS, SCUFFS, DISTORTION AND WARPAGE.
- ENSURE ANTI-SEIZE IS ON ALL NUTS AND BOLTS PRIOR TO ASSEMBLY.
- DRAWING TO AS1100 DRAWING STANDARDS.
- 316 S.S AND 316 S.S FASTENERS TO BE USED THROUGHOUT FOR COASTAL INSTALLATIONS OR ANY ENVIRONMENT WITH HIGH CORROSION.
- 6. ALL TOLERANCES ± 1.5mm UNLESS
- OTHERWISE SPECIFIED.
  SEAT FOOT IS THE SAME PART AS BENCH FOOT (REFER TO DRAWING BSD-7203)

#### MATERIAL

- MATERIAL: MILD STEEL
- COLOUR: DULUX 'METROPOLIS STORM
- PEARL' OR APPROVED EQUIVALENT FINISH: GALVANISED AND POWDER COATED

#### STRUCTURAL DESIGN REVIEWED AND **CERTIFIED FOR ISSUE**

NAME: B.C. PLANT \_\_ \_ \_ RPEQ: \_8807\_ SIGNATURE: ON ORIGINAL \_ \_ DATE:28/6/12

					DRAWING AUTHORISED FOR PUBLICATION INGA CONDRIC AUTHORISED 15/04/2014	DESIGN	FORMZOO DESIGN	DATE	JUN '12	
					ASSET ENGINEEDING MANAGED	DRAWN	АВ	DATE	JUN '12	
C	Finish Colour Requirements Updated (Matertial Notes)	MAY '16	MAY '16	MAY '16	STRATEGIC ASSET MANAGEMENT	CHECKED	V/M	DATE	4 DD 443	
В	Drawing Title Amended	FEB '16	JUL '16	JUL '16	DESIGN APPROVED		VM	DATE	APR '13	
Α	Drawing Converted from UMS Series April 2014	APR '14	APR '14	APR '14	VICKY MARTIN SIGNATURE ON ORIGINAL	DRAWING FILENAME	BSD-7201 (B) Standard seat - Foot - Sheet 6 of 10.dwg		ı	
ISSUE	AMENDMENT	DRAWN DATE	CHK'D DATE	APPR'D DATE	PRINCIPAL PLANNING OFFICER URBAN DESIGN	ASSOCIATED PLANS	SUPERSEDES UMS-563-6			




#### **BRISBANE CITY COUNCIL STANDARD DRAWING**

STANDARD SEAT **FOOT** SHEET 6 OF 10

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DESIGNED IN ACCORDANCE WITH, AND FABRICATION TO MEET THE FOLLOWING STANDARDS:

- PARTIALLY COMPLIANT WITH AS1428.2:1992, CLAUSE 27.2 SEATING IN PEDESTRIAN AREAS.
- AS1627.4 METAL FINISHING -PREPARATION AND PRE-TREATMENT OF SURFACES - ABRASIVE BLAST CLEANING
- AS2312:2002/AMDT 1:2004, GUIDE TO PROTECTION OF IRON AND STEEL AGAINST EXTERIOR ATMOSPHERIC CORROSION,
- GUIDE TO ENGINEERING PRACTICE,
  'PEDESTRIANS', PART 13, AUSTROADS.
  AS2796.3:1999, TIMBER FOR FURNITURE COMPONENTS.
- AS1604.1-2005, SPECIFICATION FOR PRESERVATIVE TREATMENT, SAWN AND ROUND TIMBER.
- AS4506 -2005, METAL FINISHING-THERMOSET POWDER COATINGS. AS4680:2006, HOT DIP GALVANISING.
  - POWDERCOATING TO BE IN ACCORDANCE TO AS4506-2005 EXTERNAL EXPOSURE STANDARD WITH PRE-TREATMENT SAND
- BLAST, ZINC PHOSPHATE, ETC. WOOD TREATMENT IN ACCORDANCE WITH AS1604.1 HAZARD CLASSIFICATION H3 (EXTERIOR ABOVE GROUND) AND AS2796.3 (TIMBER FOR FURNITURE COMPONENTS.)
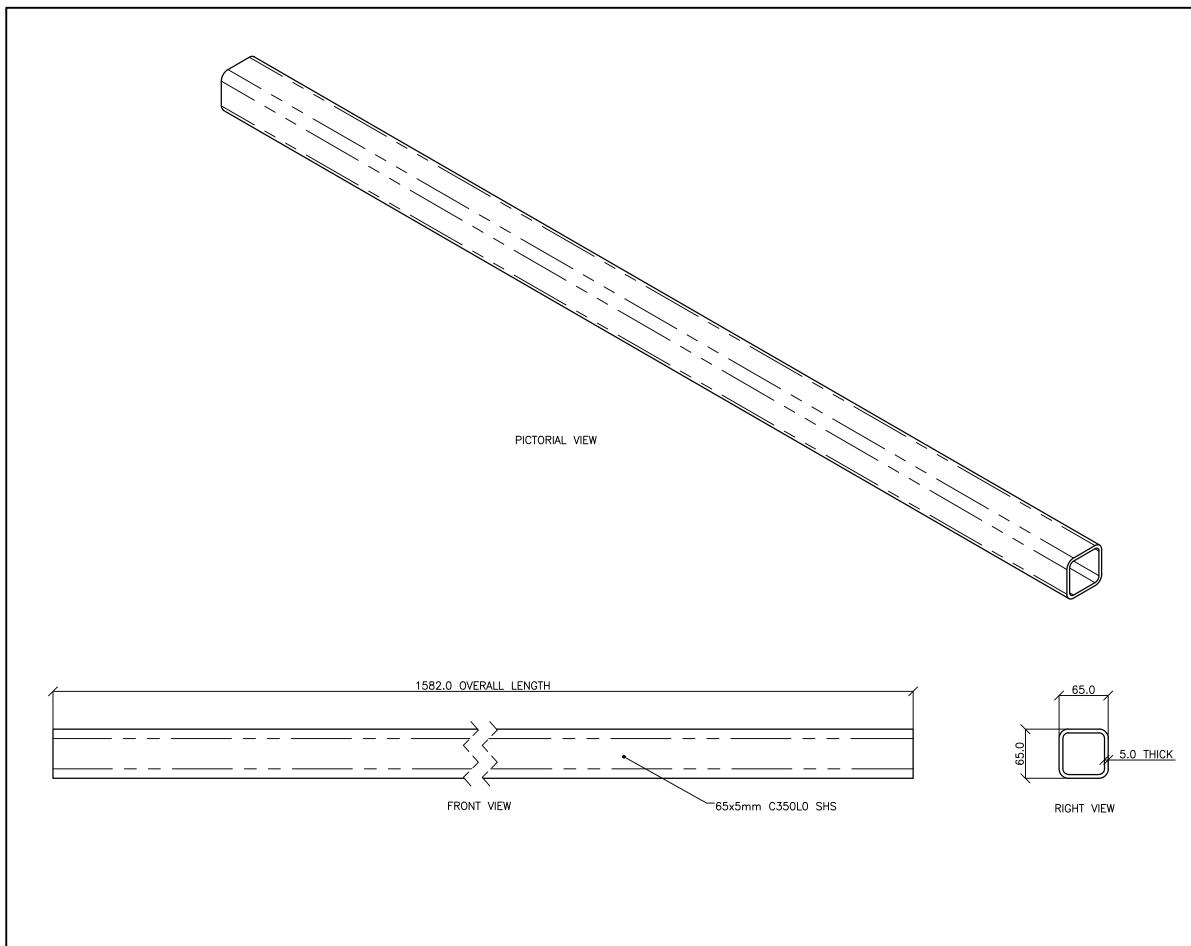
#### NOTES

- WELDING TO BE ACCORDANCE TO AS1554.1 CAT GP WELDING, ALL SHARP EDGES & BURRS REMOVED.
- PART SHOULD BE SUPPLIED CLEAN AND FREE FROM MARKS, BURRS, SCUFFS, DISTORTION AND WARPAGE.
- ENSURE ANTI-SEIZE IS ON ALL NUTS AND BOLTS PRIOR TO ASSEMBLY.
- DRAWING TO AS1100 DRAWING STANDARDS. 316 S.S AND 316 S.S FASTENERS TO BE USED THROUGHOUT FOR COASTAL INSTALLATIONS OR ANY ENVIRONMENT WITH
- HIGH CORROSION. ALL TOLERANCES ± 1.5mm UNLESS 6.
  - OTHERWISE SPECIFIED. SEAT RAIL IS THE SAME PART AS BENCH
- RAIL (REFER TO DRAWING BSD-7203)

#### MATERIAL

- MATERIAL: C350L0 SHS
  - COLOUR: DULUX 'METROPOLIS STORM PEARL' OR APPROVED EQUIVALENT
- FINISH: GALVANISED AND POWDER COATED

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	CERTIF	IED FO	OR IS	SUE	

NAME: B.C. PLANT\_\_ \_ \_ \_ \_ RPEQ: 8807 DATE:28/6/12 SIGNATURE: ON ORIGINAL


В	Drawing Title Amended	FEB '16	JUL '16	JUL '16	DESIGN APPROVED	DRAWING			
	Colour Finish Requirement Updated (Material Notes)  Drawing Title Amended	MAY '17 FEB '16	MAY '17 JUL '16	MAY '17 JUL '16	STRATEGIC ASSET MANAGEMENT  DESIGN APPROVED	CHECKED	VM	DATE	APR '13
					DRAWING AUTHORISED FOR PUBLICATION INGA CONDRIC AUTHORISED 15/04/2014 ASSET ENGINEERING MANAGER	DESIGN DRAWN	FORMZOO DESIGN AB	DATE DATE	JUN '12 JUN '12




#### **BRISBANE CITY COUNCIL STANDARD DRAWING**


STANDARD SEAT RAIL SHEET 7 OF 10


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#### STANDARD SEAT LONG SLAT

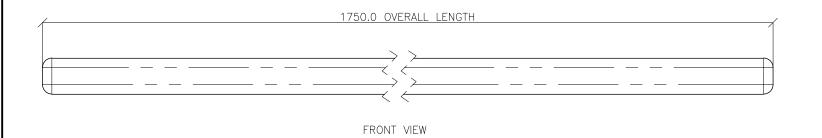


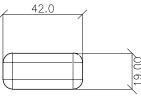


SIDE VIEW

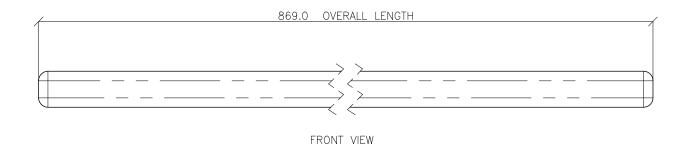SIDE VIEW

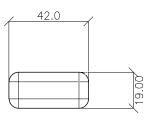
#### STANDARD SEAT SHORT SLAT

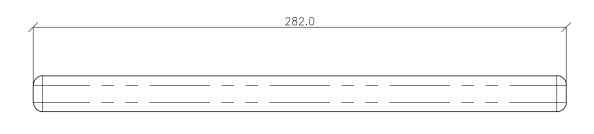

FRONT VIEW

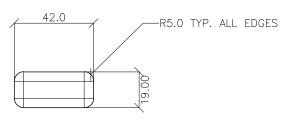

#### STANDARD SEAT ARM REST SLAT

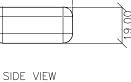

FABRICATION TO MEET THE FOLLOWING STANDARDS:

DESIGNED IN ACCORDANCE WITH, AND

STANDARDS

- PARTIALLY COMPLIANT WITH AS1428.2:1992, CLAUSE 27.2 SEATING IN PEDESTRIAN AREAS.
  - AS1627.4 METAL FINISHING PREPARATION AND PRE-TREATMENT OF SURFACES - ABRASIVE BLAST CLEANING OF STEEL
- AS2312:2002/AMDT 1:2004, GUIDE TO PROTECTION OF IRON AND STEEL AGAINST EXTERIOR ATMOSPHERIC CORROSION, 1994
- 4.
- GUIDE TO ENGINEERING PRACTICE,
  'PEDESTRIANS', PART 13, AUSTROADS.
  AS2796.3:1999, TIMBER FOR FURNITURE COMPONENTS.
- AS1604.1-2005, SPECIFICATION FOR PRESERVATIVE TREATMENT, SAWN AND ROUND TIMBER.
- AS4506 -2005, METAL FINISHING-
- THERMOSET POWDER COATINGS.
  AS4680:2006, HOT DIP GALVANISING.
  POWDERCOATING TO BE IN ACCORDANCE TO AS4506-2005 EXTERNAL EXPOSURE STANDARD WITH PRE-TREATMENT SAND
- BLAST, ZINC PHOSPHATE, ETC.
  WOOD TREATMENT IN ACCORDANCE WITH AS1604.1 HAZARD CLASSIFICATION H3 (EXTERIOR ABOVE GROUND) AND AS2796.3 (TIMBER FOR FURNITURE COMPONENTS.)

#### NOTES

- WELDING TO BE ACCORDANCE TO AS1554.1 CAT GP WELDING, ALL SHARP EDGES & BURRS REMOVED.
- PART SHOULD BE SUPPLIED CLEAN AND FREE FROM MARKS, BURRS, SCUFFS, DISTORTION AND WARPAGE.
- ENSURE ANTI-SEIZE IS ON ALL NUTS AND BOLTS PRIOR TO ASSEMBLY.
- DRAWING TO AS1100 DRAWING STANDARDS.
- 316 S.S AND 316 S.S FASTENERS TO BE USED THROUGHOUT FOR COASTAL INSTALLATIONS OR ANY ENVIRONMENT WITH HIGH CORROSION.
- ALL TOLERANCES ± 1.5mm UNLESS 6.
- OTHERWISE SPECIFIED.
  SEAT LONG SLAT IS THE SAME PART AS
  BENCH LONG SLAT (REFER TO DRAWING
- BSD-7201) SEAT SHORT SLAT IS THE SAME PART AS BENCH SHORT SLAT (REFER TO DRAWING
- BSD-7201) SEAT ARM REST SLAT IS THE SAME PART AS BENCH ARM REST SLAT (REFER TO DRAWING BSD-7201)

#### MATERIAL

- MATERIAL: HARDWOOD
- COLOUR: JARRAH STAIN
- FINISH: SMOOTH + WATER BASED FURNITURE OIL

STRUCTURAL DESIGN REV	IEWED AND
CERTIFIED FOR ISS	<u>SUE</u>
NAME: <u>B.C.</u> <u>PLANT</u>	RPEQ: <u>880</u> 7_
SIGNATURE: ON ORIGINAL	DATE:28/6/12


ISSUE	AMENDMENT	DRAWN DATE	CHK'D DATE	APPR'D DATE	PRINCIPAL PLANNING OFFICER URBAN DESIGN	ASSOCIATED PLANS	SUPERSEDES UMS-563-8		
А	Drawing Converted from UMS Series April 2014	APR '14	APR '14	APR '14	VIČKI MARTIN SIGNATURE ON ORIGINAL	DRAWING FILENAME	DRAWING FILENAME BSD-7201 (B) Standard seat - Timber		Sheet 8 of 10.dw
В	Drawing Title Amended	FEB '16	JUL '16	JUL '16	DESIGN APPROVED	CHECKED	VM	DATE	APR '13
					ASSET ENGINEERING MANAGER STRATEGIC ASSET MANAGEMENT				
						DRAWN	AB	DATE	JUN '12
					DRAWING AUTHORISED FOR PUBLICATION INGA CONDRIC AUTHORISED 15/04/2014	DESIGN	FORMZOO DESIGN	DATE	JUN '12




#### **BRISBANE CITY COUNCIL STANDARD DRAWING**

STANDARD SEAT TIMBER SLATS SHEET 8 OF 10

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PICTORIAL VIEW

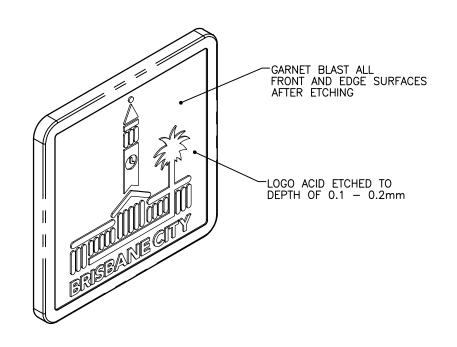

DESIGNED IN ACCORDANCE WITH, AND FABRICATION TO MEET THE FOLLOWING STANDARDS:

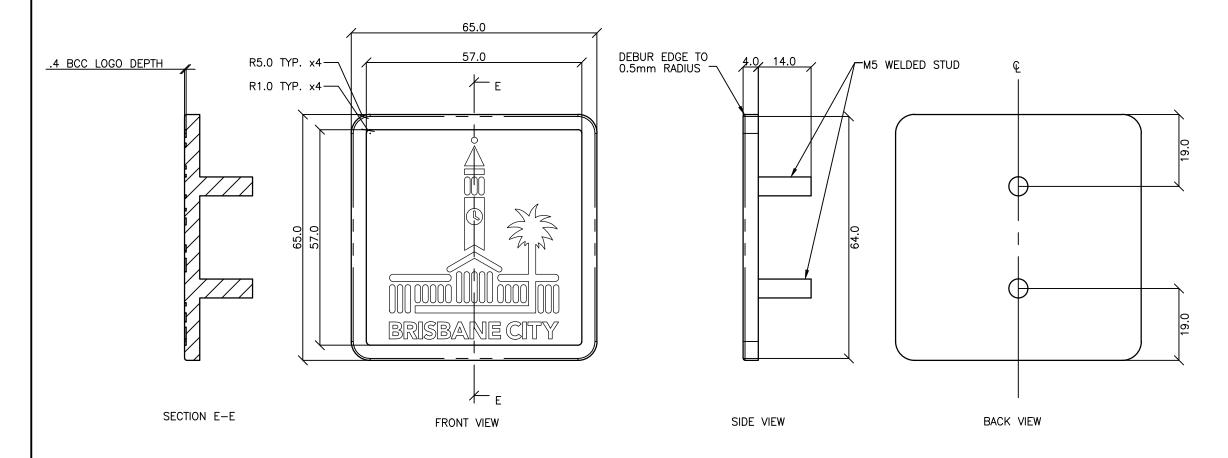- PARTIALLY COMPLIANT WITH AS1428.2:1992, CLAUSE 27.2 SEATING IN PEDESTRIAN AREAS.
- AS1627.4 METAL FINISHING -PREPARATION AND PRE-TREATMENT OF SURFACES - ABRASIVE BLAST CLEANING
- AS2312:2002/AMDT 1:2004, GUIDE TO PROTECTION OF IRON AND STEEL AGAINST EXTERIOR ATMOSPHERIC CORROSION,
- GUIDE TO ENGINEERING PRACTICE,
  'PEDESTRIANS', PART 13, AUSTROADS.
  AS2796.3:1999, TIMBER FOR FURNITURE 5. COMPONENTS.
- AS1604.1-2005, SPECIFICATION FOR PRESERVATIVE TREATMENT, SAWN AND ROUND TIMBER.
- AS4506 -2005, METAL FINISHING-THERMOSET POWDER COATINGS. AS4680:2006, HOT DIP GALVANISING.
- POWDERCOATING TO BE IN ACCORDANCE TO AS4506-2005 EXTERNAL EXPOSURE STANDARD WITH PRE-TREATMENT SAND BLAST, ZINC PHOSPHATE, ETC.
- WOOD TREATMENT IN ACCORDANCE WITH AS1604.1 HAZARD CLASSIFICATION H3 (EXTERIOR ABOVE GROUND) AND AS2796.3 (TIMBER FOR FURNITURE COMPONENTS.)

#### NOTES

- WELDING TO BE ACCORDANCE TO AS1554.1 CAT GP WELDING, ALL SHARP EDGES & BURRS REMOVED.
- PART SHOULD BE SUPPLIED CLEAN AND FREE FROM MARKS, BURRS, SCUFFS, DISTORTION AND WARPAGE.
- ENSURE ANTI-SEIZE IS ON ALL NUTS AND BOLTS PRIOR TO ASSEMBLY.
- DRAWING TO AS1100 DRAWING STANDARDS. 316 S.S AND 316 S.S FASTENERS TO BE
- USED THROUGHOUT FOR COASTAL INSTALLATIONS OR ANY ENVIRONMENT WITH HIGH CORROSION.
- ALL TOLERANCES ± 1.5mm UNLESS OTHERWISE SPECIFIED.
- SEAT LOGO BADGE IS THE SAME PART AS BENCH LOGO BADGE (REFER TO DRAWING BSD-7202)

#### MATERIAL

- MATERIAL: 316 STAINLESS STEEL
- COLOUR: NATURAL FINISH: GARNET BLASTED

#### STRUCTURAL DESIGN REVIEWED AND CERTIFIED FOR ISSUE

NAME: B.C. PLANT\_ \_ \_ \_ \_ \_ RPEQ: 8807 SIGNATURE: ON ORIGINAL \_\_\_\_ DATE:28/6/12


ISSUE	AMENDMENT	DRAWN DATE	CHK'D DATE	APPR'D DATE	PRINCIPAL PLANNING OFFICER URBAN DESIGN	ASSOCIATED PLANS	SUPERSEDES UMS-563-9			ĺ
Α	Drawing Converted from UMS Series April 2014	APR '14	APR '14	APR '14	VICKI MARTIN SIGNATURE ON ORIGINAL	DRAWING FILENAME	DRAWING FILENAME BSD-7201 (B) Standard seat - Logo badge		Sheet 9 of 10.dwg	ĺ
В	DRawing Title Amended	FEB '16	JUL '16	JUL '16	DESIGN APPROVED		VM	DATE	APR '13	ı
C	Logo Badge Acid Etch Depth Amended	MAY '17	MAY '17	May '17	ASSET ENGINEERING MANAGER STRATEGIC ASSET MANAGEMENT					l
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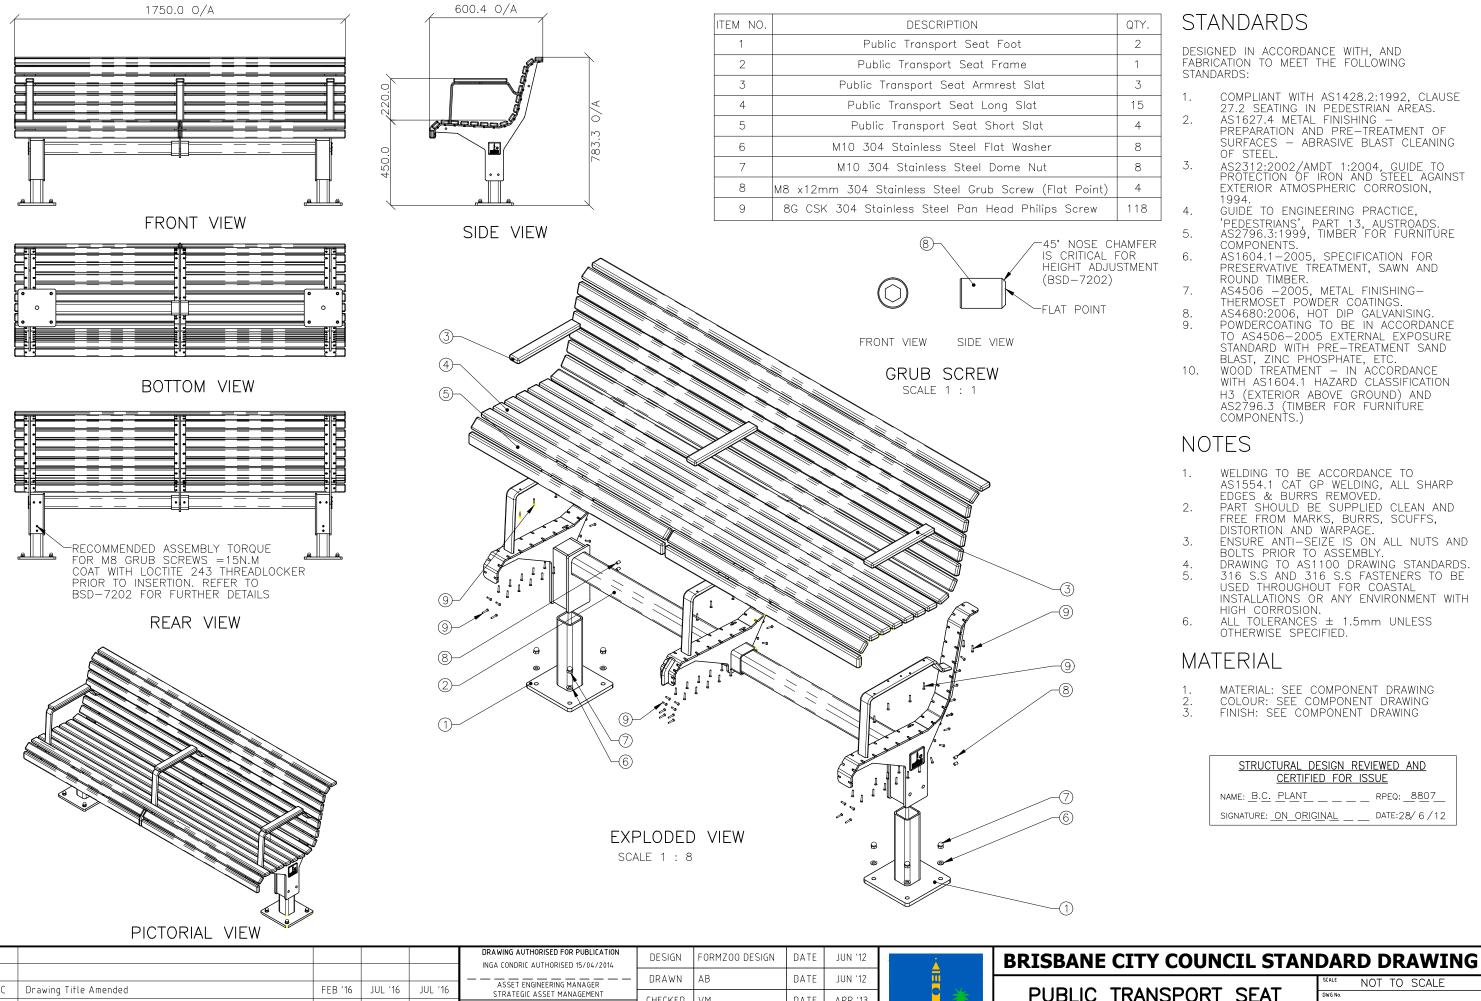


#### **BRISBANE CITY COUNCIL STANDARD DRAWING**

STANDARD SEAT LOGO BADGE SHEET 9 OF 10

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DESIGNED IN ACCORDANCE WITH, AND FABRICATION TO MEET THE FOLLOWING

- COMPLIANT WITH AS1428.2:1992, CLAUSE
- PREPARATION AND PRE—TREATMENT OF SURFACES ABRASIVE BLAST CLEANING
- AS2312:2002/AMDT 1:2004, GUIDE TO PROTECTION OF IRON AND STEEL AGAINST EXTERIOR ATMOSPHERIC CORROSION,
- GUIDE TO ENGINEERING PRACTICE,
- 'PEDESTRIANS', PART 13, AUSTROADS. AS2796.3:1999, TIMBER FOR FURNITURE
- AS1604.1-2005, SPECIFICATION FOR PRESERVATIVE TREATMENT, SAWN AND
- AS4680:2006, HOT DIP GALVANISING. POWDERCOATING TO BE IN ACCORDANCE TO AS4506-2005 EXTERNAL EXPOSURE STANDARD WITH PRE-TREATMENT SAND
- H3 (EXTERIOR ABOVE GROUND) AND AS2796.3 (TIMBER FOR FURNITURE COMPONENTS.)
- WELDING TO BE ACCORDANCE TO AS1554.1 CAT GP WELDING, ALL SHARP
- PART SHOULD BE SUPPLIED CLEAN AND FREE FROM MARKS, BURRS, SCUFFS,
- ENSURE ANTI-SEIZE IS ON ALL NUTS AND BOLTS PRIOR TO ASSEMBLY.
- 316 S.S AND 316 S.S FASTENERS TO BE USED THROUGHOUT FOR COASTAL INSTALLATIONS OR ANY ENVIRONMENT WITH
- ALL TOLERANCES ± 1.5mm UNLESS

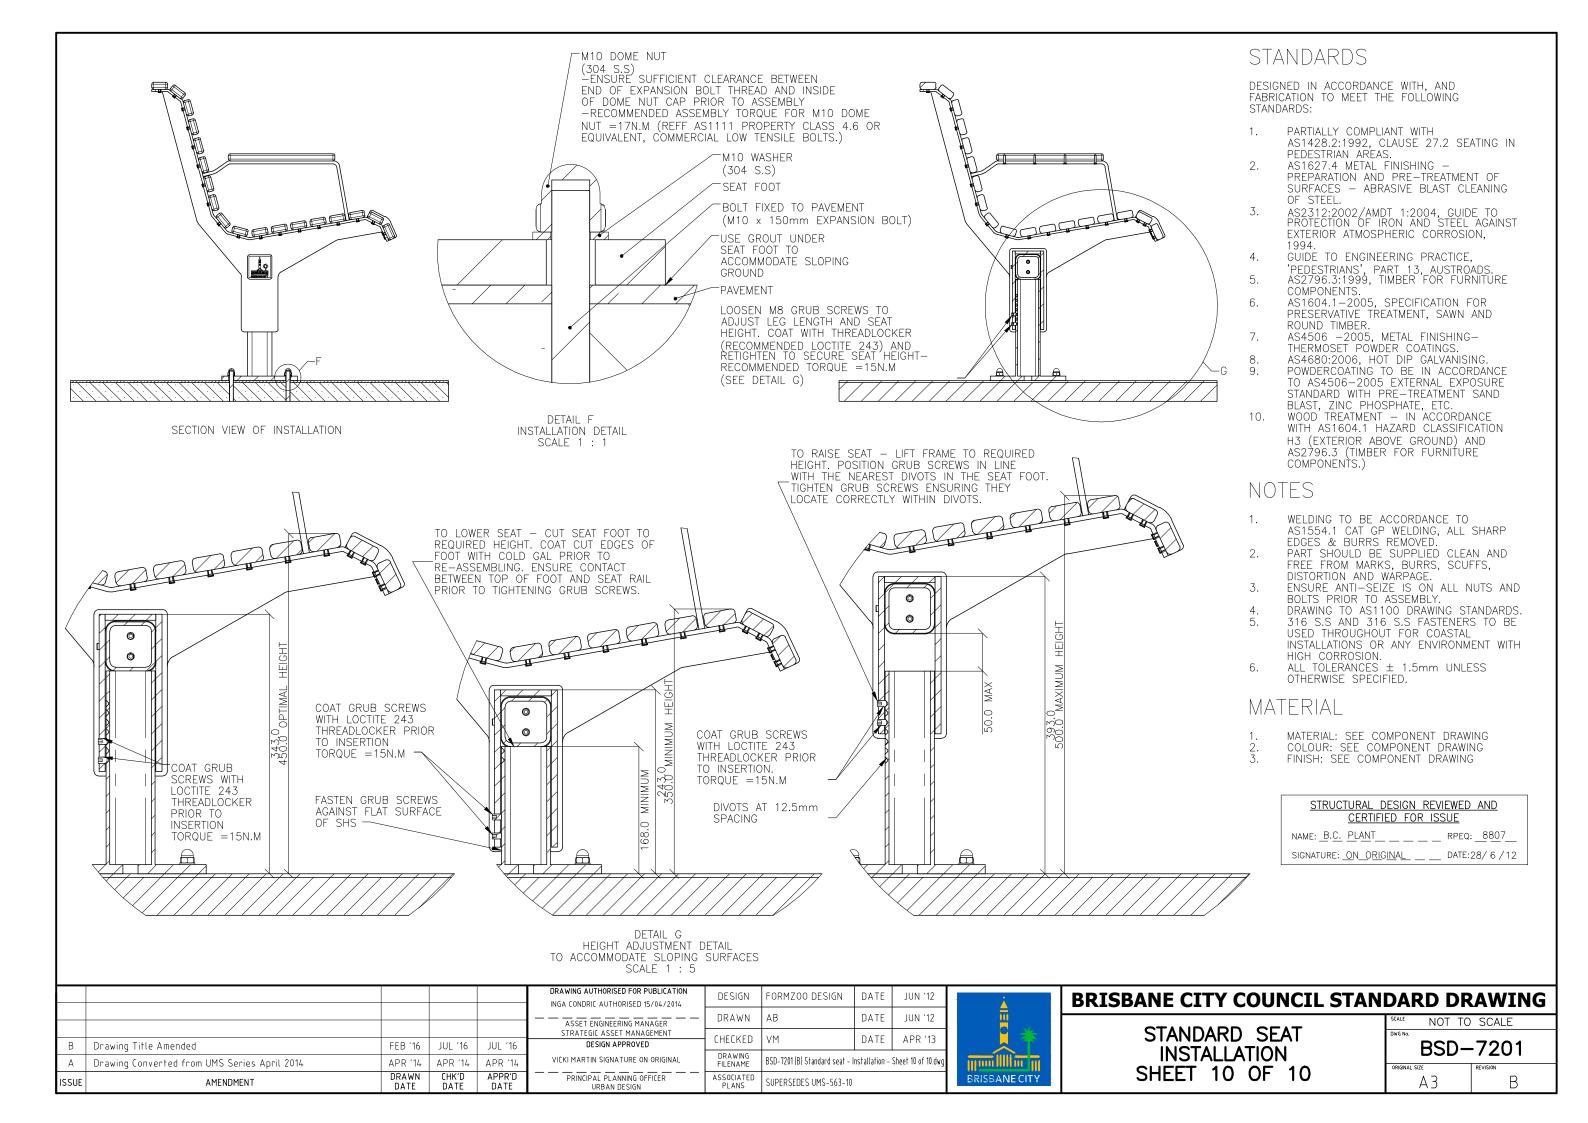- FINISH: SEE COMPONENT DRAWING

#### STRUCTURAL DESIGN REVIEWED AND CERTIFIED FOR ISSUE

NAME: <u>B.C. PLANT</u> \_\_ \_ \_ \_ RPEQ: <u>8807</u>


SIGNATURE: ON ORIGINAL \_ DATE: 28/6/12


					DRAWING AUTHORISED FOR PUBLICATION INGA CONDRIC AUTHORISED 15/04/2014	DESIGN	FORMZOO DESIGN	DATE	JUN '12
					ASSET ENGINEERING MANAGER	DRAWN	АВ	DATE	JUN '12
C	Drawing Title Amended	FEB '16	JUL '16	JUL '16	STRATEGIC ASSET MANAGEMENT	CHECKED	) / ) /	DATE	A DD (42)
В	Advertising panel amendments	SEPT '14	SEPT '14	SEPT '14	DESIGN APPROVED		VM	DATE	APR '13
А	Drawing Converted from UMS Series April 2014	APR '14	APR '14	APR '14	VICKI MARTIN SIGNATURE ON ORIGINAL DRAWING FILENAME BSD-7202 (C) Public transport seat		at - Assembly	- Sheet 1 of 10.dwg	
ISSUE	AMENDMENT	DRAWN DATE	CHK'D DATF	APPR'D DATE	PRINCIPAL PLANNING OFFICER URBAN DESIGN	ASSOCIATED PLANS	SUPERSEDES UMS-569-1		




PUBLIC TRANSPORT SEAT ASSEMBLY SHEET 1 OF 10

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CHECKED

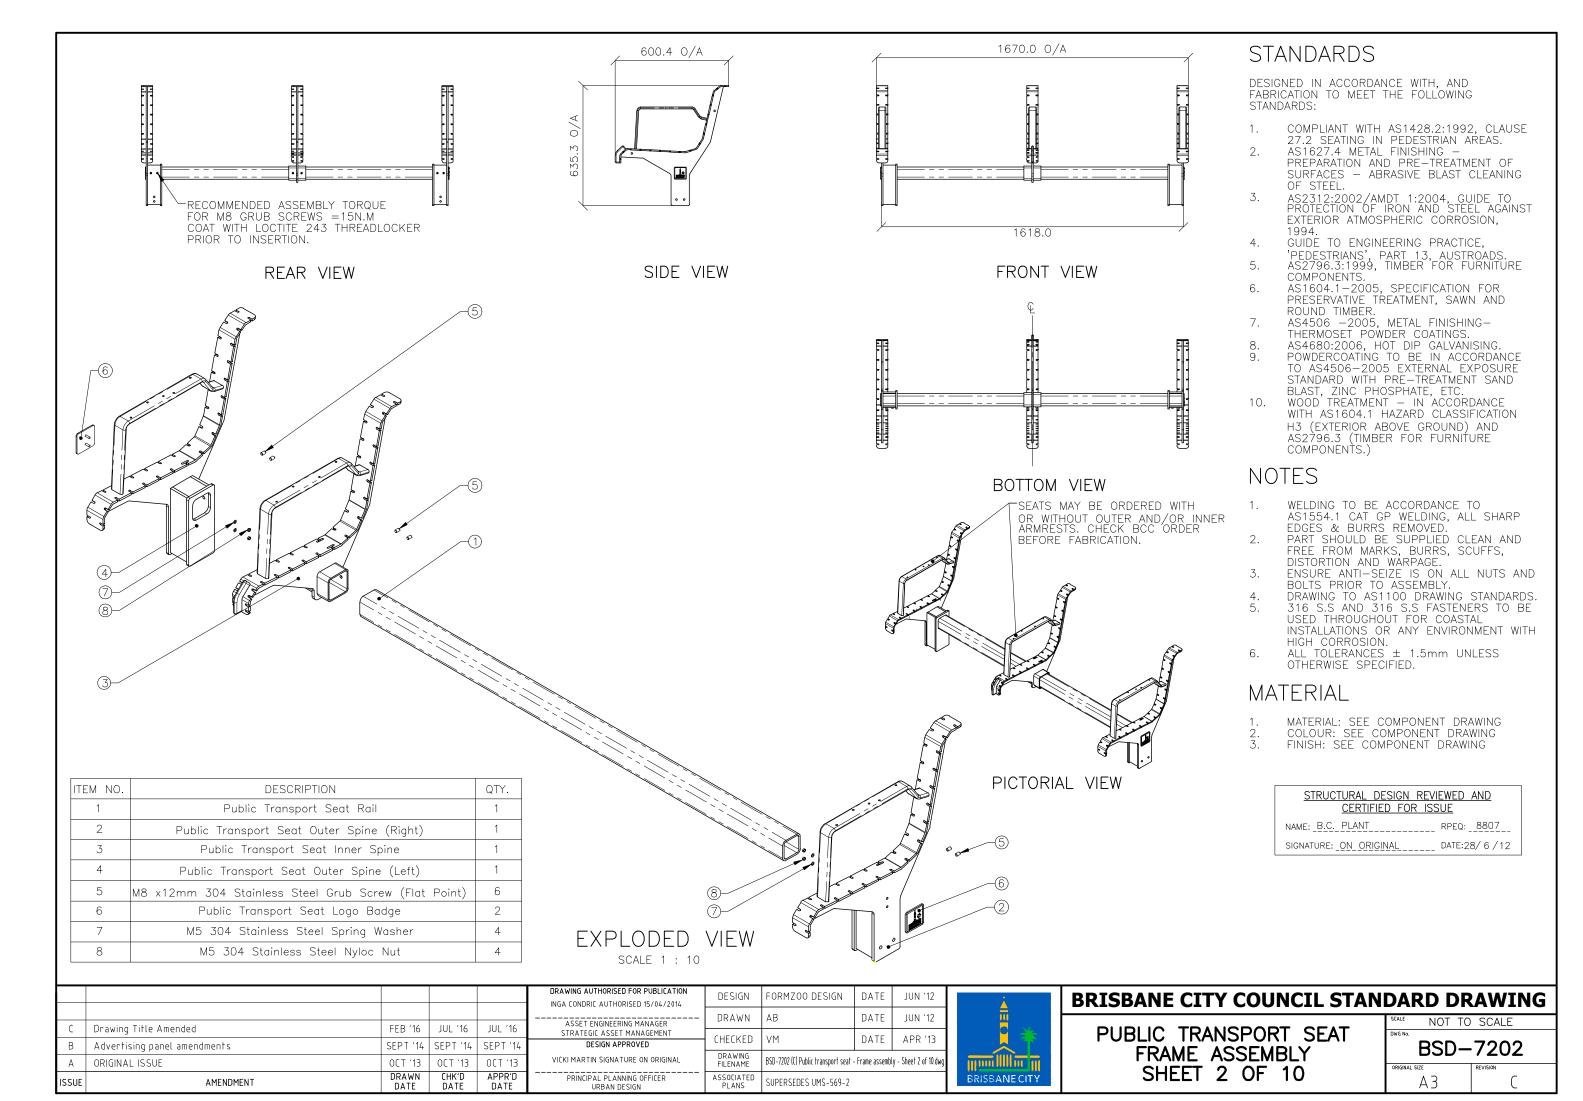DRAWING FILENAME

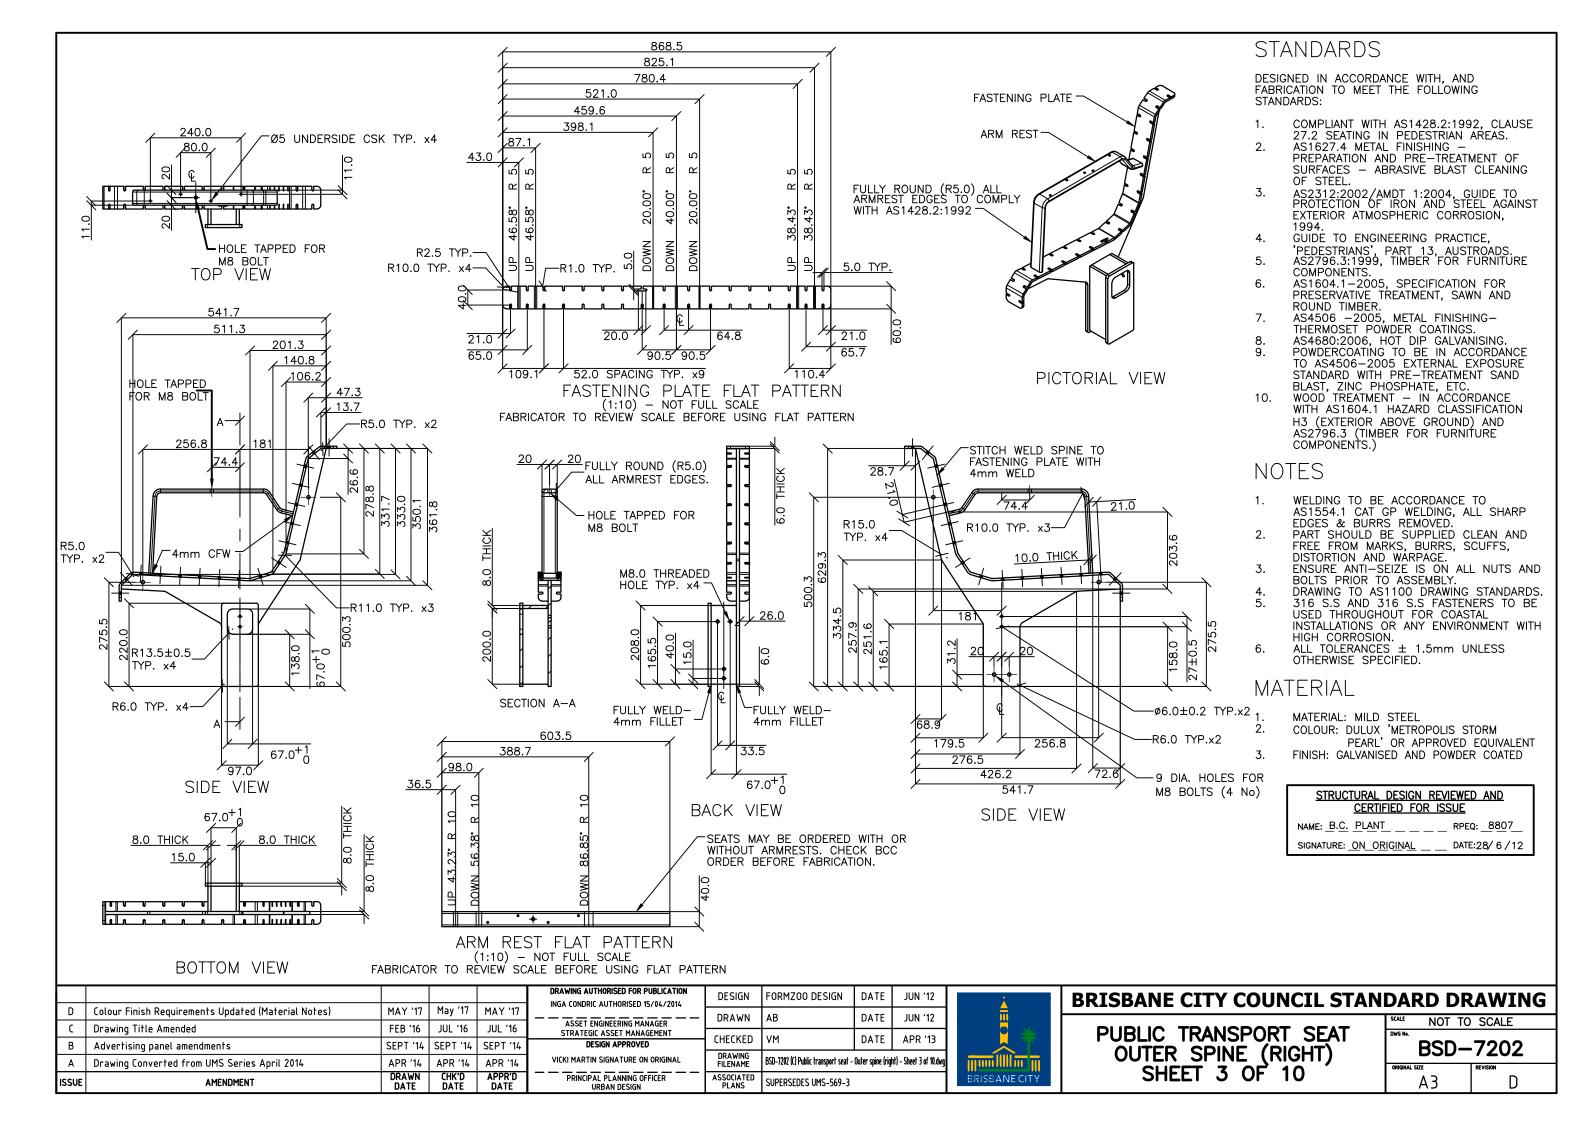ASSOCIATED PLANS

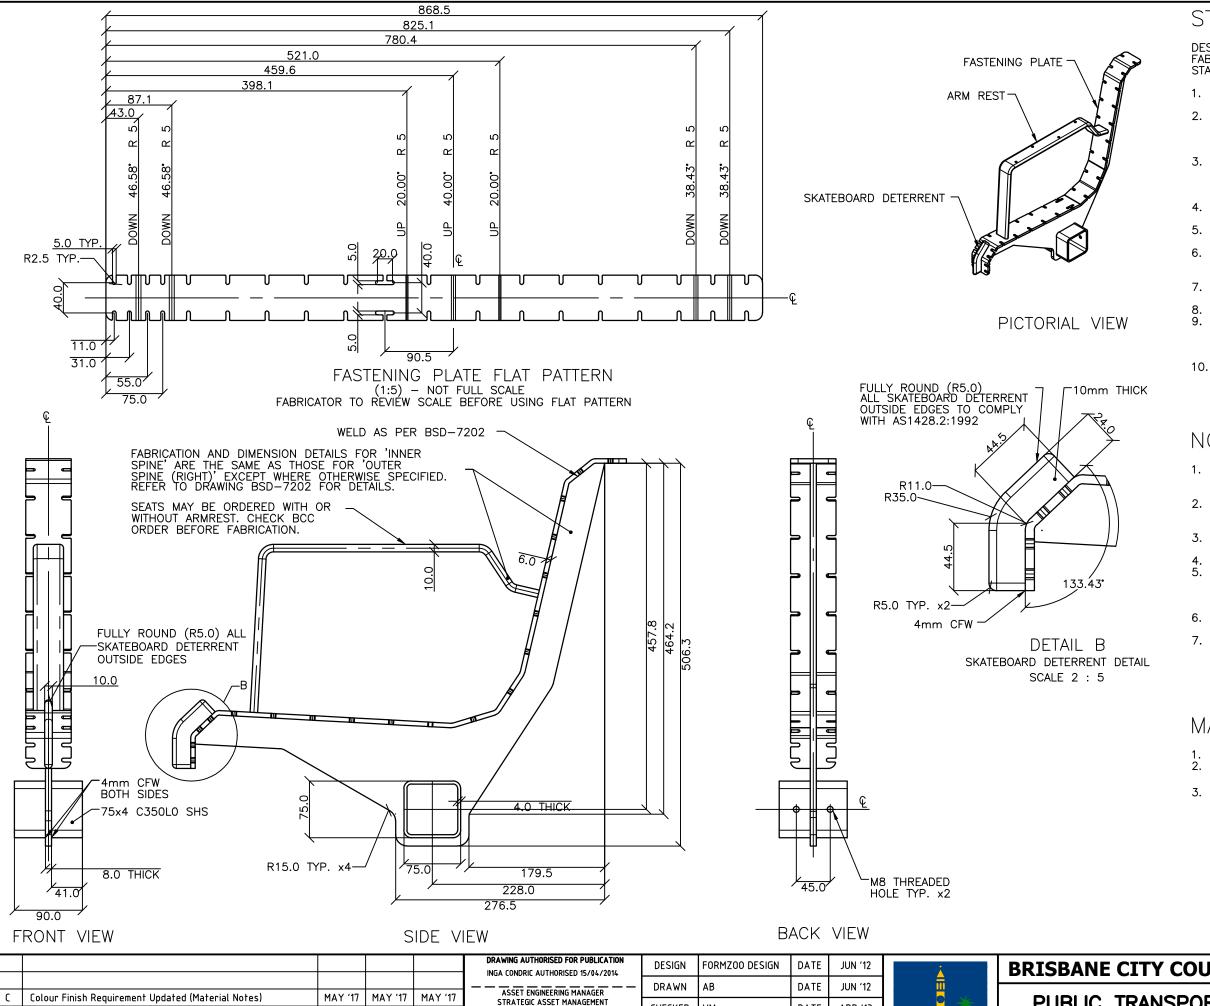DESIGN APPROVED

VICKI MARTIN SIGNATURE ON ORIGINAL

PRINCIPAL PLANNING OFFICER URBAN DESIGN

Drawing Title Amended

ISSUE

Drawing Converted from UMS Series April 2014

**AMENDMENT** 

FEB '16

APR '14

DRAWN

JUL '16

APR '14

CHK'D

JUL '16

**APR '14** 

APPR'D

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SUPERSEDES UMS-569-4

DATE

BSD-7202 (B) Public transport seat - Inner spine - Sheet 4 of 10.dw

APR '13

#### STANDARDS

DESIGNED IN ACCORDANCE WITH, AND FABRICATION TO MEET THE FOLLOWING STANDARDS:

- COMPLIANT WITH AS1428.2:1992, CLAUSE 27.2 SEATING IN PEDESTRIAN AREAS.
- AS1627.4 METAL FINISHING -PREPARATION AND PRE-TREATMENT OF SURFACES - ABRASIVE BLAST CLEANING OF STEEL.
- AS2312:2002/AMDT 1:2004, GUIDE TO PROTECTION OF IRON AND STEEL AGAINST EXTERIOR ATMOSPHERIC CORROSION,
- GUIDE TO ENGINEERING PRACTICE,
- 'PEDESTRIANS', PART 13, AUSTROADS. AS2796.3:1999, TIMBER FOR FURNITURE COMPONENTS.
- AS1604.1-2005, SPECIFICATION FOR PRESERVATIVE TREATMENT, SAWN AND ROUND TIMBER.
- AS4506 -2005, METAL FINISHING-THERMOSET POWDER COATINGS. AS4680:2006, HOT DIP GALVANISING.
- POWDERCOATING TO BE IN ACCORDANCE TO AS4506-2005 EXTERNAL EXPOSURE STANDARD WITH PRE-TREATMENT SAND BLAST, ZINC PHOSPHATE, ETC.
- WOOD TREATMENT IN ACCORDANCE WITH AS1604.1 HAZARD CLASSIFICATION H3 (EXTERIOR ABOVE GROUND) AND AS2796.3 (TIMBER FOR FURNITURE COMPONENTS.)

#### NOTES

- WELDING TO BE ACCORDANCE TO AS1554.1 CAT GP WELDING, ALL SHARP EDGES & BURRS REMOVED.
- PART SHOULD BE SUPPLIED CLEAN AND FREE FROM MARKS, BURRS, SCUFFS, DISTORTION AND WARPAGE
- ENSURE ANTI-SEIZE IS ON ALL NUTS AND BOLTS PRIOR TO ASSEMBLY.
- DRAWING TO AS1100 DRAWING STANDARDS. 316 S.S AND 316 S.S FASTENERS TO BE
- USED THROUGHOUT FOR COASTAL INSTALLATIONS OR ANY ENVIRONMENT WITH HIGH CORROSION.
- ALL TOLERANCES ± 1.5mm UNLESS OTHERWISE SPECIFIED.
- FABRICATION AND DIMENSION DETAILS FOR 'SEAT INNER SPINE' ARE THE SAME AS THOSE FOR 'SEAT OUTER SPINE (RIGHT)' EXCEPT WHERE OTHERWISE SPECIFIED. REFER TO DRAWING BSD-7202 FOR DETAILS.

#### MATERIAL

- MATERIAL: MILD STEEL
- COLOUR: DULUX 'METROPOLIS STORM PEARL' OR APPROVED EQUIVALENT
- FINISH: GALVANISED AND POWDER COATED


#### STRUCTURAL DESIGN REVIEWED AND CERTIFIED FOR ISSUE

NAME: B.C. PLANT \_\_ \_ \_ RPEQ: \_8807\_ SIGNATURE: ON ORIGINAL DATE:28/6/12


**BRISBANE CITY COUNCIL STANDARD DRAWING** 

PUBLIC TRANSPORT SEAT INNER SPINE SHEET 4 OF 10


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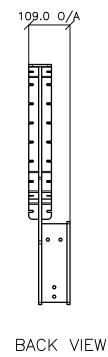


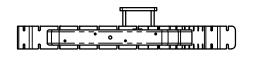
TOP VIEW

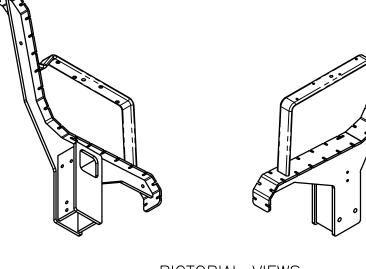

PICTORIAL VIEWS



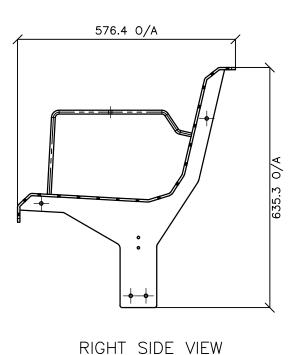

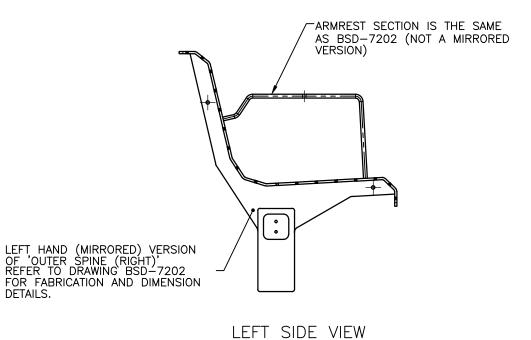

### BOTTOM VIEW

		DRAWN	CHK'D	APPR'D	PRINCIPAL PLANNING OFFICER	ASSOCIATED			
Α	Drawing Converted from UMS Series April 2014	APR '14	APR '14	APR '14	VICKI MARTIN SIGNATURE ON ORIGINAL	DRAWING FILENAME	BSD-7202 (C) Public transport seat - O	uter spine (left) -	- Sheet 5 of 10.dwg
В	Advertising panel amendments	SEPT '14	SEPT '14	SEPT '14			VM	DATE	APR '13
C	Drawing Title Amended	FEB '16	JUL '16	JUL '16	ASSET ENGINEERING MANAGER STRATEGIC ASSET MANAGEMENT				
D	Colour Finish requirements Updated (Material Notes)	MAY '17	MAY '17	MAY '17		DRAWN	AB	DATE	JUN '12
					DRAWING AUTHORISED FOR PUBLICATION INGA CONDRIC AUTHORISED 15/04/2014	DESIGN	FORMZOO DESIGN	DATE	JUN '12



#### STANDARDS

DESIGNED IN ACCORDANCE WITH, AND FABRICATION TO MEET THE FOLLOWING

- COMPLIANT WITH AS1428.2:1992, CLAUSE 27.2 SEATING IN PEDESTRIAN AREAS.
- AS1627.4 METAL FINISHING -PREPARATION AND PRE-TREATMENT OF SURFACES - ABRASIVE BLAST CLEANING OF STEEL.
- AS2312:2002/AMDT 1:2004, GUIDE TO PROTECTION OF IRON AND STEEL AGAINST EXTERIOR ATMOSPHERIC CORROSION,
- GUIDE TO ENGINEERING PRACTICE,
- 'PEDESTRIANS', PART 13, AUSTROADS. AS2796.3:1999, TIMBER FOR FURNITURE
- COMPONENTS.
  AS1604.1-2005, SPECIFICATION FOR PRESERVATIVE TREATMENT, SAWN AND ROUND TIMBER.
- AS4506 -2005, METAL FINISHING-THERMOSET POWDER COATINGS. AS4680:2006, HOT DIP GALVANISING. POWDERCOATING TO BE IN ACCORDANCE TO AS4506-2005 EXTERNAL EXPOSURE STANDARD WITH PRE-TREATMENT SAND
- BLAST, ZINC PHOSPHATE, ETC.
  WOOD TREATMENT IN ACCORDANCE
  WITH AS1604.1 HAZARD CLASSIFICATION
  H3 (EXTERIOR ABOVE GROUND) AND
  AS2796.3 (TIMBER FOR FURNITURE
  COMPONENTS.)

#### NOTES

- WELDING TO BE ACCORDANCE TO AS1554.1 CAT GP WELDING, ALL SHARP EDGES & BURRS REMOVED.
- PART SHOULD BE SUPPLIED CLEAN AND FREE FROM MARKS, BURRS, SCUFFS, DISTORTION AND WARPAGE.
- ENSURE ANTI-SEIZE IS ON ALL NUTS AND BOLTS PRIOR TO ASSEMBLY.
- DRAWING TO AS1100 DRAWING STANDARDS. 316 S.S AND 316 S.S FASTENERS TO BE USED THROUGHOUT FOR COASTAL INSTALLATIONS OR ANY ENVIRONMENT WITH
- HIGH CORROSION. 6.
- HIGH CORROSION.
  ALL TOLERANCES ± 1.5mm UNLESS
  OTHERWISE SPECIFIED.
  THIS IS A LEFT HAND (MIRRORED)
  VERSION OF PART 'SEAT OUTER SPINE
  (RIGHT)' REFER TO DRAWING BSD-7202
  FOR FABRICATION AND DIMENSION
  DETAILS.

#### MATERIAL

- MATERIAL: MILD STEEL
- COLOUR: DULUX 'METROPOLIS STORM PEARL' OR APPROVED EQUIVALENT
- FINISH: GALVANISED AND POWDER COATED


#### STRUCTURAL DESIGN REVIEWED AND CERTIFIED FOR ISSUE


NAME: B.C. PLANT RPEQ: 8807 SIGNATURE: ON ORIGINAL DATE: 28/6/12


#### **BRISBANE CITY COUNCIL STANDARD DRAWING**


PUBLIC TRANSPORT SEAT OUTER SPINE (LEFT) SHEET 5 OF 10

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DETAIL D TYPICAL GRUB SCREW DIVOT DETAIL SCALE 2 : 1

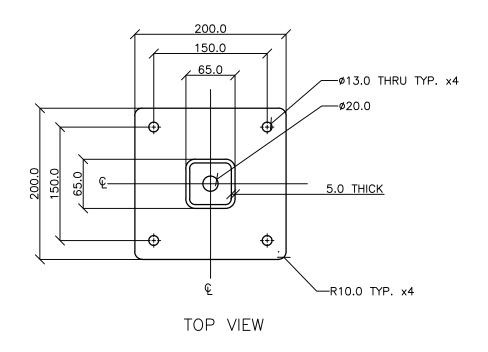DESIGNED IN ACCORDANCE WITH, AND FABRICATION TO MEET THE FOLLOWING STANDARDS:

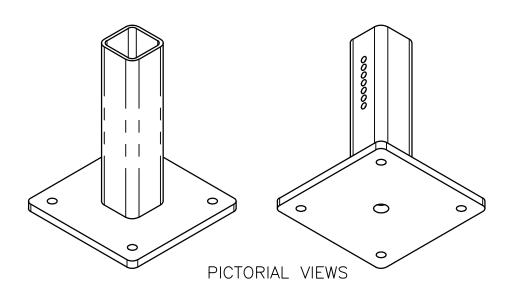- COMPLIANT WITH AS1428.2:1992, CLAUSE 27.2 SEATING IN PEDESTRIAN AREAS.
- AS1627.4 METAL FINISHING -PREPARATION AND PRE-TREATMENT OF SURFACES - ABRASIVE BLAST CLEANING OF STEEL.
- AS2312:2002/AMDT 1:2004, GUIDE TO PROTECTION OF IRON AND STEEL AGAINST EXTERIOR ATMOSPHERIC CORROSION, 3.
- GUIDE TO ENGINEERING PRACTICE,
- 'PEDESTRIANS', PART 13, AUSTROADS. AS2796.3:1999, TIMBER FOR FURNITURE COMPONENTS.
- AS1604.1-2005, SPECIFICATION FOR PRESERVATIVE TREATMENT, SAWN AND ROUND TIMBER.
- 7.
- AS4506 -2005, METAL FINISHING-THERMOSET POWDER COATINGS. AS4680:2006, HOT DIP GALVANISING. POWDERCOATING TO BE IN ACCORDANCE TO AS4506-2005 EXTERNAL EXPOSURE

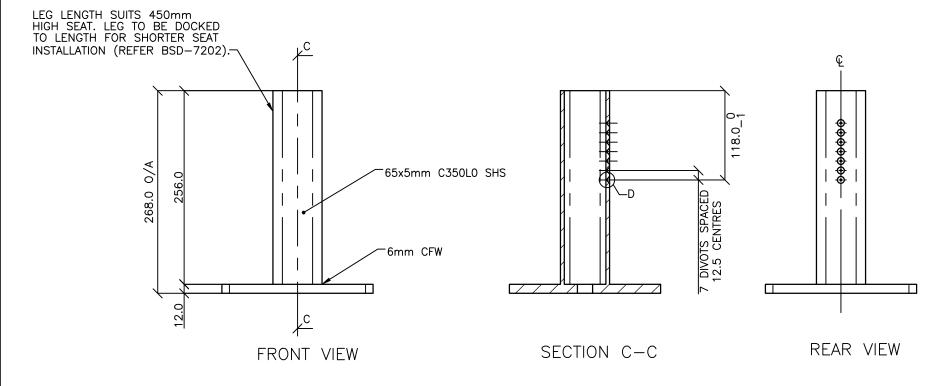STANDARD WITH PRE-TREATMENT SAND

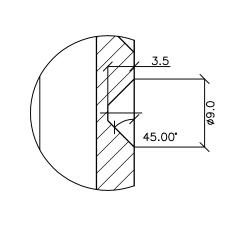BLAST, ZINC PHOSPHATE, ETC. WOOD TREATMENT - IN ACCORDANCE WITH AS1604.1 HAZARD CLASSIFICATION H3 (EXTERIOR ABOVE GROUND) AND AS2796.3 (TIMBER FOR FURNITURE COMPONENTS.)

#### NOTES

- WELDING TO BE ACCORDANCE TO AS1554.1 CAT GP WELDING, ALL SHARP EDGES & BURRS REMOVED.
- PART SHOULD BE SUPPLIED CLEAN AND FREE FROM MARKS, BURRS, SCUFFS, DISTORTION AND WARPAGE
- ENSURE ANTI-SEIZE IS ON ALL NUTS AND BOLTS PRIOR TO ASSEMBLY.
- DRAWING TO AS1100 DRAWING STANDARDS.
- 316 S.S AND 316 S.S FASTENERS TO BE USED THROUGHOUT FOR COASTAL INSTALLATIONS OR ANY ENVIRONMENT WITH HIGH CORROSION.
- ALL TOLERANCES ± 1.5mm UNLESS OTHERWISE SPECIFIED. SEAT FOOT IS THE SAME PART AS BENCH
- FOOT (REFER TO DRAWING BSD-7203)

#### MATERIAL

- MATERIAL: MILD STEEL
- COLOUR: DULUX 'METROPOLIS STORM PEARL' OR APPROVED EQUIVALENT
- FINISH: GALVANISED AND POWDER COATED

### STRUCTURAL DESIGN REVIEWED AND CERTIFIED FOR ISSUE

NAME: B.C. PLANT \_\_ \_ \_ RPEQ: \_8807\_ SIGNATURE: ON ORIGINAL \_\_\_\_ DATE:28/6/12

ISSUE	AMENDMENT	DRAWN DATE	CHK'D Date	APPR'D DATE	-
Α	Drawing Converted from UMS Series April 2014	APR '14	APR '14	APR '14	
В	Drawing Title Amended	FEB '16	JUL '16	JUL '16	
С	Colour Finish Requirement Updated (Material Notes)	MAY '17	MAY '17	MAY '17	
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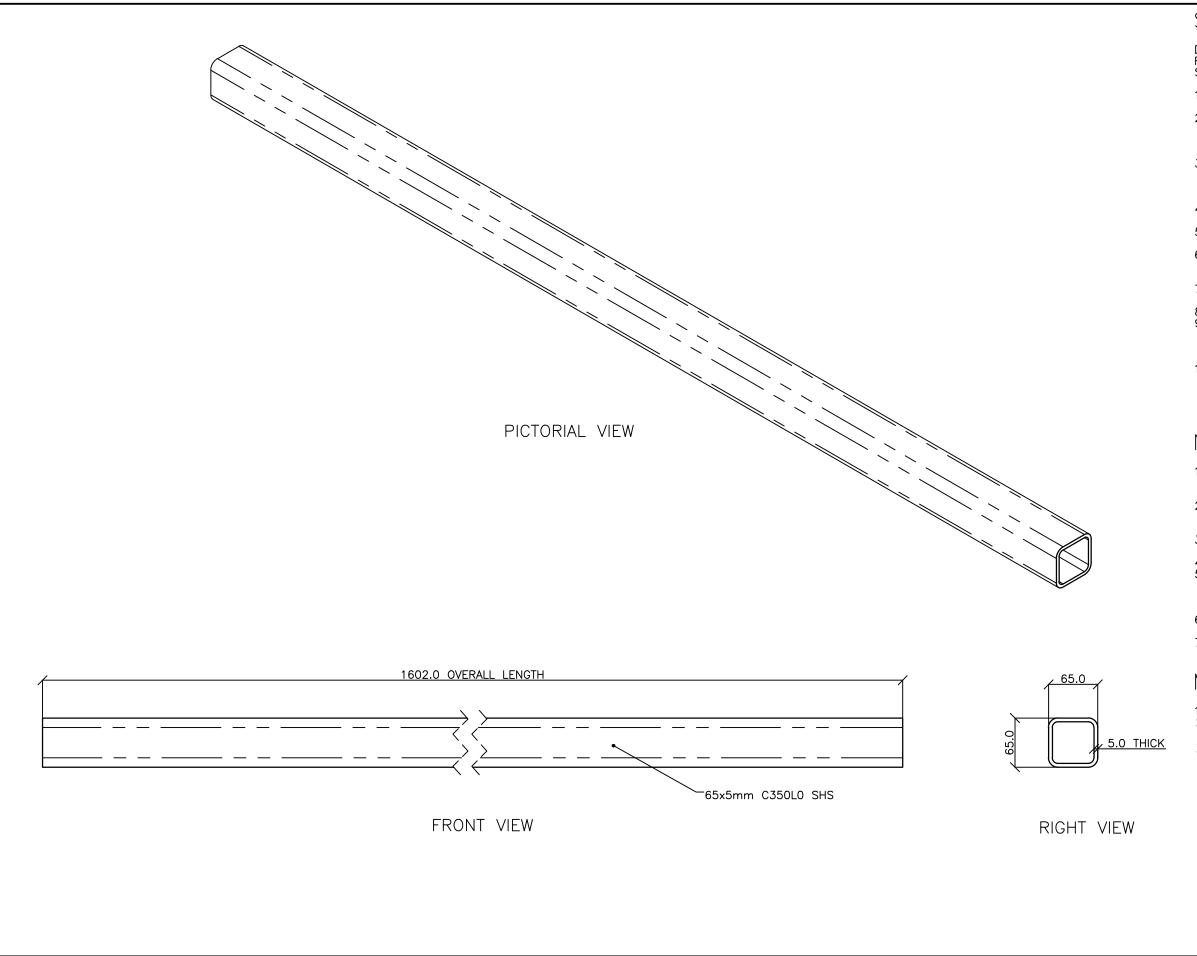
DRAWING AUTHORISED FOR PUBLICATION INGA CONDRIC AUTHORISED 15/04/2014	DESIGN	FORMZOO DESIGN	DATE	JUN '12	
ASSET ENGINEERING MANAGER	DRAWN	AB	DATE	JUN '12	
STRATEGIC ASSET MANAGEMENT  DESIGN APPROVED	CHECKED	VM	DATE	APR '13	
VICKI MARTIN SIGNATURE ON ORIGINAL	DRAWING FILENAME	BSD-7202 (B) Public transport seat - Foot - Sheet 6 of 10.dw			
PRINCIPAL PLANNING OFFICER	ASSOCIATED PLANS	SUPERSEDES UMS-569-6			



#### **BRISBANE CITY COUNCIL STANDARD DRAWING**

PUBLIC TRANSPORT SEAT **FOOT** SHEET 6 OF 10

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	BSD-7202						
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DESIGNED IN ACCORDANCE WITH, AND FABRICATION TO MEET THE FOLLOWING STANDARDS:

- COMPLIANT WITH AS1428.2:1992, CLAUSE 27.2 SEATING IN PEDESTRIAN AREAS.
- AS1627.4 METAL FINISHING -PREPARATION AND PRE-TREATMENT OF SURFACES - ABRASIVE BLAST CLEANING OF STEEL.
- AS2312:2002/AMDT 1:2004, GUIDE TO PROTECTION OF IRON AND STEEL AGAINST EXTERIOR ATMOSPHERIC CORROSION,
- GUIDE TO ENGINEERING PRACTICE,
- 'PEDESTRIANS', PART 13, AUSTROADS. AS2796.3:1999, TIMBER FOR FURNITURE COMPONENTS.
- AS1604.1-2005, SPECIFICATION FOR PRESERVATIVE TREATMENT, SAWN AND ROUND TIMBER.
- AS4506 -2005, METAL FINISHING-THERMOSET POWDER COATINGS. AS4680:2006, HOT DIP GALVANISING. POWDERCOATING TO BE IN ACCORDANCE
- TO AS4506-2005 EXTERNAL EXPOSURE STANDARD WITH PRE-TREATMENT SAND
- BLAST, ZINC PHOSPHATE, ETC. WOOD TREATMENT IN ACCORDANCE WITH AS1604.1 HAZARD CLASSIFICATION H3 (EXTERIOR ABOVE GROUND) AND AS2796.3 (TIMBER FOR FURNITURE COMPONENTS.)

#### NOTES

- WELDING TO BE ACCORDANCE TO AS1554.1 CAT GP WELDING, ALL SHARP EDGES & BURRS REMOVED.
- PART SHOULD BE SUPPLIED CLEAN AND FREE FROM MARKS, BURRS, SCUFFS, DISTORTION AND WARPAGE.
- ENSURE ANTI-SEIZE IS ON ALL NUTS AND BOLTS PRIOR TO ASSEMBLY.
- DRAWING TO AS1100 DRAWING STANDARDS. 316 S.S AND 316 S.S FASTENERS TO BE
- USED THROUGHOUT FOR COASTAL INSTALLATIONS OR ANY ENVIRONMENT WITH HIGH CORROSION.
- ALL TOLERANCES ± 1.5mm UNLESS OTHERWISE SPECIFIED.
- SEAT RAIL IS THE SAME PART AS BENCH RAIL (REFER TO DRAWING BSD-7203)

#### MATERIAL

- MATERIAL: C350L0 SHS
- DULUX 'METROPOLIS STORM PEARL' OR APPROVED EQUIVALENT
- FINISH: GALVANISED AND POWDER COATED

#### STRUCTURAL DESIGN REVIEWED AND CERTIFIED FOR ISSUE

**RPEQ:** \_\_8807\_\_ SIGNATURE: \_ON\_ORIGINAL\_ \_\_ DATE: 28/6/1

					DRAWING AUTHORISED FOR PUBLICATION INGA CONDRIC AUTHORISED 15/04/2014	DESIGN
D	Colour Finish Requirements Updated (Material Notes)	MAY '17	MAY '17	MAY '17		DRAWN
С	Drawing Title Amended	FEB '16	JUL '16	JUL '16	ASSET ENGINEERING MANAGER STRATEGIC ASSET MANAGEMENT	
В	Advertising panel amendments	SEPT '14	SEPT '14	SEPT '14	DESIGN APPROVED	CHECKED
Α	Drawing Converted from UMS Series April 2014	APR '14	APR '14	APR '14	VICKI MARTIN SIGNATURE ON ORIGINAL	DRAWING FILENAME
ISSUE	AMENDMENT	DRAWN DATE	CHK'D DATE	APPR'D DATE	PRINCIPAL PLANNING OFFICER URBAN DESIGN	ASSOCIATED PLANS



FORMZOO DESIGN

SUPERSEDES UMS-569-7

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DATE

BSD-7202 (C) Public transport seat - Rail - Sheet 7 of 10.dwg

JUN '12


JUN '12

**APR '13** 


#### **BRISBANE CITY COUNCIL STANDARD DRAWING**

PUBLIC TRANSPORT SEAT RAIL SHEET 7 OF 10

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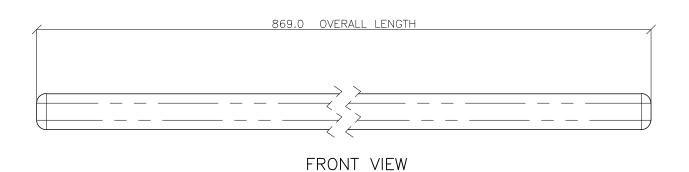


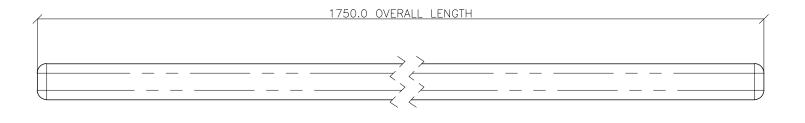
FRONT VIEW

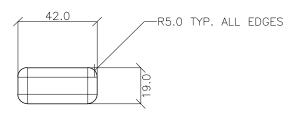

SIDE VIEW


#### PUBLIC TRANSPORT SEAT LONG SLAT




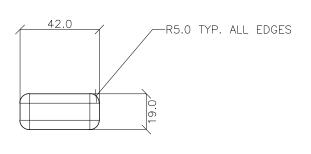

SIDE VIEW

#### PUBLIC TRANSPORT SEAT SHORT SLAT

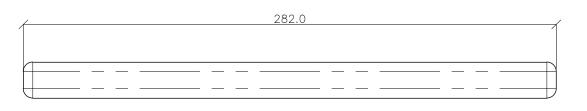

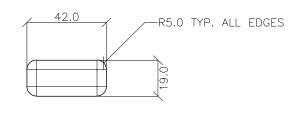

FRONT VIEW

PUBLIC TRANSPORT SFAT ARM REST SLAT

#### STANDARDS

DESIGNED IN ACCORDANCE WITH, AND FABRICATION TO MEET THE FOLLOWING STANDARDS:

- COMPLIANT WITH AS1428.2:1992, CLAUSE 27.2 SEATING IN PEDESTRIAN AREAS.
- AS1627.4 METAL FINISHING -PREPARATION AND PRE-TREATMENT OF SURFACES - ABRASIVE BLAST CLEANING OF STEEL.
- AS2312:2002/AMDT 1:2004, GUIDE TO PROTECTION OF IRON AND STEEL AGAINST EXTERIOR ATMOSPHERIC CORROSION,
- GUIDE TO ENGINEERING PRACTICE,
- 'PEDESTRIANS', PART 13, AUSTROADS. AS2796.3:1999, TIMBER FOR FURNITURE COMPONENTS.
- AS1604.1-2005, SPECIFICATION FOR PRESERVATIVE TREATMENT, SAWN AND ROUND TIMBER.
  - AS4506 -2005, METAL FINISHING-THERMOSET POWDER COATINGS. AS4680:2006, HOT DIP GALVANISING.
- POWDERCOATING TO BE IN ACCORDANCE TO AS4506-2005 EXTERNAL EXPOSURE STANDARD WITH PRE-TREATMENT SAND
- BLAST, ZINC PHOSPHATE, ETC. WOOD TREATMENT IN ACCORDANCE WITH AS1604.1 HAZARD CLASSIFICATION H3 (EXTERIOR ABOVE GROUND) AND AS2796.3 (TIMBER FOR FURNITURE COMPONENTS.)

#### NOTES

- WELDING TO BE ACCORDANCE TO AS1554.1 CAT GP WELDING, ALL SHARP EDGES & BURRS REMOVED.
- PART SHOULD BE SUPPLIED CLEAN AND FREE FROM MARKS, BURRS, SCUFFS, DISTORTION AND WARPAGE
- ENSURE ANTI—SEIZE IS ON ALL NUTS AND BOLTS PRIOR TO ASSEMBLY.
- DRAWING TO AS1100 DRAWING STANDARDS.
- 316 S.S AND 316 S.S FASTENERS TO BE USED THROUGHOUT FOR COASTAL INSTALLATIONS OR ANY ENVIRONMENT WITH HIGH CORROSION.
- ALL TOLERANCES ± 1.5mm UNLESS OTHERWISE SPECIFIED.
  SEAT LONG SLAT IS THE SAME PART AS
- BENCH LONG SLAT (REFER TO DRAWING
- BSD-7203) SEAT SHORT SLAT IS THE SAME PART AS BENCH SHORT SLAT (REFER TO DRAWING
- BSD-7203) SEAT ARM REST SLAT IS THE SAME PART AS BENCH ARM REST SLAT (REFER TO DRAWING BSD-7203)

#### MATERIAL

- MATERIAL: HARDWOOD
- COLOUR: JARRAH STAIN
- FINISH: SMOOTH + WATER BASED FURNITURE OIL

STRUCTURAL DESIGN REVIEWED AND CERTIFIED FOR ISSUE NAME: <u>B.C. PLANT</u> \_\_ \_ \_ RPEQ: <u>880</u>7\_

SIGNATURE: ON ORIGINAL \_ DATE:28/6/12

ISSUE	AMENDMENT	DRAWN DATE	CHK'D DATE	APPR'D DATE	PRINCIPAL PLANNING OFFICER URBAN DESIGN	ASSOCIATED PLANS	SUPERSEDES UMS-569-8		
А	Drawing Converted from UMS Series April 2014	APR '14	APR '14	APR '14	VIĆKI MARTIN SIGNATURE ON ORIGINAL	DRAWING FILENAME	BSD-7202 (B) Public transport seat	t – Timber slats	- Sheet 8 of 10.dwg
В	Drawing Title Amended	FEB '16	JUL '16	JUL '16	DESIGN APPROVED	CHECKED	VM	DATE	APR '13
					ASSET ENGINEERING MANAGER STRATEGIC ASSET MANAGEMENT		AD		
						DRAWN	AB	DATE	JUN '12
					DRAWING AUTHORISED FOR PUBLICATION INGA CONDRIC AUTHORISED 15/04/2014	DESIGN	FORMZOO DESIGN	DATE	JUN '12



SIDE VIEW


### **BRISBANE CITY COUNCIL STANDARD DRAWING**

PUBLIC TRANSPORT SEAT TIMBER SLATS SHEET 8 OF 10

SCALE	NOT	TO	SCALE			
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# -GARNET BLAST ALL FRONT AND EDGE SURFACES AFTER ETCHING 0 LOGO ACID ETCHED TO DEPTH OF 0.1 - 0.2mm

PICTORIAL VIEW

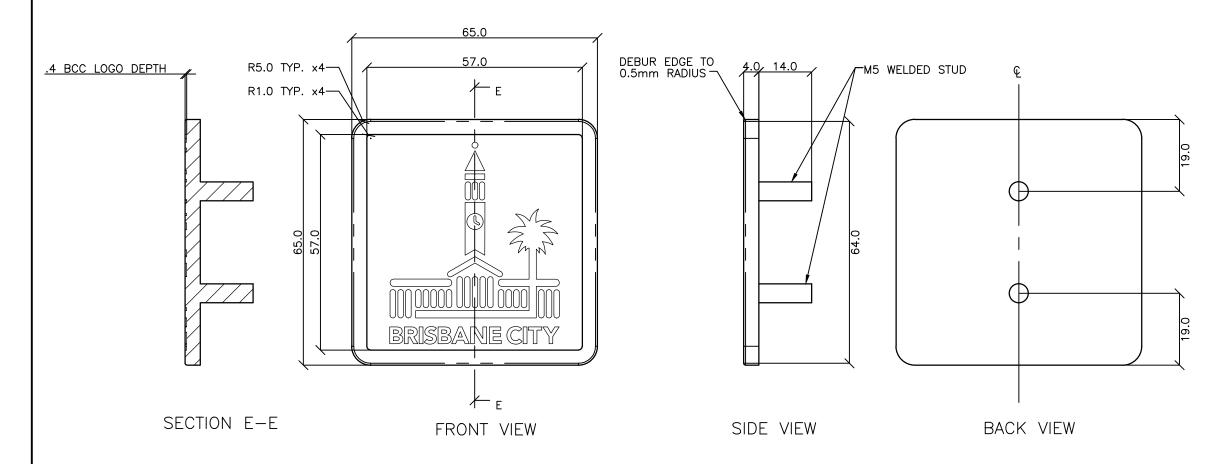

#### STANDARDS

DESIGNED IN ACCORDANCE WITH, AND FABRICATION TO MEET THE FOLLOWING STANDARDS:

- COMPLIANT WITH AS1428.2:1992, CLAUSE 27.2 SEATING IN PEDESTRIAN AREAS.
- AS1627.4 METAL FINISHING -PREPARATION AND PRE-TREATMENT OF SURFACES - ABRASIVE BLAST CLEANING OF STEEL.
- AS2312:2002/AMDT 1:2004, GUIDE TO PROTECTION OF IRON AND STEEL AGAINST EXTERIOR ATMOSPHERIC CORROSION, 3.
- GUIDE TO ENGINEERING PRACTICE,
- 'PEDESTRIANS', PART 13, AUSTROADS. AS2796.3:1999, TIMBER FOR FURNITURE COMPONENTS.
- AS1604.1-2005, SPECIFICATION FOR PRESERVATIVE TREATMENT, SAWN AND ROUND TIMBER.
- AS4506 -2005, METAL FINISHING-THERMOSET POWDER COATINGS. AS4680:2006, HOT DIP GALVANISING. POWDERCOATING TO BE IN ACCORDANCE
- TO AS4506-2005 EXTERNAL EXPOSURE STANDARD WITH PRE-TREATMENT SAND
- BLAST, ZINC PHOSPHATE, ETC.
  WOOD TREATMENT IN ACCORDANCE
  WITH AS1604.1 HAZARD CLASSIFICATION H3 (EXTERIOR ABOVE GROUND) AND AS2796.3 (TIMBER FOR FURNITURE COMPONENTS.)

#### NOTES

- WELDING TO BE ACCORDANCE TO AS1554.1 CAT GP WELDING, ALL SHARP EDGES & BURRS REMOVED.
- PART SHOULD BE SUPPLIED CLEAN AND FREE FROM MARKS, BURRS, SCUFFS, DISTORTION AND WARPAGE.
- ENSURE ANTI-SEIZE IS ON ALL NUTS AND BOLTS PRIOR TO ASSEMBLY.
- DRAWING TO AS1100 DRAWING STANDARDS. 316 S.S AND 316 S.S FASTENERS TO BE USED THROUGHOUT FOR COASTAL INSTALLATIONS OR ANY ENVIRONMENT WITH
- HIGH CORROSION. ALL TOLERANCES ± 1.5mm UNLESS OTHERWISE SPECIFIED.
- SEAT LOGO BADGE IS THE SAME PART AS BENCH LOGO BADGE (REFER TO DRAWING

#### MATERIAL

- MATERIAL: 316 STAINLESS STEEL
- COLOUR: NATURAL
- FINISH: GARNET BLASTED

#### STRUCTURAL DESIGN REVIEWED AND CERTIFIED FOR ISSUE

NAME: B.C. PLANT \_\_ \_ \_ RPEQ: \_8807\_ SIGNATURE: ON ORIGINAL \_ \_ DATE:28/6/12


С	Logo Badge Acid Etch Depth Amended		MAY '17		ASSET ENGINEERING MANAGER STRATEGIC ASSET MANAGEMENT		AB VM	DATE	JUN '12 APR '13
В	Drawing Title Amended  Drawing Converted from UMS Series April 2014	FEB '16 APR '14	JUL '16 APR '14	JUL '16 APR '14	<b>DESIGN APPROVED</b> VICKI MARTIN SIGNATURE ON ORIGINAL	DDAMING	BSD-7202 (B) Public transport sea		
ISSUE	,	DRAWN DATE	CHK'D DATE	APPR'D DATE	PRINCIPAL PLANNING OFFICER URBAN DESIGN	ACCOCIATED	SUPERSEDES UMS-569-9		





#### **BRISBANE CITY COUNCIL STANDARD DRAWING**


PUBLIC TRANSPORT SEAT LOGO BADGE SHEET 9 OF 10


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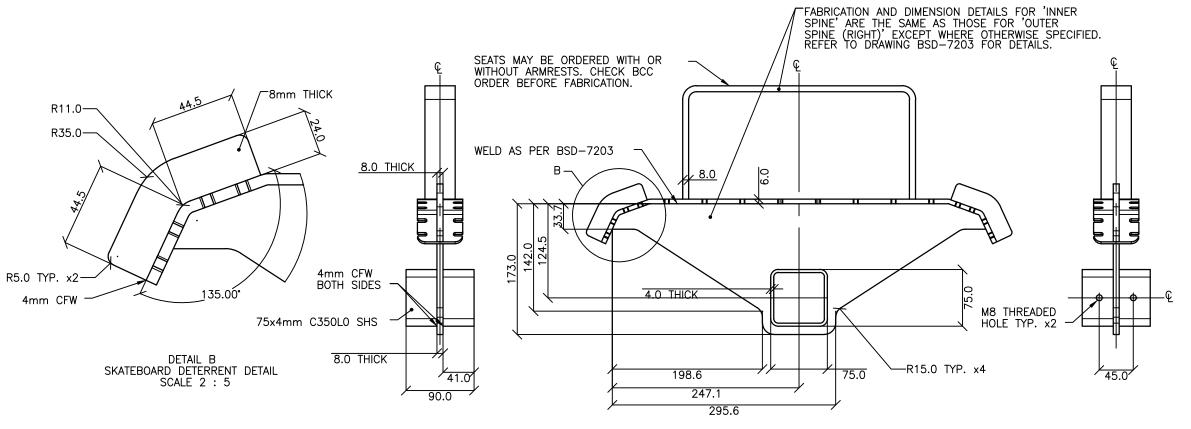


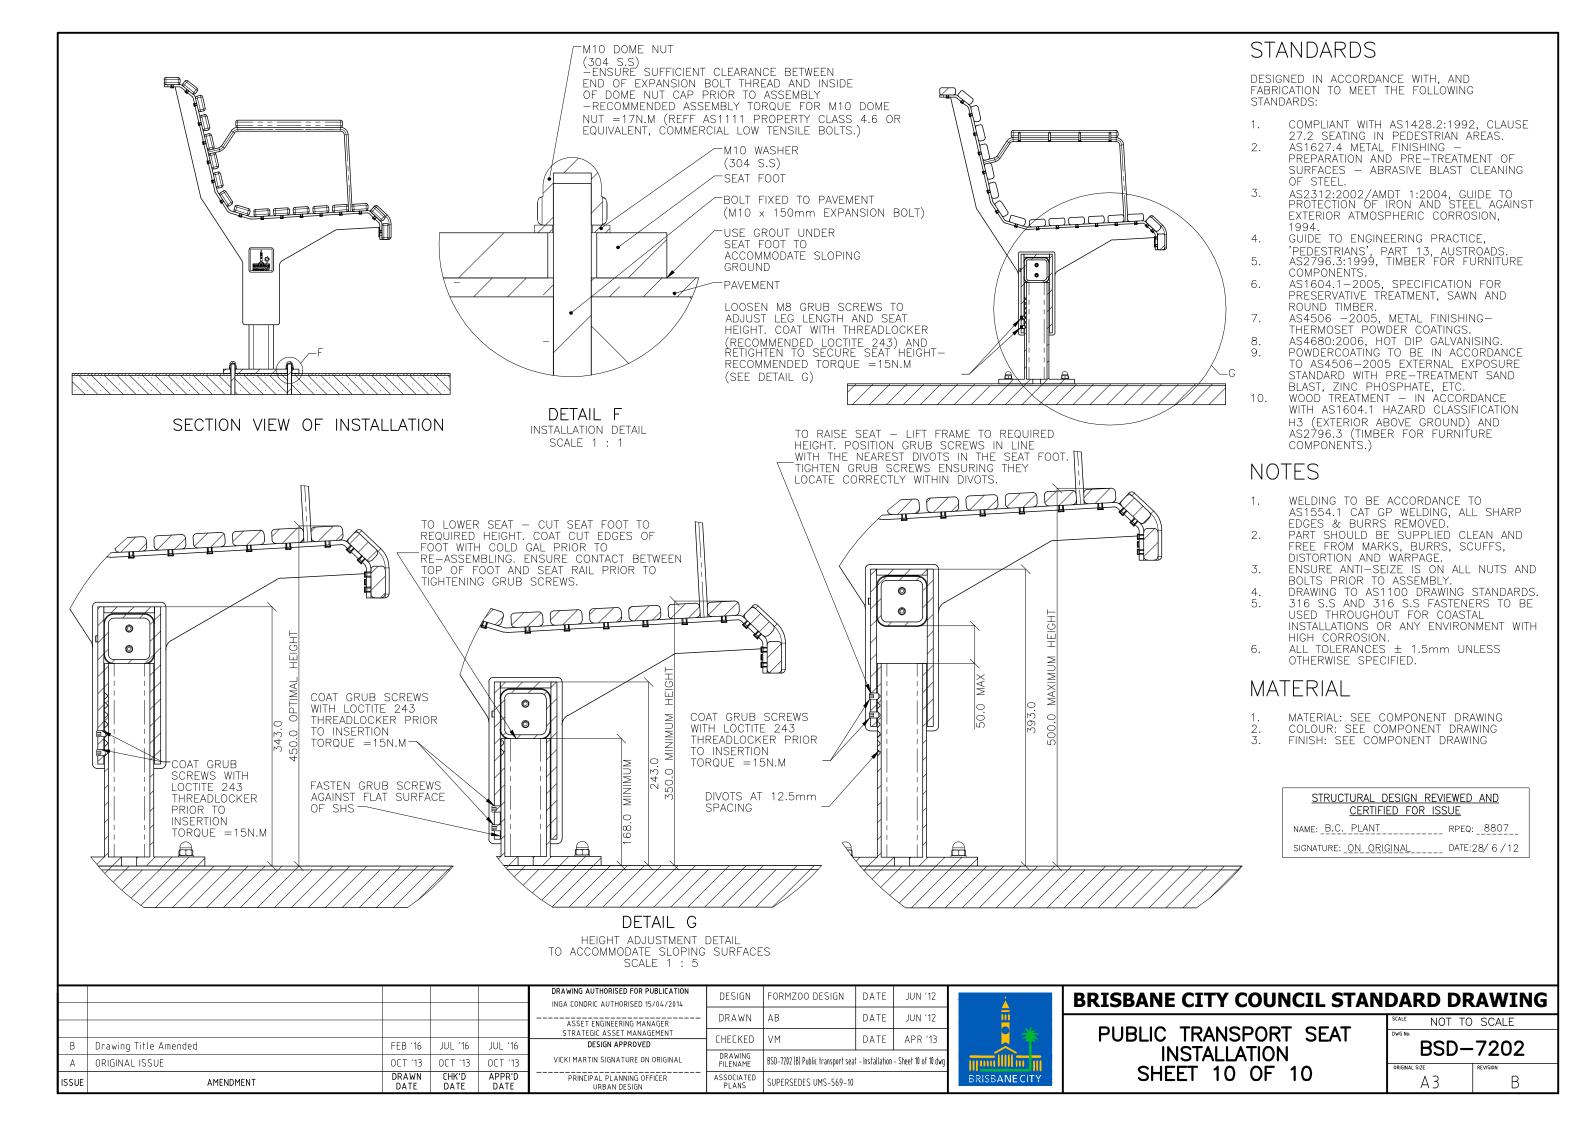

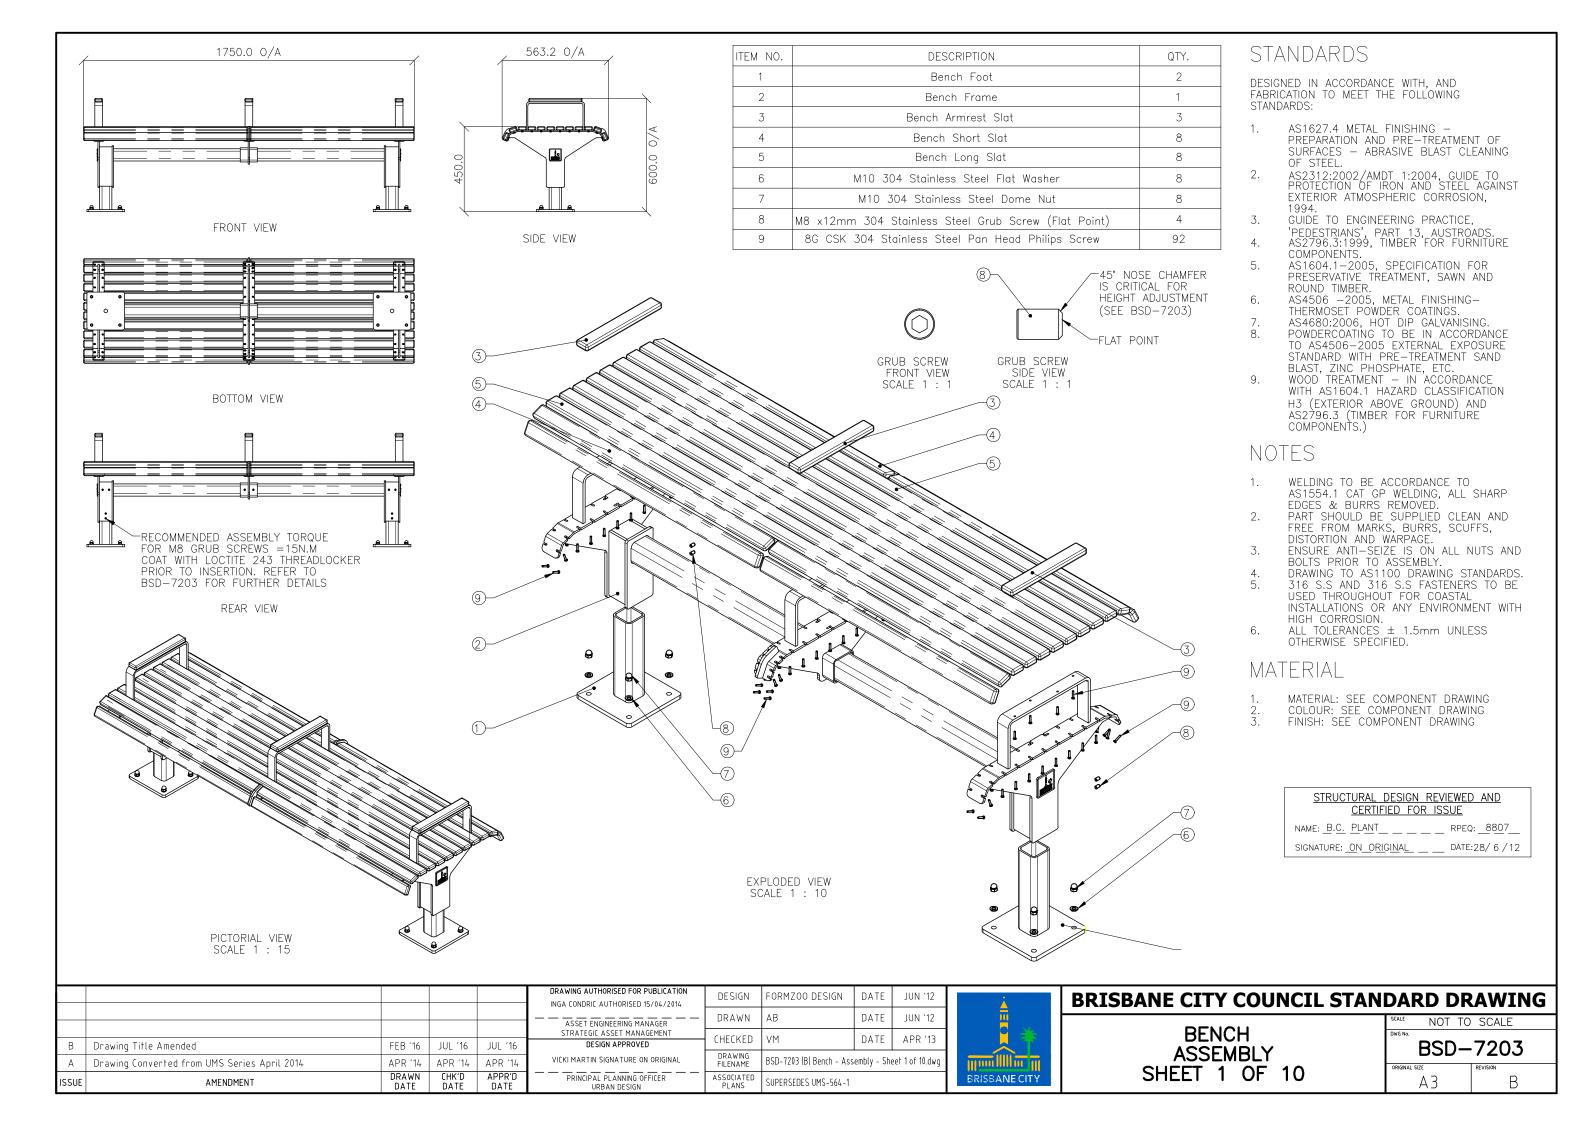

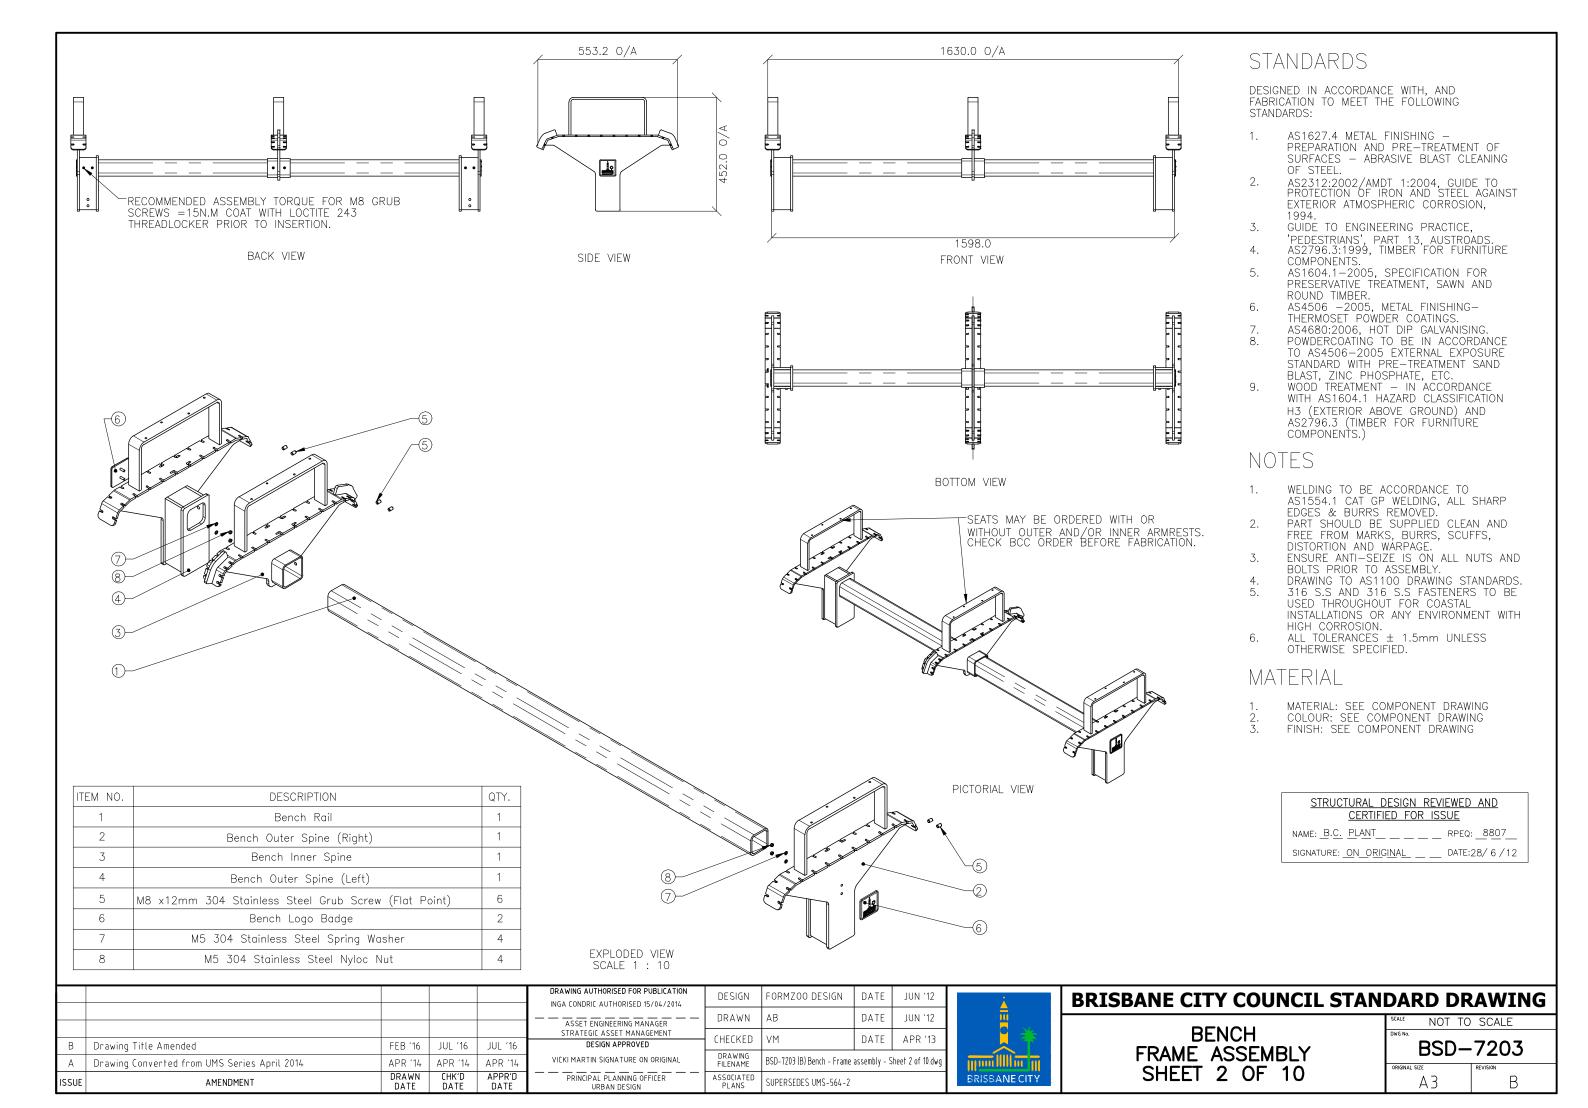

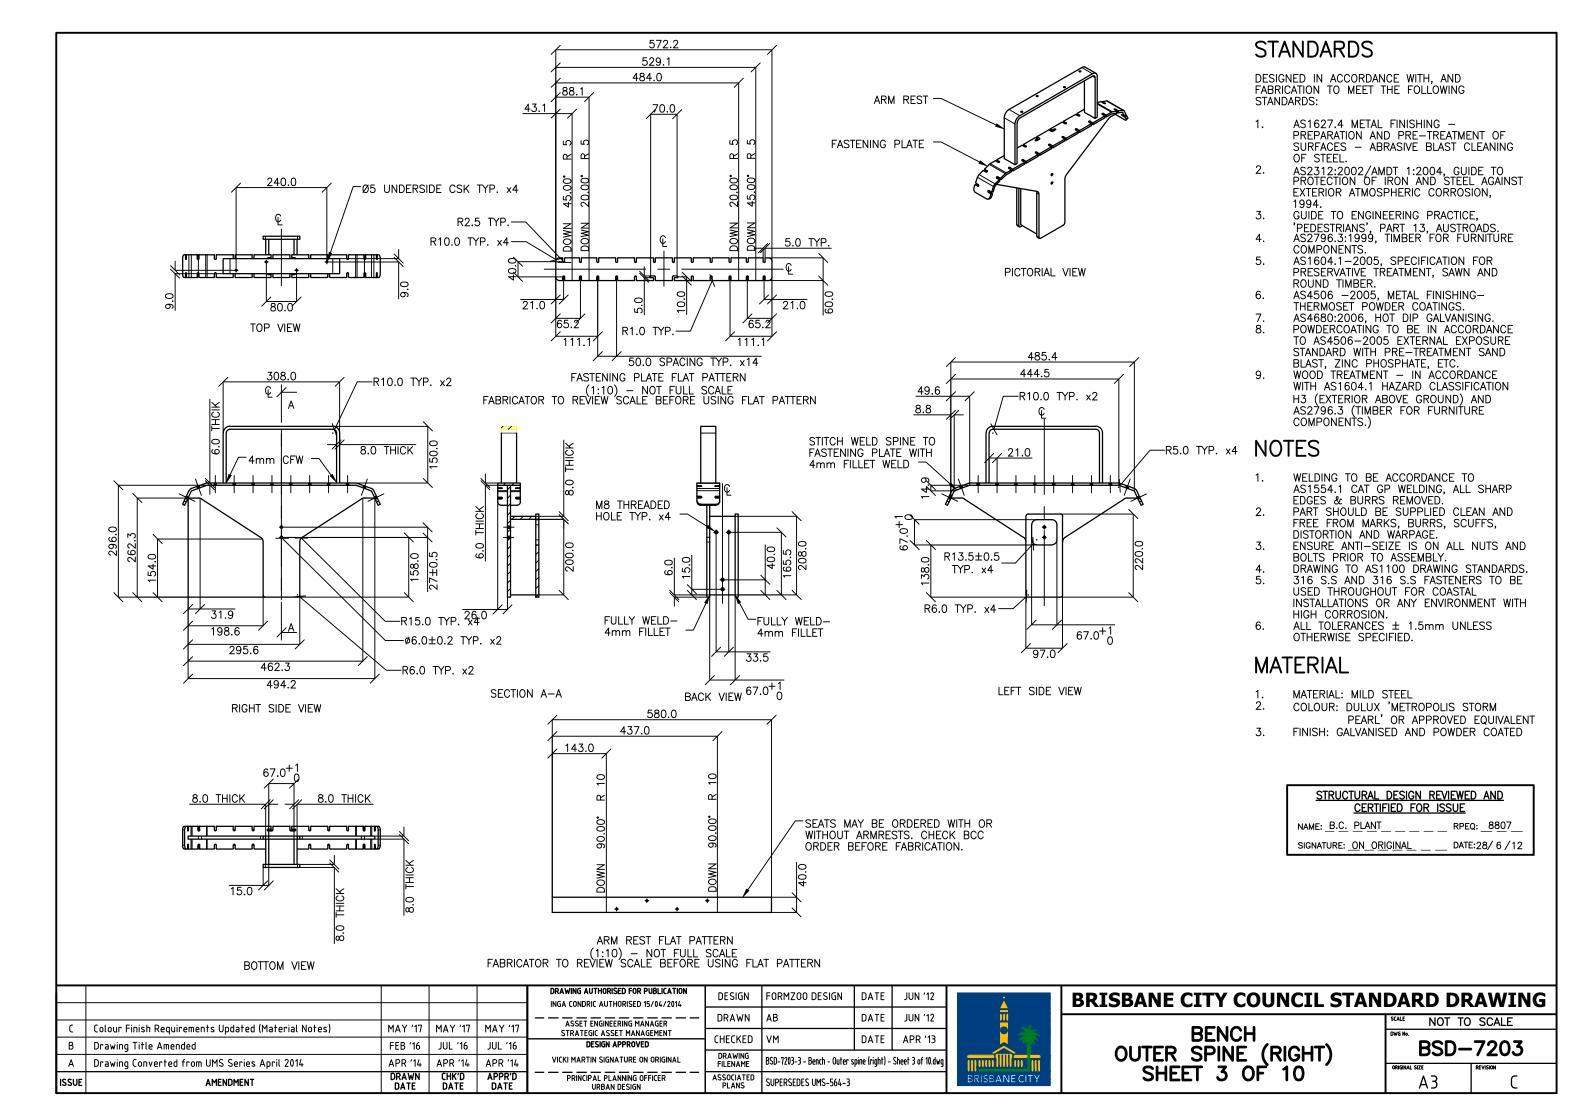

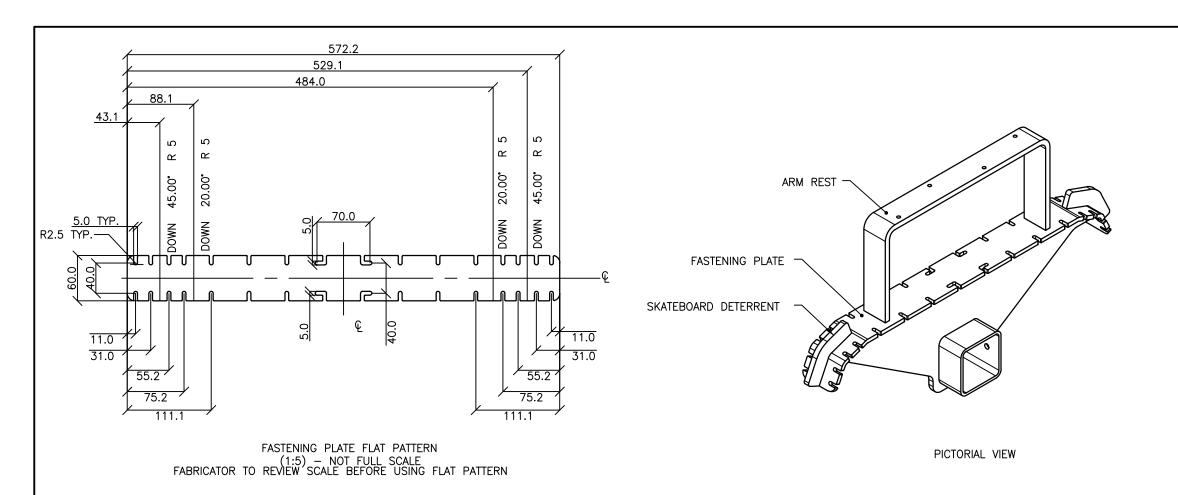

DESIGNED IN ACCORDANCE WITH, AND FABRICATION TO MEET THE FOLLOWING STANDARDS:

- AS1627.4 METAL FINISHING -PREPARATION AND PRE-TREATMENT OF SURFACES - ABRASIVE BLAST CLEANING OF STEEL.
- AS2312:2002/AMDT 1:2004, GUIDE TO PROTECTION OF IRON AND STEEL AGAINST EXTERIOR ATMOSPHERIC CORROSION.
- GUIDE TO ENGINEERING PRACTICE, 3.
- 'PEDESTRIANS', PART 13, AUSTROADS. AS2796.3:1999, TIMBER FOR FURNITURE COMPONENTS.
- AS1604.1-2005, SPECIFICATION FOR PRESERVATIVE TREATMENT, SAWN AND ROUND TIMBER.
- AS4506 -2005, METAL FINISHING-
- THERMOSET POWDER COATINGS. AS4680:2006, HOT DIP GALVANISING
- POWDERCOATING TO BE IN ACCORDANCE TO AS4506-2005 EXTERNAL EXPOSURE STANDARD WITH PRE-TREATMENT SAND BLAST, ZINC PHOSPHATE, ETC.
- WOOD TREATMENT IN ACCORDANCE WITH AS1604.1 HAZARD CLASSIFICATION H3 (EXTERIOR ABOVE GROUND) AND AS2796.3 (TIMBER FOR FURNITURE COMPONENTS.)

### **NOTES**

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- PART SHOULD BE SUPPLIED CLEAN AND FREE FROM MARKS, BURRS, SCUFFS, DISTORTION AND WARPAGE.
- ENSURE ANTI-SEIZE IS ON ALL NUTS AND BOLTS PRIOR TO ASSEMBLY.
- DRAWING TO AS1100 DRAWING STANDARDS. 316 S.S AND 316 S.S FASTENERS TO BE USED THROUGHOUT FOR COASTAL INSTALLATIONS OR ANY ENVIRONMENT WITH
- HIGH CORROSION. ALL TOLERANCES ± 1.5mm UNLESS
- OTHERWISE SPECIFIED. FABRICATION AND DIMENSION DETAILS FOR 'BENCH INNER SPINE' ARE THE SAME AS THOSE FOR 'BENCH OUTER SPINE (RIGHT)' EXCEPT WHERE OTHERWISE SPECIFIED. REFER TO DRAWING BSD-7203 FOR DETAILS.

### **MATERIAL**

- MATERIAL: MILD STEEL
- COLOUR: DULUX 'METROPOLIS STORM PEARL' OR APPROVED EQUIVALENT
- FINISH: GALVANISED AND POWDER COATED

STRUCTURAL DESIGN REV	/IEWED AND
CERTIFIED FOR IS	SUE
NAME: B.C. PLANT	_ RPEQ: <u>_880</u> 7
SIGNATURE: <u>ON ORIGIN</u> AL	DATE:28/6/12

SIDE VIEW


					DRAWING AUTHORISED FOR PUBLICATION INGA CONDRIC AUTHORISED 15/04/2014	DESIGN	FORMZOO DESIGN	DATE	JUN '12
	Colone Fisish Description and Hadalad Makesial Notes	MAN (47	MAY (47	MAN 147	ASSET ENGINEEDING MANAGED	DRAWN	AB	DATE	JUN '12
В	Colour Finish Requirements Updated (Material Notes)  Drawing Title Amended	FEB '16	MAY '17 JUL '16	MAY '17 JUL '16	STRATEGIC ASSET MANAGEMENT  DESIGN APPROVED	CHECKED	VM	DATE	APR '13
A	Drawing Converted from UMS Series April 2014	APR '14			VICKI MARTIN SIGNATURE ON ORIGINAL	DRAWING FILENAME	BSD-7203 (B) Bench – Inne	r spine – Sh	eet 4 of 10.dwg
ISSUE	AMENDMENT	DRAWN DATE	CHK'D DATE	APPR'D DATE	PRINCIPAL PLANNING OFFICER URBAN DESIGN	ASSOCIATED PLANS	SUPERSEDES UMS-564-4		



### **BRISBANE CITY COUNCIL STANDARD DRAWING**

**BENCH** INNER SPINE SHEET 4 OF 10

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DESIGNED IN ACCORDANCE WITH, AND FABRICATION TO MEET THE FOLLOWING STANDARDS:

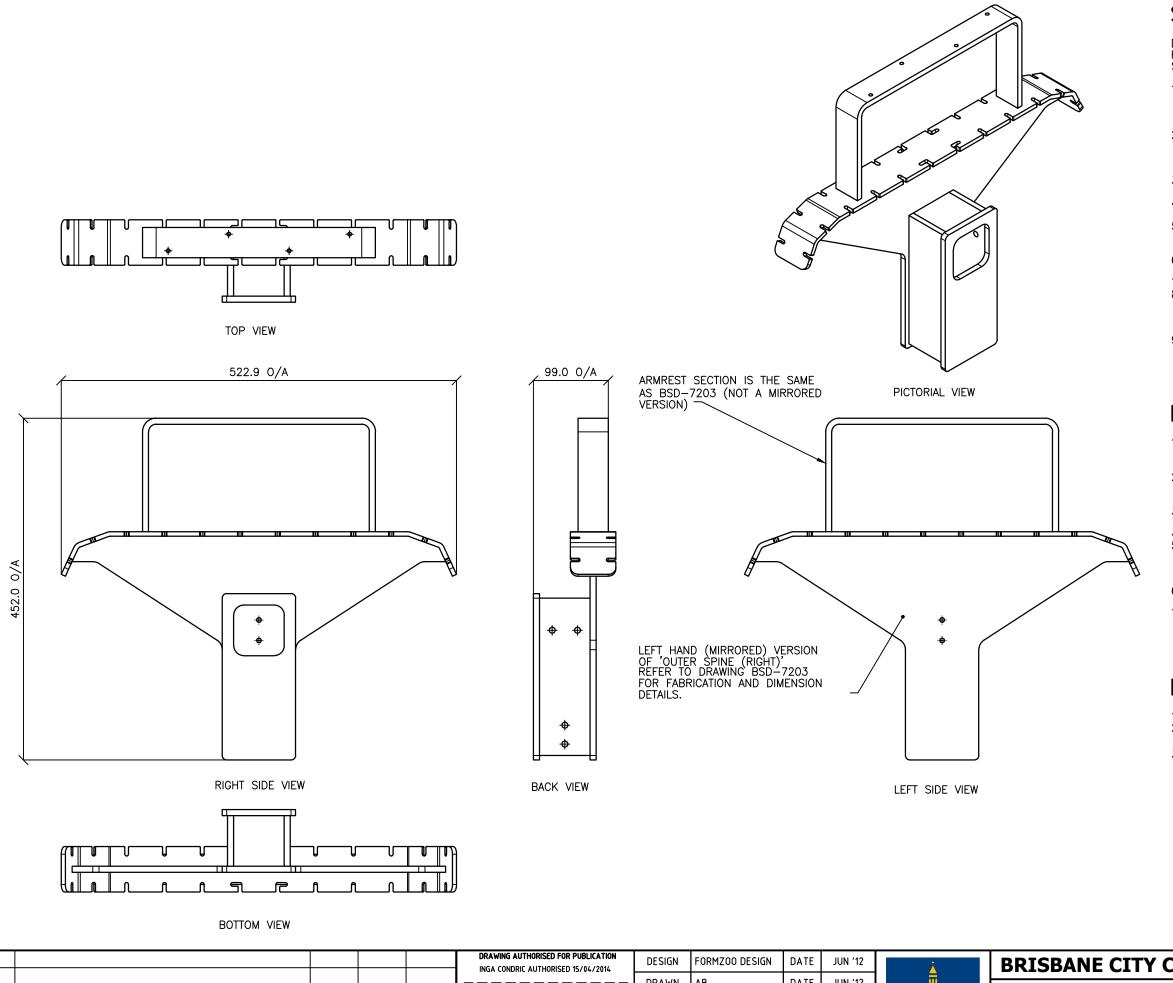- AS1627.4 METAL FINISHING -PREPARATION AND PRE-TREATMENT OF SURFACES - ABRASIVE BLAST CLEANING OF STEEL.
- AS2312:2002/AMDT 1:2004, GUIDE TO PROTECTION OF IRON AND STEEL AGAINST EXTERIOR ATMOSPHERIC CORROSION,
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- AS1604.1–2005, SPECIFICATION FOR PRESERVATIVE TREATMENT, SAWN AND ROUND TIMBER.
- AS4506 -2005, METAL FINISHING-THERMOSET POWDER COATINGS. AS4680:2006, HOT DIP GALVANISING. POWDERCOATING TO BE IN ACCORDANCE
- TO AS4506-2005 EXTERNAL EXPOSURE STANDARD WITH PRE-TREATMENT SAND BLAST, ZINC PHOSPHATE, ETC.
- WOOD TREATMENT IN ACCORDANCE WITH AS1604.1 HAZARD CLASSIFICATION H3 (EXTERIOR ABOVE GROUND) AND AS2796.3 (TIMBER FOR FURNITURE COMPONENTS.)

### **NOTES**

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- ENSURE ANTI-SEIZE IS ON ALL NUTS AND BOLTS PRIOR TO ASSEMBLY.
- DRAWING TO AS1100 DRAWING STANDARDS. 316 S.S AND 316 S.S FASTENERS TO BE USED THROUGHOUT FOR COASTAL INSTALLATIONS OR ANY ENVIRONMENT WITH HIGH CORROSION.
- ALL TOLERANCES ± 1.5mm UNLESS
- OTHERWISE SPECIFIED.

  THIS IS A LEFT HAND (MIRRORED)

  VERSION OF PART 'BENCH OUTER SPINE
  (RIGHT)' REFER TO DRAWING
  BSD—7203 FOR FABRICATION AND DIMENSION
  DETAILS.

### **MATERIAL**

- MATERIAL: MILD STEEL
- COLOUR: DULUX 'METROPOLIS STORM PEARL' OR APPROVED EQUIVALENT
- FINISH: GALVANISED AND POWDER COATED

## STRUCTURAL DESIGN REVIEWED AND CERTIFIED FOR ISSUE

NAME: B.C. PLANT\_ RPEQ: 8807 SIGNATURE: ON ORIGINAL DATE:28/6/12

С	Colour Finish Requirements Updated (Material Notes)	MAY '17	MAY '17	MAY '17
В	Drawing Title Amended	FEB '16	JUL '16	JUL '16
Α	Drawing Converted from UMS Series April 2014	APR '14	APR '14	APR '14
		DD A WAL	כשעים	A DDD'D

DATE

**AMENDMENT** 

ISSUE


DRAWN DATE JUN '12 ASSET ENGINEERING MANAGER STRATEGIC ASSET MANAGEMENT CHECKED DATE APR '13 DESIGN APPROVED DRAWING FILENAME VICKI MARTIN SIGNATURE ON ORIGINAL BSD-7203 (B) Bench - Outer spine (left) - Sheet 5 of 10.dw PRINCIPAL PLANNING OFFICER URBAN DESIGN ASSOCIATED PLANS SUPERSEDES UMS-564-5





### **BRISBANE CITY COUNCIL STANDARD DRAWING**

BENCH OUTER SPINE (LEFT) SHEET 5 OF 10

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DESIGNED IN ACCORDANCE WITH, AND FABRICATION TO MEET THE FOLLOWING STANDARDS:

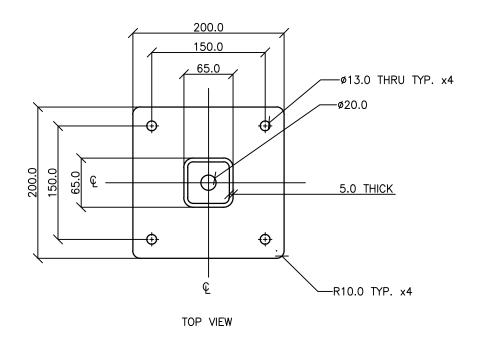- AS1627.4 METAL FINISHING -PREPARATION AND PRE-TREATMENT OF SURFACES - ABRASIVE BLAST CLEANING OF STEEL.
- AS2312:2002/AMDT 1:2004, GUIDE TO PROTECTION OF IRON AND STEEL AGAINST EXTERIOR ATMOSPHERIC CORROSION,
- GUIDE TO ENGINEERING PRACTICE, 3.
- 'PEDESTRIANS', PART 13, AUSTROADS. AS2796.3:1999, TIMBER FOR FURNITURE COMPONENTS.
- AS1604.1–2005, SPECIFICATION FOR PRESERVATIVE TREATMENT, SAWN AND ROUND TIMBER.
- AS4506 -2005, METAL FINISHING-THERMOSET POWDER COATINGS. AS4680:2006, HOT DIP GALVANISING. POWDERCOATING TO BE IN ACCORDANCE
- TO AS4506-2005 EXTERNAL EXPOSURE STANDARD WITH PRE-TREATMENT SAND BLAST, ZINC PHOSPHATE, ETC.
- WOOD TREATMENT IN ACCORDANCE WITH AS1604.1 HAZARD CLASSIFICATION H3 (EXTERIOR ABOVE GROUND) AND AS2796.3 (TIMBER FOR FURNITURE COMPONENTS.)
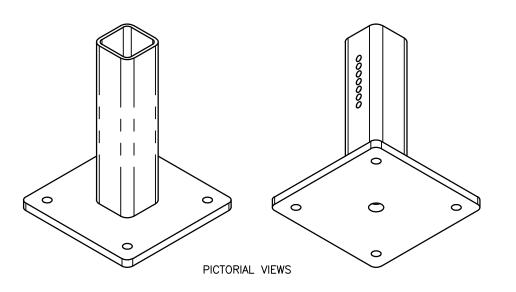
### **NOTES**

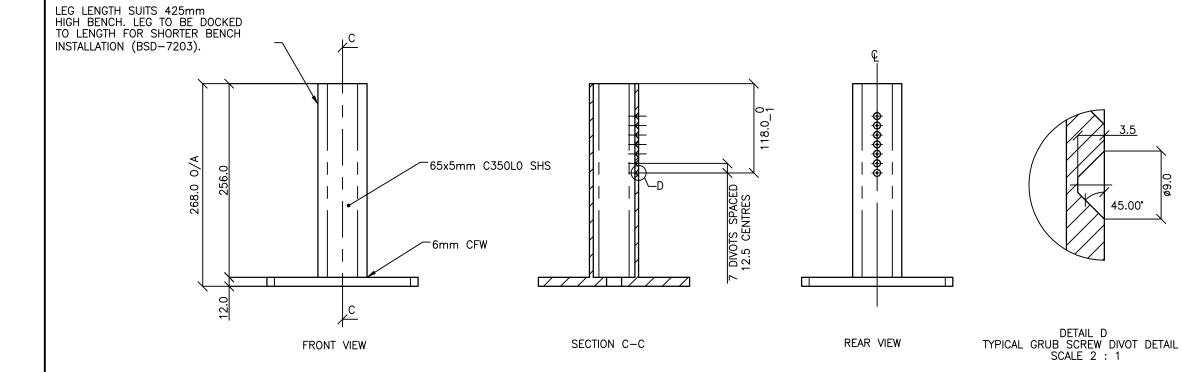- WELDING TO BE ACCORDANCE TO AS1554.1 CAT GP WELDING, ALL SHARP EDGES & BURRS REMOVED.
- PART SHOULD BE SUPPLIED CLEAN AND FREE FROM MARKS, BURRS, SCUFFS, DISTORTION AND WARPAGE
- ENSURE ANTI—SEIZE IS ON ALL NUTS AND BOLTS PRIOR TO ASSEMBLY.
- DRAWING TO AS1100 DRAWING STANDARDS. 316 S.S AND 316 S.S FASTENERS TO BE USED THROUGHOUT FOR COASTAL INSTALLATIONS OR ANY ENVIRONMENT WITH HIGH CORROSION.
- ALL TOLERANCES ± 1.5mm UNLESS
- OTHERWISE SPECIFIED.

  BENCH FOOT IS THE SAME PART AS SEAT FOOT (REFER TO DRAWING BSD-7201 AND BSD-7202)

### **MATERIAL**

- MATERIAL: MILD STEEL
- COLOUR: DULUX 'METROPOLIS STORM PEARL' OR APPROVED EQUIVALENT
- FINISH: GALVANISED AND POWDER COATED

# STRUCTURAL DESIGN REVIEWED AND CERTIFIED FOR ISSUE

NAME: B.C. PLANT \_\_ \_ \_ RPEQ: \_8807\_ SIGNATURE: ON ORIGINAL \_\_\_\_ DATE:28/6/12


					DRAWING AUTHORISED FOR PUBLICATION INGA CONDRIC AUTHORISED 15/04/2014	DESIGN	FORMZOO DESIGN	DATE	JUN '12
_	Colour Finish Dequipment Hadated (Material Notes)	MAY 117	MAY '17	MAY '17	ASSET ENGINEERING MANAGER	DRAWN	АВ	DATE	JUN '12
	Colour Finish Requirement Updated (Material Notes)	MAT 17	MAT 17	MAT 17	STRATEGIC ASSET MANAGEMENT	CHECKED	VM	DATE	APR '13
В	Drawing Title Amended	FEB '16	JUL '16	JUL '16	DESIGN APPROVED		VITI	DAIL	AFK IS
Α	Drawing Converted from UMS Series April 2014	APR '14	APR '14		VICKI MARTIN SIGNATURE ON ORIGINAL	DRAWING FILENAME	BSD-7203 (B) Bench – Foo	t - Sheet 6	of 10.dwg
ISSUE	AMENDMENT	DRAWN DATE	CHK'D DATE	APPR'D DATE	PRINCIPAL PLANNING OFFICER URBAN DESIGN	ASSOCIATED PLANS	SUPERSEDES UMS-564-6		



### **BRISBANE CITY COUNCIL STANDARD DRAWING**

**BENCH FOOT** SHEET 6 OF 10

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DESIGNED IN ACCORDANCE WITH, AND FABRICATION TO MEET THE FOLLOWING STANDARDS:

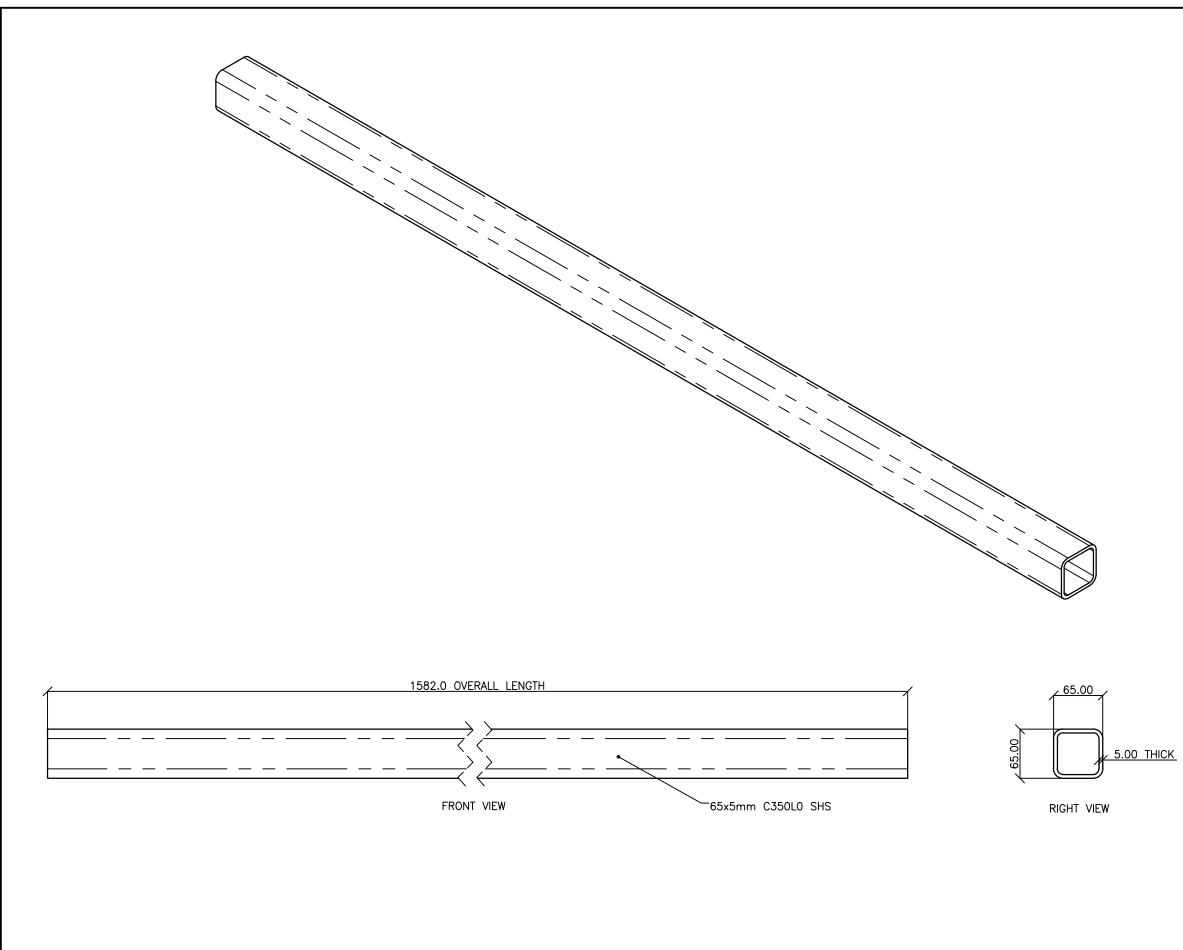- AS1627.4 METAL FINISHING -PREPARATION AND PRE-TREATMENT OF SURFACES - ABRASIVE BLAST CLEANING OF STEEL.
- AS2312:2002/AMDT 1:2004, GUIDE TO PROTECTION OF IRON AND STEEL AGAINST EXTERIOR ATMOSPHERIC CORROSION,
- GUIDE TO ENGINEERING PRACTICE,
  'PEDESTRIANS', PART 13, AUSTROADS.
  AS2796.3:1999, TIMBER FOR FURNITURE
- COMPONENTS.
  AS1604.1–2005, SPECIFICATION FOR PRESERVATIVE TREATMENT, SAWN AND ROUND TIMBER.

- AS4506 –2005, METAL FINISHING— THERMOSET POWDER COATINGS. AS4680:2006, HOT DIP GALVANISING. POWDERCOATING TO BE IN ACCORDANCE TO AS4506–2005 EXTERNAL EXPOSURE STANDARD WITH PRE-TREATMENT SAND
- BLAST, ZINC PHOSPHATE, ETC. WOOD TREATMENT IN ACCORDANCE WITH AS1604.1 HAZARD CLASSIFICATION H3 (EXTERIOR ABOVE GROUND) AND AS2796.3 (TIMBER FOR FURNITURE COMPONENTS.)

### **NOTES**

- WELDING TO BE ACCORDANCE TO
  AS1554.1 CAT GP WELDING, ALL SHARP
  EDGES & BURRS REMOVED.
  PART SHOULD BE SUPPLIED CLEAN AND
- FREE FROM MARKS, BURRS, SCUFFS, DISTORTION AND WARPAGE.

- ENSURE ANTI-SEIZE IS ON ALL NUTS AND BOLTS PRIOR TO ASSEMBLY.
  DRAWING TO AS1100 DRAWING STANDARDS.
  316 S.S AND 316 S.S FASTENERS TO BE USED THROUGHOUT FOR COASTAL INSTALLATIONS OR ANY ENVIRONMENT WITH HIGH CORROSION.
- ALL TOLERANCES ± 1.5mm UNLESS OTHERWISE SPECIFIED.
- BENCH RAIL IS THE SAME PART AS SEAT RAIL (REFER TO DRAWING BSD-7201 AND BSD-7202)

### **MATERIAL**

- MATERIAL: C350L0 SHS
  - COLOUR: DULUX 'METROPOLIS STORM PEARL' OR APPROVED EQUIVALENT
- FINISH: GALVANISED AND POWDER COATED

### STRUCTURAL DESIGN REVIEWED AND CERTIFIED FOR ISSUE

NAME: B.C. PLANT \_\_ \_ \_ RPEQ: \_8807\_ SIGNATURE: ON ORIGINAL DATE:28/6/12


ISSUE	AMENDMENT	DRAWN DATE	CHK'D DATE	APPR'D DATE	PRINCIPAL PLANNING OFFICER URBAN DESIGN	ASSOCIATED PLANS	SUPERSEDES UMS-564-7		
Α	Drawing Converted from UMS Series April 2014	APR '14	APR '14	APR '14	VICKI MARTIN SIGNATURE ON ORIGINAL	DRAWING FILENAME	BSD-7203 (B) Bench - Rail	- Sheet 7	of 10.dwg
В	Drawing Title Amended	FEB '16	JUL '16	JUL '16	DESIGN APPROVED	CHECKED	VM	DATE	APR '13
С	Colour Finish Requirements Updated (Material Notes)	MAY '17	MAY '17	MAY '17	ASSET ENGINEERING MANAGER STRATEGIC ASSET MANAGEMENT				
						DRAWN	АВ	DATE	JUN '12
					DRAWING AUTHORISED FOR PUBLICATION INGA CONDRIC AUTHORISED 15/04/2014	DESIGN	FORMZOO DESIGN	DATE	JUN '12




### **BRISBANE CITY COUNCIL STANDARD DRAWING**

BENCH **RAIL** SHEET 7 OF 10


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# BENCH LONG SLAT

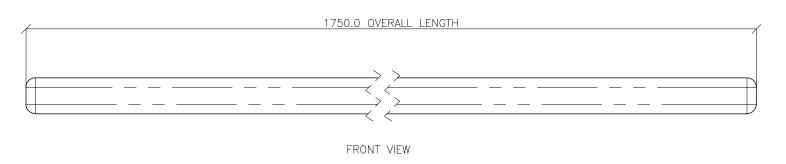


### BENCH SHORT SLAT

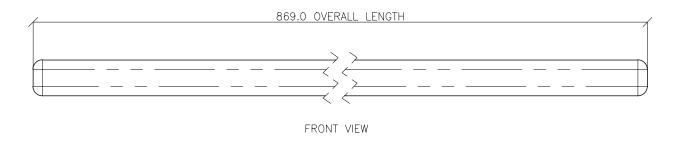


FRONT VIEW

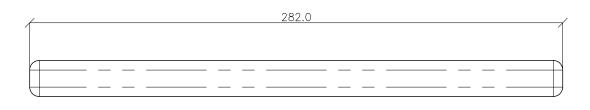
BENCH ARM REST SLAT

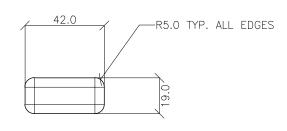

SIDE VIEW

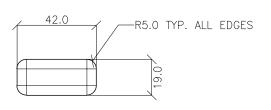

SIDE VIEW

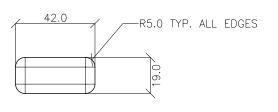

SIDE VIEW

### STANDARDS

DESIGNED IN ACCORDANCE WITH, AND FABRICATION TO MEET THE FOLLOWING STANDARDS:

- AS1627.4 METAL FINISHING -PREPARATION AND PRE-TREATMENT OF SURFACES - ABRASIVE BLAST CLEANING OF STEEL.
- AS2312:2002/AMDT 1:2004, GUIDE TO PROTECTION OF IRON AND STEEL AGAINST EXTERIOR ATMOSPHERIC CORROSION,
- GUIDE TO ENGINEERING PRACTICE,
- 'PEDESTRIANS', PART 13, AUSTROADS. AS2796.3:1999, TIMBER FOR FURNITURE COMPONENTS.
- AS1604.1-2005, SPECIFICATION FOR PRESERVATIVE TREATMENT, SAWN AND ROUND TIMBER.
- AS4506 -2005, METAL FINISHING-THERMOSET POWDER COATINGS. AS4680:2006, HOT DIP GALVANISING. POWDERCOATING TO BE IN ACCORDANCE
- TO AS4506-2005 EXTERNAL EXPOSURE STANDARD WITH PRE-TREATMENT SAND BLAST, ZINC PHOSPHATE, ETC. WOOD TREATMENT - IN ACCORDANCE
- WITH AS1604.1 HAZARD CLASSIFICATION H3 (EXTERIOR ABOVE GROUND) AND AS2796.3 (TIMBER FOR FURNITURE COMPONENTS.)

### NOTES

- WELDING TO BE ACCORDANCE TO AS1554.1 CAT GP WELDING, ALL SHARP EDGES & BURRS REMOVED.
- PART SHOULD BE SUPPLIED CLEAN AND FREE FROM MARKS, BURRS, SCUFFS, DISTORTION AND WARPAGE
- ENSURE ANTI-SEIZE IS ON ALL NUTS AND BOLTS PRIOR TO ASSEMBLY.
- DRAWING TO AS1100 DRAWING STANDARDS. 316 S.S AND 316 S.S FASTENERS TO BE USED THROUGHOUT FOR COASTA INSTALLATIONS OR ANY ENVIRONMENT WITH HIGH CORROSION.
- ALL TOLERANCES ± 1.5mm UNLESS OTHERWISE SPECIFIED.
- BENCH LONG SLAT IS THE SAME PART AS SEAT LONG SLAT (REFER TO DRAWING
- BSD-7201 & BSD-7202)
  BENCH SHORT SLAT IS THE SAME PART
  AS SEAT SHORT SLAT (REFER TO DRAWING
- BSD-7201 & BSD-7202) BENCH ARM REST SLAT IS THE SAME PART AS SEAT ARM REST SLAT (REFER TO DRAWING BSD-7201 & BSD-7202)

### MATERIAL

- MATERIAL: HARDWOOD
- COLOUR: JARRAH STAIN
- FINISH: SMOOTH + WATER BASED FURNITURE OIL

### STRUCTURAL DESIGN REVIEWED AND CERTIFIED FOR ISSUE

NAME: B.C. PLANT \_\_ \_ \_ \_ RPEQ: <u>8807</u> SIGNATURE: ON ORIGINAL \_ DATE: 28/6/12

					DRAWING AUTHORISED FOR PUBLICATION INGA CONDRIC AUTHORISED 15/04/2014	DESIGN	FORMZOO DESIGN	DATE	JUN '12
					ASSET ENGINEERING MANAGER	DRAWN	АВ	DATE	JUN '12
					STRATEGIC ASSET MANAGEMENT	CHECKED	l <sub>vm</sub>	DATE	APR '13
В	Drawing Title Amended	FEB '16	JUL '16	JUL '16	DESIGN APPROVED		VIII	DAIL	כו אוא
А	Drawing Converted from UMS Series April 2014	APR '14	APR '14	APR '14	VIĆKI MARTIN SIGNATURE ON ORIGINAL	DRAWING FILENAME	BSD-7203 (B) Bench - Timbe	er slats - Sh	neet 8 of 10.dwg
ISSUE	AMENDMENT	DRAWN DATE	CHK'D DATE	APPR'D DATE	PRINCIPAL PLANNING OFFICER URBAN DESIGN	ASSOCIATED PLANS	SUPERSEDES UMS-564-8		




### **BRISBANE CITY COUNCIL STANDARD DRAWING**

**BENCH** TIMBER SLATS SHEET 8 OF 10

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# GARNET BLAST ALL FRONT AND EDGE SURFACES AFTER ETCHING LOGO ACID ETCHED TO DEPTH OF 0.1 – 0.2mm

PICTORIAL VIEW

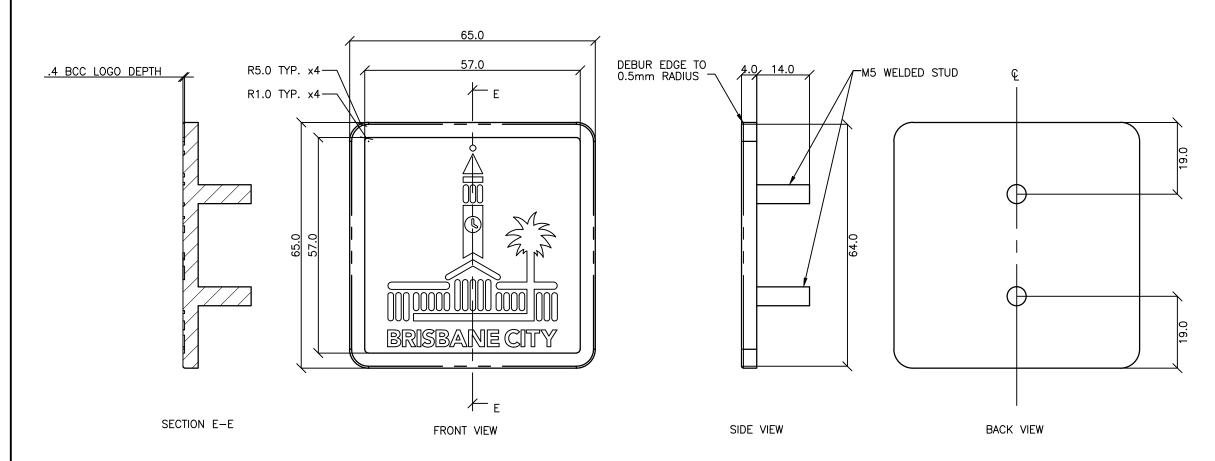

### **STANDARDS**

DESIGNED IN ACCORDANCE WITH, AND FABRICATION TO MEET THE FOLLOWING STANDARDS:

- 1. AS1627.4 METAL FINISHING —
  PREPARATION AND PRE—TREATMENT OF
  SURFACES ABRASIVE BLAST CLEANING
  OF STEEL.
- AS2312:2002/AMDT 1:2004, GUIDE TO PROTECTION OF IRON AND STEEL AGAINST EXTERIOR ATMOSPHERIC CORROSION, 1994.
- 3. GUIDE TO ENGINEERING PRACTICE,
- 'PEDESTRIANS', PART 13, AUSTROADS.
  4. AS2796.3:1999, TIMBER FOR FURNITURE COMPONENTS.
- AS1604.1—2005, SPECIFICATION FOR PRESERVATIVE TREATMENT, SAWN AND ROUND TIMBER.
- 6. AS4506 -2005, METAL FINISHING-THERMOSET POWDER COATINGS.
- 7. AS4680:2006, HOT DIP GALVANISING.
- B. POWDERCOATING TO BE IN ACCORDANCE TO AS4506-2005 EXTERNAL EXPOSURE STANDARD WITH PRE-TREATMENT SAND BLAST, ZINC PHOSPHATE, ETC.
- 9. WOOD TREATMENT IN ACCORDANCE WITH AS1604.1 HAZARD CLASSIFICATION H3 (EXTERIOR ABOVE GROUND) AND AS2796.3 (TIMBER FOR FURNITURE COMPONENTS.)

### **NOTES**

- . WELDING TO BE ACCORDANCE TO AS1554.1 CAT GP WELDING, ALL SHARP EDGES & BURRS REMOVED.
- 2. PART SHOULD BE SUPPLIED CLEAN AND FREE FROM MARKS, BURRS, SCUFFS, DISTORTION AND WARPAGE.
- ENSURE ANTI—SEIZE IS ON ALL NUTS AND BOLTS PRIOR TO ASSEMBLY.
- DRAWING TO AS1100 DRAWING STANDARDS.

  316 S.S AND 316 S.S FASTENERS TO BE USED THROUGHOUT FOR COASTAL INSTALLATIONS OR ANY ENVIRONMENT WITH HIGH CORROSION.
- 6. ALL TOLERANCES ± 1.5mm UNLESS OTHERWISE SPECIFIED.
- BENCH LOGO BADGE IS THE SAME PART AS SEAT LOGO BADGE (REFER TO DRAWING BSD-7201 & BSD-7202)

### **MATERIAL**

- 1. MATERIAL: 316 STAINLESS STEEL
- . COLOUR: NATURAL
- FINISH: GARNET BLASTED

STRUCTURAL DESIGN REVIEWED AND CERTIFIED FOR ISSUE
NAME: B.C. PLANT RPEQ: 8807
SIGNATURE: ON ORIGINAL DATE: 28/ 6/ 12


ISSUE	AMENDMENT	DRAWN DATE	CHK'D DATE	APPR'D DATE	PRINCIPAL PLANNING OFFICER URBAN DESIGN	ASSOCIATED PLANS	SUPERSEDES UMS-564-9		
Α	Drawing Converted from UMS Series April 2014	APR '14	APR '14	APR '14	VICKI MARTIN SIGNATURE ON ORIGINAL	DRAWING FILENAME	BSD-7203 (B) Bench - Logo	badge – Sh	eet 9 of 10.dwg
В	Drawing Title Amended	FEB '16	JUL '16	JUL '16	DESIGN APPROVED	CHECKED	VM	DATE	APR '13
С	Logo Badge Acid Etch Badge Depth Amended	MAY '17	MAY '17	MAY '17	ASSET ENGINEERING MANAGER STRATEGIC ASSET MANAGEMENT				
						DRAWN	АВ	DATE	JUN '12
					DRAWING AUTHORISED FOR PUBLICATION INGA CONDRIC AUTHORISED 15/04/2014	DESIGN	FORMZOO DESIGN	DATE	JUN '12




### **BRISBANE CITY COUNCIL STANDARD DRAWING**

BENCH LOGO BADGE SHEET 9 OF 10


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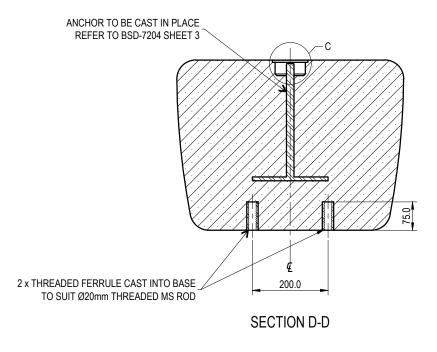


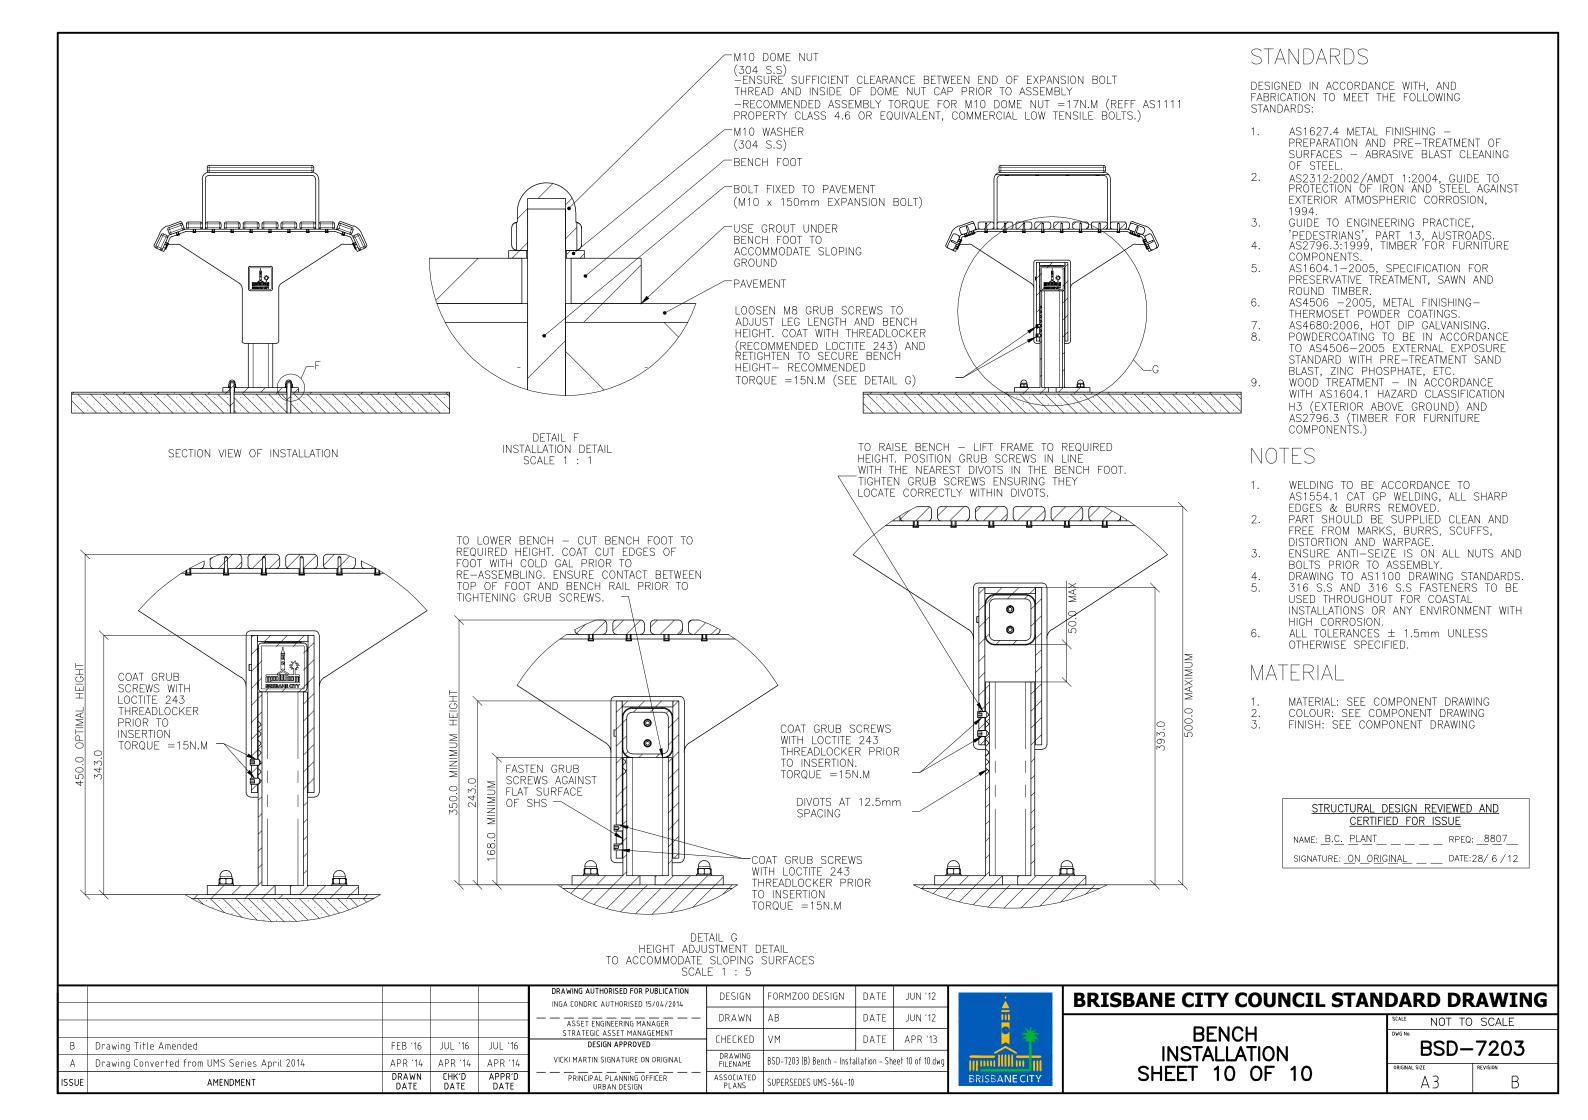**TOP VIEW** 

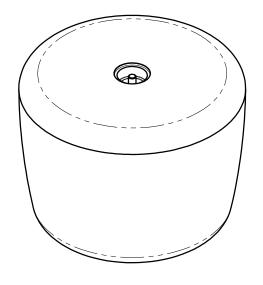

PICTORIAL VIEW



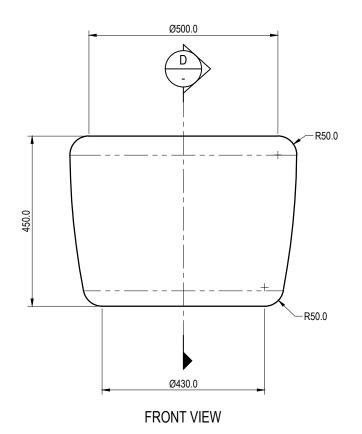

### **STANDARDS**

DESIGNED IN ACCORDANCE WITH, AND FABRICATION TO MEET THE FOLLOWING STANDARDS:


- 1. AS1627.4 METAL FINISHING PREPARATION AND PRE-TREATMENT OF SURFACES ABRASIVE BLAST CLEANING OF STEEL.
- 2. AS2312:2002/AMDT 1:2004, GUIDE TO PROTECTION OF IRON AND STEEL AGAINST EXTERIOR ATMOSPHERIC CORROSION, 1994.

### **NOTES**

- 1. WELDING TO BE ACCORDANCE TO AS1554.1 CAT GP WELDING, ALL SHARP EDGES & BURRS REMOVED.
- 2. PART SHOULD BE SUPPLIED CLEAN AND FREE FROM MARKS, BURRS, SCUFFS, DISTORTION AND WARPAGE.
- 3. ENSURE ANTI-SEIZE IS ON ALL NUTS AND BOLTS PRIOR TO ASSEMBLY.
- 4. DRAWING TO AS1100 DRAWING STANDARDS.

### MATERIAL

- 1. MATERIAL: PRECAST CONCRETE
- 2. COLOUR: VARIES TBC ON ORDER
- 3. FINISH: CLASS 1 CONCRETE FINISH

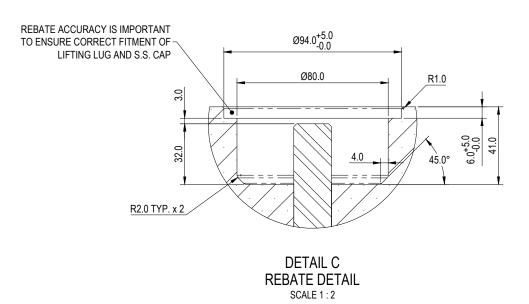

THE FITNESS FOR PURPOSE OF THIS STANDARD DRAWING FOR A SPECIFIC PROJECT SHALL BE ASSESSED AND ACCEPTED BY A SUITABLY QUALIFIED REGISTERED PROFESSIONAL ENGINEER OF QUEENSLAND (RPEQ).




BRISBANE CITY COUNCIL STANDARD DRAWING	
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URBAN STOOL SHEET 1 OF 5

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j	March	2021
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	BSD-	7204
	ORIGINAL SIZE	REVISION

# TOP VIEW PICTORIAL VIEW

FRONT VIEW

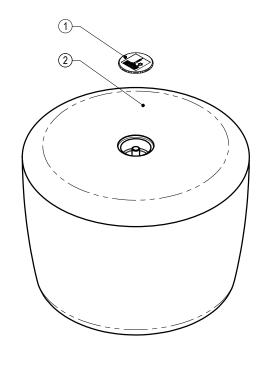

**EXPLODED VIEW** 

### STANDARDS

DESIGNED IN ACCORDANCE WITH, AND FABRICATION TO MEET THE FOLLOWING STANDARDS:


- AS1627.4 METAL FINISHING -PREPARATION AND PRE-TREATMENT OF SURFACES - ABRASIVE BLAST CLEANING OF STEEL.
- AS2312:2002/AMDT 1:2004, GUIDE TO PROTECTION OF IRON AND STEEL AGAINST EXTERIOR ATMOSPHERIC CORROSION, 1994.

### **NOTES**

- WELDING TO BE ACCORDANCE TO AS1554.1 CAT GP WELDING, ALL SHARP EDGES & BURRS REMOVED.
- 2. PART SHOULD BE SUPPLIED CLEAN AND FREE FROM MARKS, BURRS, SCUFFS, DISTORTION AND WARPAGE.
- 3. ENSURE ANTI-SEIZE IS ON ALL NUTS AND BOLTS PRIOR TO
- 4. DRAWING TO AS1100 DRAWING STANDARDS.

### **MATERIAL**


- 1. MATERIAL: SEE COMPONENT DRAWING
- 2. COLOUR: SEE COMPONENT DRAWING
- 3. FINISH: SEE COMPONENT DRAWING

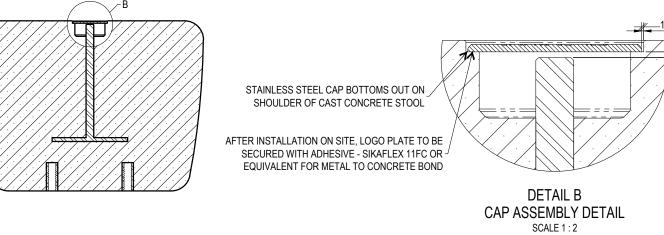


**SECTION A-A** 


ITEM NO.	DESCRIPTION	QTY.
1	Urban Stool Cap	1
2	Urban Stool	1

THE FITNESS FOR PURPOSE OF THIS STANDARD DRAWING FOR A SPECIFIC PROJECT SHALL BE ASSESSED AND ACCEPTED BY A SUITABLY QUALIFIED REGISTERED PROFESSIONAL ENGINEER OF QUEENSLAND (RPEQ).

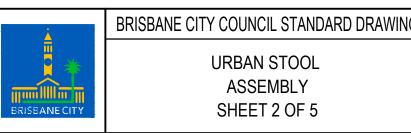


OF QUEENSLAND (RPEQ).				
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PICTORIAL VIEW

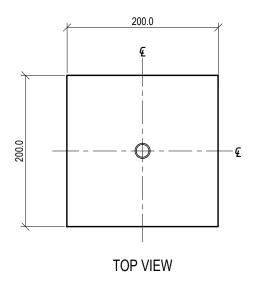

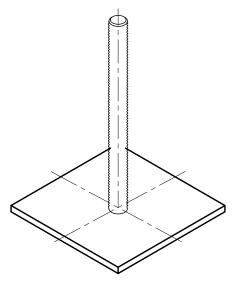DESIGNED IN ACCORDANCE WITH, AND FABRICATION TO MEET THE FOLLOWING STANDARDS:

- AS1627.4 METAL FINISHING -PREPARATION AND PRE-TREATMENT OF SURFACES - ABRASIVE BLAST CLEANING OF STEEL.
- 2. AS2312:2002/AMDT 1:2004, GUIDE TO PROTECTION OF IRON AND STEEL AGAINST EXTERIOR ATMOSPHERIC CORROSION, 1994.
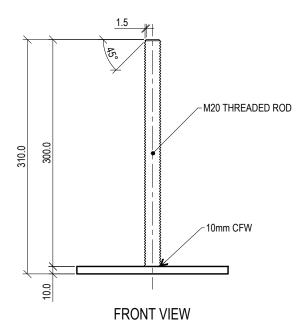
### **NOTES**

- WELDING TO BE ACCORDANCE TO AS1554.1 CAT GP WELDING, ALL SHARP EDGES & BURRS REMOVED.
- 2. PART SHOULD BE SUPPLIED CLEAN AND FREE FROM MARKS, BURRS, SCUFFS, DISTORTION AND WARPAGE.
- 3. ENSURE ANTI-SEIZE IS ON ALL NUTS AND BOLTS PRIOR TO ASSEMBLY.
- 4. DRAWING TO AS1100 DRAWING STANDARDS.

### **MATERIAL**

- 1. MATERIAL: 304 STAINLESS STEEL
- 2. COLOUR: NATURAL
- 3. FINISH: NATURAL

THE FITNESS FOR PURPOSE OF THIS STANDARD DRAWING FOR A SPECIFIC PROJECT SHALL BE ASSESSED AND ACCEPTED BY A SUITABLY QUALIFIED REGISTERED PROFESSIONAL ENGINEER OF QUEENSLAND (RPEQ).



### BRISBANE CITY COUNCIL STANDARD DRAWING

URBAN STOOL ANCHOR SHEET 3 OF 5 March 2021


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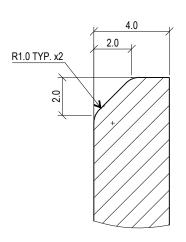
NOT TO SCALE

DRAWING NUMBER

BSD-7204
ORIGINAL SIZE REVISION


A3




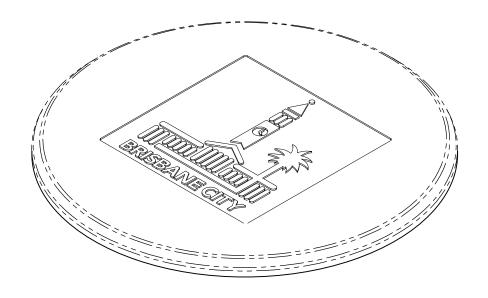

DETAIL F SCALE 5:1



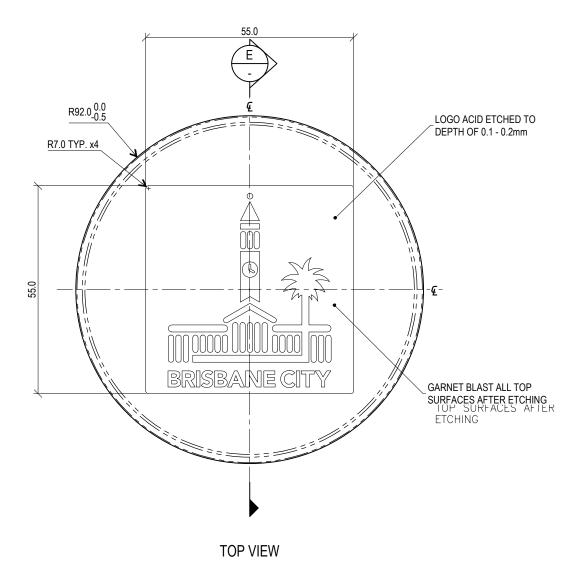

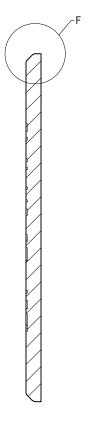

SECTION E-E

DESIGNED IN ACCORDANCE WITH, AND FABRICATION TO MEET THE FOLLOWING STANDARDS:

- AS1627.4: METAL FINISHING PREPARATION AND PRE-TREATMENT OF SURFACES - ABRASIVE BLAST CLEANING OF STEEL.
- AS2312:2002/AMDT 1:2004: GUIDE TO PROTECTION OF IRON AND STEEL AGAINST EXTERIOR ATMOSPHERIC CORROSION, 1994.

### **NOTES**

- 1. PART SHOULD BE SUPPLIED CLEAN AND FREE FROM MARKS, BURRS, SCUFFS, DISTORTION AND WARPAGE.
- 2. DRAWING TO AS1100 DRAWING STANDARDS.

### **MATERIAL**

- 1. MATERIAL: 316 STAINLESS STEEL.
- 2. COLOUR: NATURAL.
- 3. FINISH: GARNET BLASTED.

THE FITNESS FOR PURPOSE OF THIS STANDARD DRAWING FOR A SPECIFIC PROJECT SHALL BE ASSESSED AND ACCEPTED BY A SUITABLY QUALIFIED REGISTERED PROFESSIONAL ENGINEER OF QUEENSLAND (RPEQ).



BRISBANE CITY COUNCIL STANDARD DRAWING


URBAN STOOL CAP SHEET 4 OF 5 PUBLISH DATE
MArch 2021

SCALE
NOT TO SCALE
DRAWING NUMBER
BSD-7204

ORIGINAL SIZE
REVISION

# URBAN STOOL THREADED FERRULE NON-SHRINK GROUT TO ACCOMMODATE SLOPING SECTION OF FOOTPATH. 15 MAX. DEPTH. CONCRETE SLAB AS PER STANDARD BCC SPECIFICATIONS 6220 GALVANISED THREADED ROD FIXED INTO STOOL AND CHEAKSET INTO CONCRETE GROUND SLAB WITH 80 MIN. EMBEDMENT

### DETAIL F INSTALLATION DETAIL SCALE 1:1

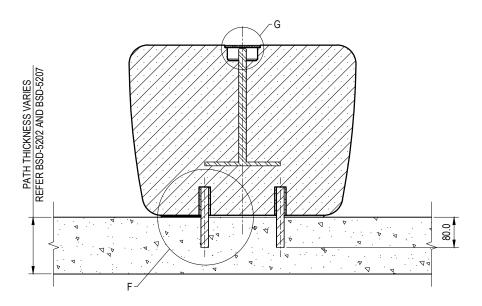

SECTION VIEW OF INSTALLATION

### STANDARDS

DESIGNED IN ACCORDANCE WITH, AND FABRICATION TO MEET THE


- AS1428.4.1:2009, TACTILE GROUND SURFACE INDICATORS FOR THE ORIENTATION OF PEOPLE WITH VISION IMPAIRMENT.
- 2. AS1627.4 METAL FINISHING -PREPARATION AND PRE-TREATMENT OF SURFACES ABRASIVE BLAST CLEANING OF STEEL.
- 3. AS2312:2002/AMDT 1:2004, GUIDE TO PROTECTION OF IRON AND STEEL AGAINST EXTERIOR ATMOSPHERIC CORROSION, 1994.
- 4. GUIDE TO ENGINEERING PRACTICE, 'PEDESTRIANS', PART 13, AUSTROADS.

### **NOTES**


- WELDING TO BE ACCORDANCE TO AS1554.1 CAT GP WELDING, ALL SHARP EDGES & BURRS REMOVED.
- PART SHOULD BE SUPPLIED CLEAN AND FREE FROM MARKS, BURRS, SCUFFS, DISTORTION AND WARPAGE.
- 3. ENSURE ANTI-SEIZE IS ON ALL NUTS AND BOLTS PRIOR TO ASSEMBLY.
- 4. DRAWING TO AS1100 DRAWING STANDARDS.

### MATERIAL

- 1. MATERIAL: SEE COMPONENT DRAWING
- 2. COLOUR: SEE COMPONENT DRAWING
- 3. FINISH: SEE COMPONENT DRAWING

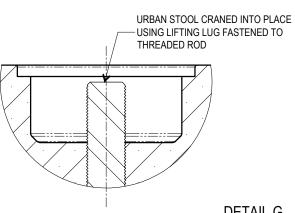



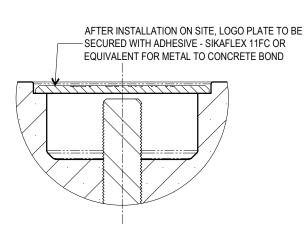

THE FITNESS FOR PURPOSE OF THIS STANDARD DRAWING FOR A SPECIFIC PROJECT SHALL BE ASSESSED AND ACCEPTED BY A SUITABLY QUALIFIED REGISTERED PROFESSIONAL ENGINEER OF QUEENSLAND (RPEQ).



### BRISBANE CITY COUNCIL STANDARD DRAWING

URBAN STOOL INSTALLATION SHEET 5 OF 5 March 2021

SCALE

NOT TO SCALE


DRAWING NUMBER

BSD-7204
ORIGINAL SIZE REVISION

A3

### NEW CONCRETE SLAB SIZING TABLE FOR STREETSCAPE AND PUBLIC FURNITURE ITEMS - MINIMUM REQUIREMENTS

FURNITURE ITEM TYPE (BSD NUMBER)	CONCRETE STRENGTH AND GRADE	SLAB EXTENT AROUND FIXING POINTS	REINFORCEMENT REQUIREMENTS	SURFACE RESTORATION WIDTH 'A' (MIN.)	SURFACE RESTORATION LENGTH 'B' (MIN.)
SINGLE BIKE RACK (BSD-5051)	N32	FOOTING: 600 x 600 x 200 (DEPTH)	SL82	600	1100
MULTI-BIKE RACK (BSD-5052) - 3 BAY	N32	FOOTING: 600 x 600 x 200 (DEPTH)	SL82	600	1500
MULTI-BIKE RACK (BSD-5052) - 4 BAY	N32	FOOTING: 600 x 600 x 200 (DEPTH)	SL82	600	1800
MULTI-BIKE RACK (BSD-5052) - 5 BAY	N32	FOOTING: 600 x 600 x 200 (DEPTH)	SL82	600	2100
STREETSCAPE FIXED BOLLARD (BSD-7095)	N32	FOOTING: 600 x 600 x 300 (DEPTH)	-	600	600
STANDARD SEAT (BSD-7201)	N32	FOOTING: 600 x 600 x 200 (DEPTH)	SL82	1000	2150
PUBLIC TRANSPORT SEAT (BSD-7202)	N32	FOOTING: 600 x 600 x 200 (DEPTH)	SL82	1050	2050
ANODISED 240L BIN UNIT DESIGN (BSD-7302)	N32	-	SL82	1110	1250
DRINKING FOUNTAIN (BSD-7331)	N32	FOOTING: 600 x 600 x 300 (DEPTH)	-	600	1020
BENCH (BSD-7203)	N32	FOOTING: 600 x 600 x 300 (DEPTH)	SL82	600	2050

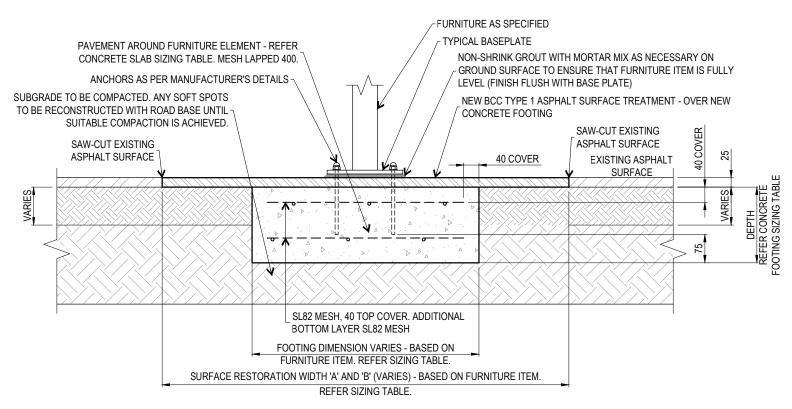

### NOTE:

TYPICAL SURFACE MOUNTING (FLANGE MOUNTING) TO NEW CONCRETE FOOTING UNDER ASPHALT SURFACE: SUITABLE FOR MOST STREETSCAPE AND PUBLIC FURNITURE ITEMS AS PER THE SIZING TABLE.


### SECTION A-A

FURNITURE ITEM FOOTING IN ASPHALT

SCALE: 1:10

### **CONCRETE WORK NOTES**

- 1. ALL WORKMANSHIP AND MATERIAL SHALL BE IN ACCORDANCE WITH AS3600.
- 2. FOOTINGS HAVE BEEN DESIGNED FOR AN ALLOWABLE BEARING PRESSURE OF 100 kPa.
- 3. IF ANCHORING TO AN EXISTING CONCRETE SLAB, ENSURE SLAB IS MINIMUM 125 THICK AND MINIMUM SIZE OF 1965 x 800.
- WHERE SLAB ADJOINS A CONCRETE PATH, A DOWELLED EXPANSION JOINT (AS PER BSD-5206) SHALL BE INSTALLED BETWEEN THE TWO INTERFACES.
- 5. DETAIL ASSUMES EXISTENCE OF EXISTING SLAB UNDER EXISTING SURFACE TREATMENT, IF NO SLAB EXISTS, A NEW SLAB IS TO BE CONSTRUCTED UNDER FURNITURE ITEM AS PER SIZING TABLE ON THIS SHEET FOR SPECIFIC FURNITURE ITEM.
- CENTRE OF FURNITURE ITEM IS TO BE BE A MINIMUM OF 200 AWAY FROM EDGE OF SLAB AND IN ANY DIRECTION.
- IF SOFT UNCONSOLIDATED GROUND IS DISCOVERED AT FOUNDING LEVEL, SEEK SUPERINTENDENT'S DIRECTION BEFORE OVER EXCAVATING OR BACKFILLING WITH CONTROLLED FILL CLASS 2 MATERIAL AND COMPACT.
- ALL IN GROUND SERVICES SHALL BE IDENTIFIED BY CONTRACTOR, IF SERVICES ARE FOUND AT LOCATION OF FOOTING, CONTACT SUPERINTENDENT.
- 6. ALL DIMENSIONS IN MILLIMETRES (U.N.O.).

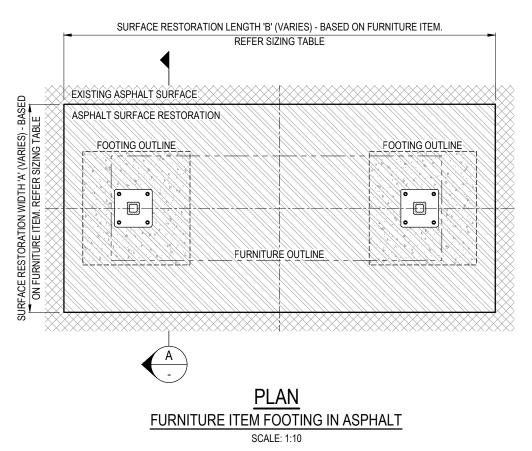

THE PURPOSE OF THIS STANDARD DRAWING IS TO PROVIDE TYPICAL DETAILS THAT SUPPORT THE DESIRED OUTCOMES OF THE BRISBANE CITY PLAN 2014 AND ASSOCIATED PLANNING SCHEME POLICIES. THE FITNESS FOR PURPOSE OF THIS STANDARD DRAWING FOR A SPECIFIC PROJECT SHOULD BE ASSESSED AND ACCEPTED BY AN APPROPRIATELY QUALIFIED DESIGNER AND/OR REGISTERED PROFESSIONAL ENGINEER OF QUEENSLAND (RPEQ).



### BRISBANE CITY COUNCIL STANDARD DRAWING

FOOTING DETAILS FOR STREETSCAPE AND PUBLIC FURNITURE ITEMS PUBLISH DATE

JUN 2023


SCALE


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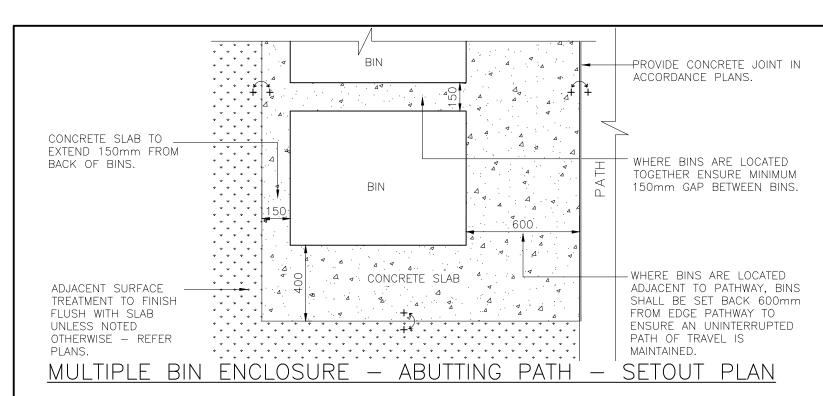
DRAWING NUMBER

BSD-7205
ORIGINAL SIZE REVISION

A3



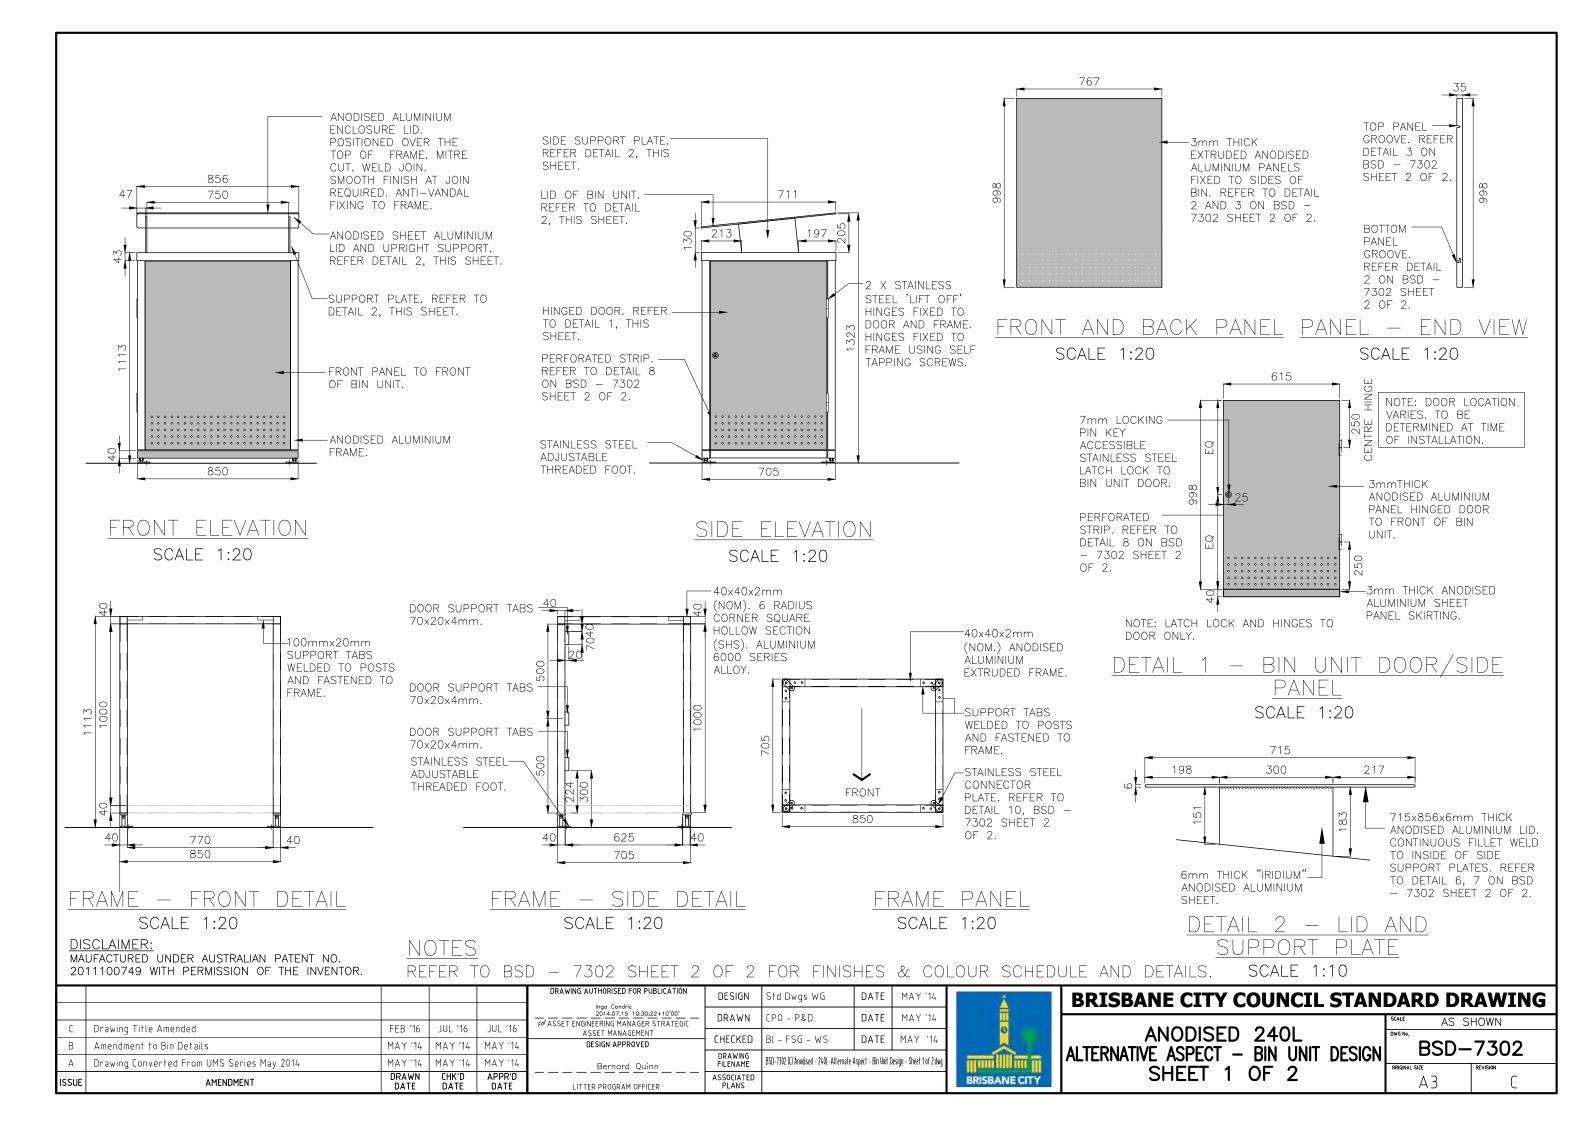

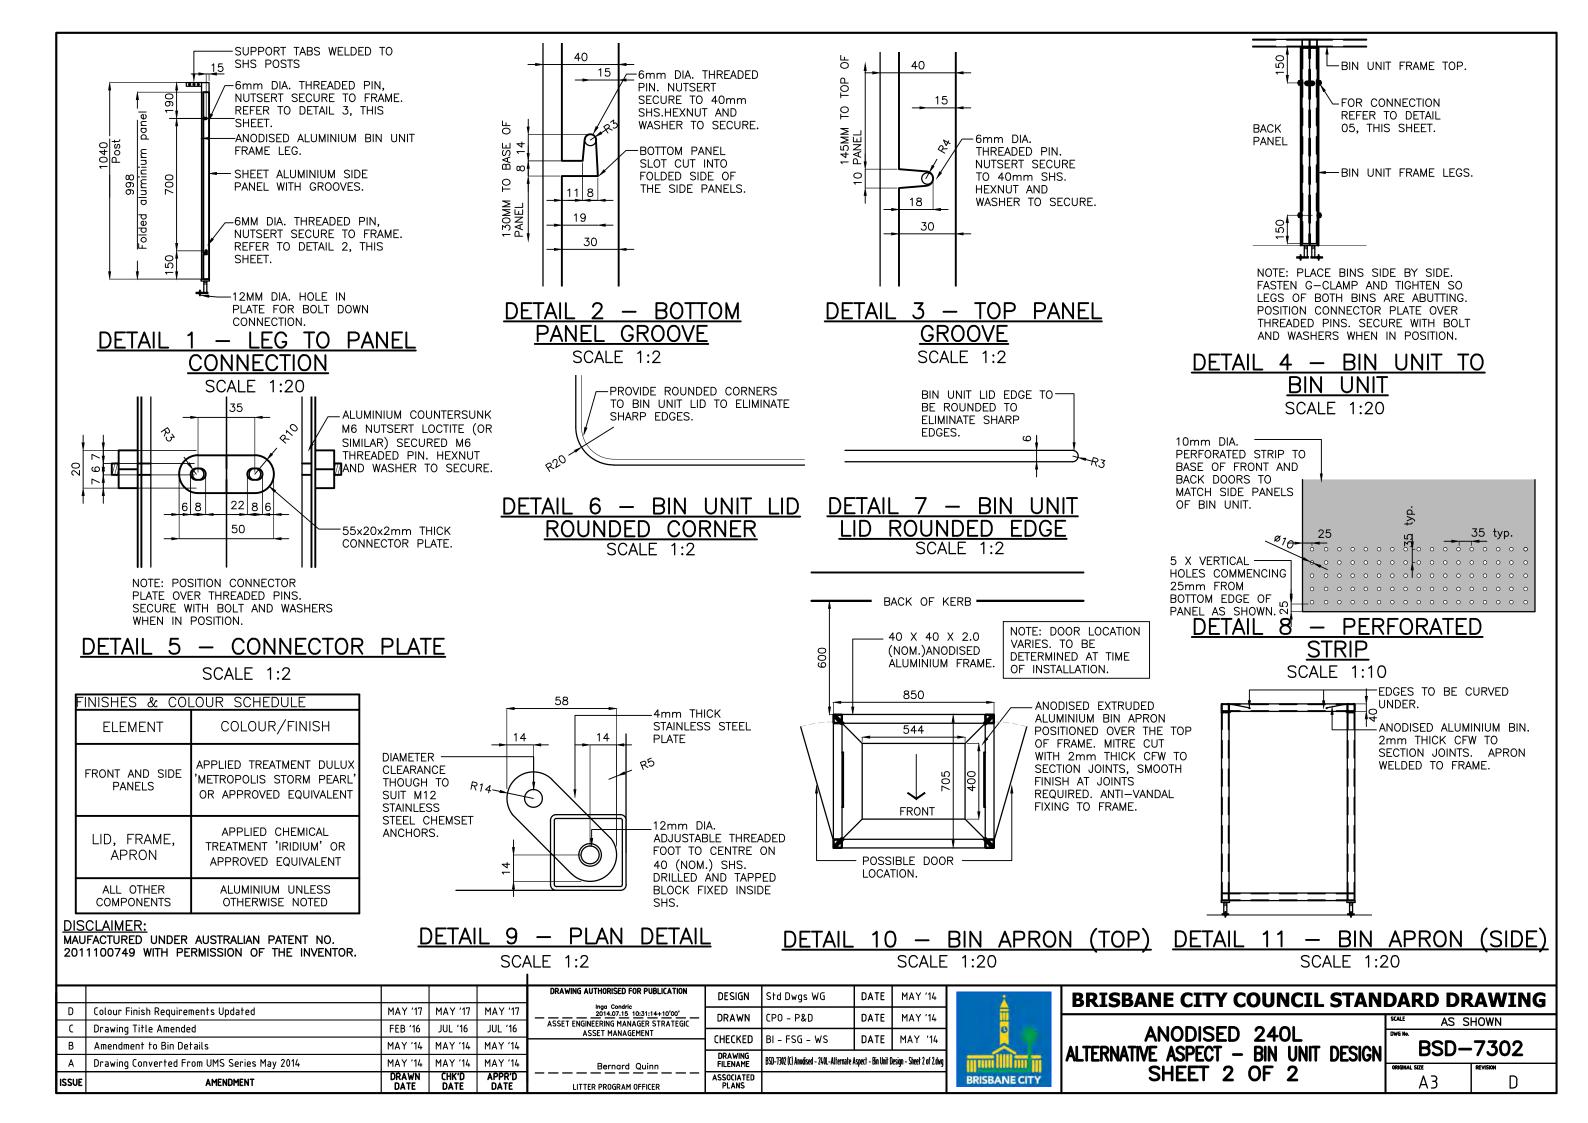

### GENERAL NOTES & SPECIFICATIONS

- ENSURE BIN ENCLOSURES ARE LOCATED IN ACCORDANCE WITH PARKS CHAPTER OF INFRASTRUCTURE DESIGN PLANNING SCHEME POLICY.
- WHERE APPLICABLE INCORPORATE BIN ENCLOSURE AS PART OF INTEGRATED PICNIC SETTING NODES (REFER BSD-10101 - SHEETS 1-2).
- AUSTRALIAN STANDARDS SHALL BE IN ACCORDANCE WITH THE CURRENT EDITIONS OF THE REFERENCED AUSTRALIAN STANDARDS EXCEPT WHERE VARIED BY SPECIFICATIONS AND/OR DRAWINGS.
- MATERIAL CHOICES ARE TO BE DETERMINED ON THE GROUNDS OF SUSTAINABILITY, LOW MAINTENANCE, VANDAL RESISTANCE, ENVIRONMENTALLY FRIENDLY COMPOSITE MATERIALS, PRODUCT AVAILABILITY AND SUITABILITY TO THE CLIMATIC CONDITIONS AND PRACTICALITY. WHERE POSSIBLE, MATERIALS ARE TO BE LOCALLY MADE OR SOURCED RATHER THAN IMPORTED FROM OVERSEAS UNLESS SPECIFIED OTHERWISE.
- COLOUR SELECTION IN ACCORDANCE WITH STANDARD BCC CORPORATE COLOUR PALETTE (& AS 2700 EQUIVALENT). IF NO COLOUR SPECIFIED, BIN ENCLOSURES TO BE INSTALLED AS MANUFACTURED.
- ENSURE BIN ENCLOSURES ARE CLEANED OF CONCRETE SLURRY OR SPRAY WHEN INSTALLED TO PREVENT STAINING OR DAMAGE TO APPLIED FINISHES.
- ENSURE MOWN HEIGHT OF GRASS (TURF) AREAS FINISHES FLUSH WITH PAVEMENT AREA.
- ENSURE GARDEN AREAS (MULCH) FINISH 25mm BELOW ADJACENT F.S.L'S OF PAVEMENT AREA. BIN MAKE, MODEL AND FINISH AS SPECIFIED ON PLANS.
- ALL DIMENSIONS IN MILLIMETRES (U.N.O.).


### /FILIINGS & METAL WORK NOTES

- ALL WORKMANSHIP AND MATERIAL SHALL BE IN ACCORDANCE WITH AS4100 & AS/NZS 1554. ALL METAL FINISHES TO BE IN ACCORDANCE WITH AS 4506.
- ALL FIXTURES/FITTINGS UNLESS SPECIFIED ARE TO BE HOT DIPPED GALVANISED UNLESS IN VICINITY OF SALTWATER/SPRAY, ENSURE ALL FASTENERS SHALL BE STAINLESS STEEL. PLASTIC SEPARATORS SHALL BE PROVIDED TO AVOID CONTACT BETWEEN DISSIMILAR MATERIALS. STAINLESS STEEL GRADE 316 TO BE USED. WHERE POSSIBLE ALL FIXINGS TO BE TAMPER/VANDAL PROOF TO MINIMISE DAMAGE OR THEFT.
- ALL WELDS TO BE CONTINUOUS FILLET WELDS, GROUND OFF SMOOTH & FLUSH IN ACCORDANCE WITH AS 1554. GRIND SMOOTH EDGES & WELDS PRIOR TO H.D.G. OR APPLIED FINISHES.


### CONCRETE WORK NOTES

- ALL WORKMANSHIP AND MATERIAL SHALL BE IN ACCORDANCE WITH AS 3600.
- AT A MINIMUM ALL CONCRETE TO BE GRADE N25. CONCRETE SHALL BE NORMAL CLASS CONCRETE UNLESS DIRECTED OTHERWISE. N25 SHALL MEAN NORMAL CLASS CONCRETE WITH A 28 DAY CHARACTERISTIC STRENGTH OF 25MPa. CONCRETE MIX DESIGN SHALL BE SUBMITTED TO THE SITE SUPERINTENDENT FOR APPROVAL FIVE (5) DAYS PRIOR TO ORDERING.
- ALL CEMENT TO BE TYPE GP OR GB TO AS 3972 UNLESS SPECIFIED OTHERWISE.
- NORMAL AGGREGATE SIZE TO BE 20mm, SLUMP TO BE NOT GREATER THAN 80mm.

	<ul> <li>FOR SLIP RESISTANCE REQUIREMENTS REFI</li> </ul>	ER SPECIF	ICATION	S150 RO	ADWORKS.				
					DRAWING AUTHORISED FOR PUBLICATION PAUL COTTON SIGNATURE ON ORIGINAL DATED	DESIGN	Std Dwgs WG	DATE	OCT '13
					03/09/04 MANAGER INFRASTRUCTURE MANAGEMENT	DRAWN	CPO - P&D	DATE	OCT '13
					R.P.E.Q: 2546 DESIGN APPROVED	CHECKED	UMD - E&P & IMB	DATE	OCT '13
А	Drawing Converted From UMS Series April 2014	APR '14	APR '14	APR '14	LAUREN TEMPLEMAN SIGNATURE ON ORIGINAL DATED 31/08/04	DRAWING FILENAME	BSD-7305 (A) Parks whee	lie bin enclo	sure.dwg
ISSUE	AMENDMENT	DRAWN DATE	CHK'D DATE	APPR'D DATE	PRICIPAL PROGRAM OFFICER PARKS	ASSOCIATED PLANS	SUPERSEDES UMS-712		

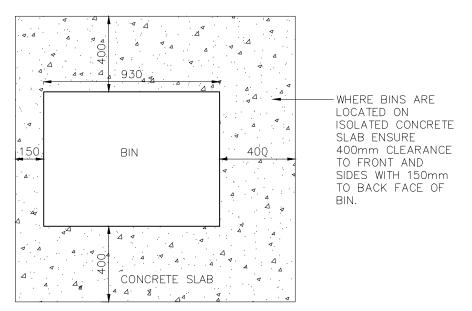

SINGLE BIN ENCLOSURE - ISOLATED SETOUT PLAN

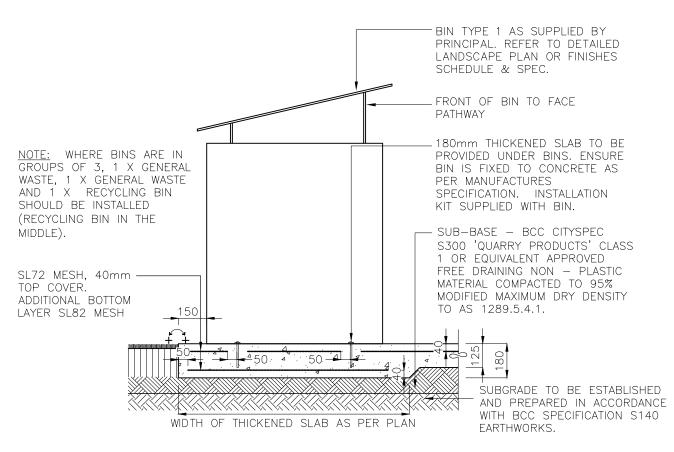


BIN ENCLOSURE - TYPICAL SECTION




### **BRISBANE CITY COUNCIL STANDARD DRAWING**

PARKS WHEELIE BIN **ENCLOSURE** 

•	DAND DI	MILLIO
	SEALE 1:2	20
	DWG No.	
	BSD-	7305
	ORIGINAL SIZE	REVISION
	Α3	А

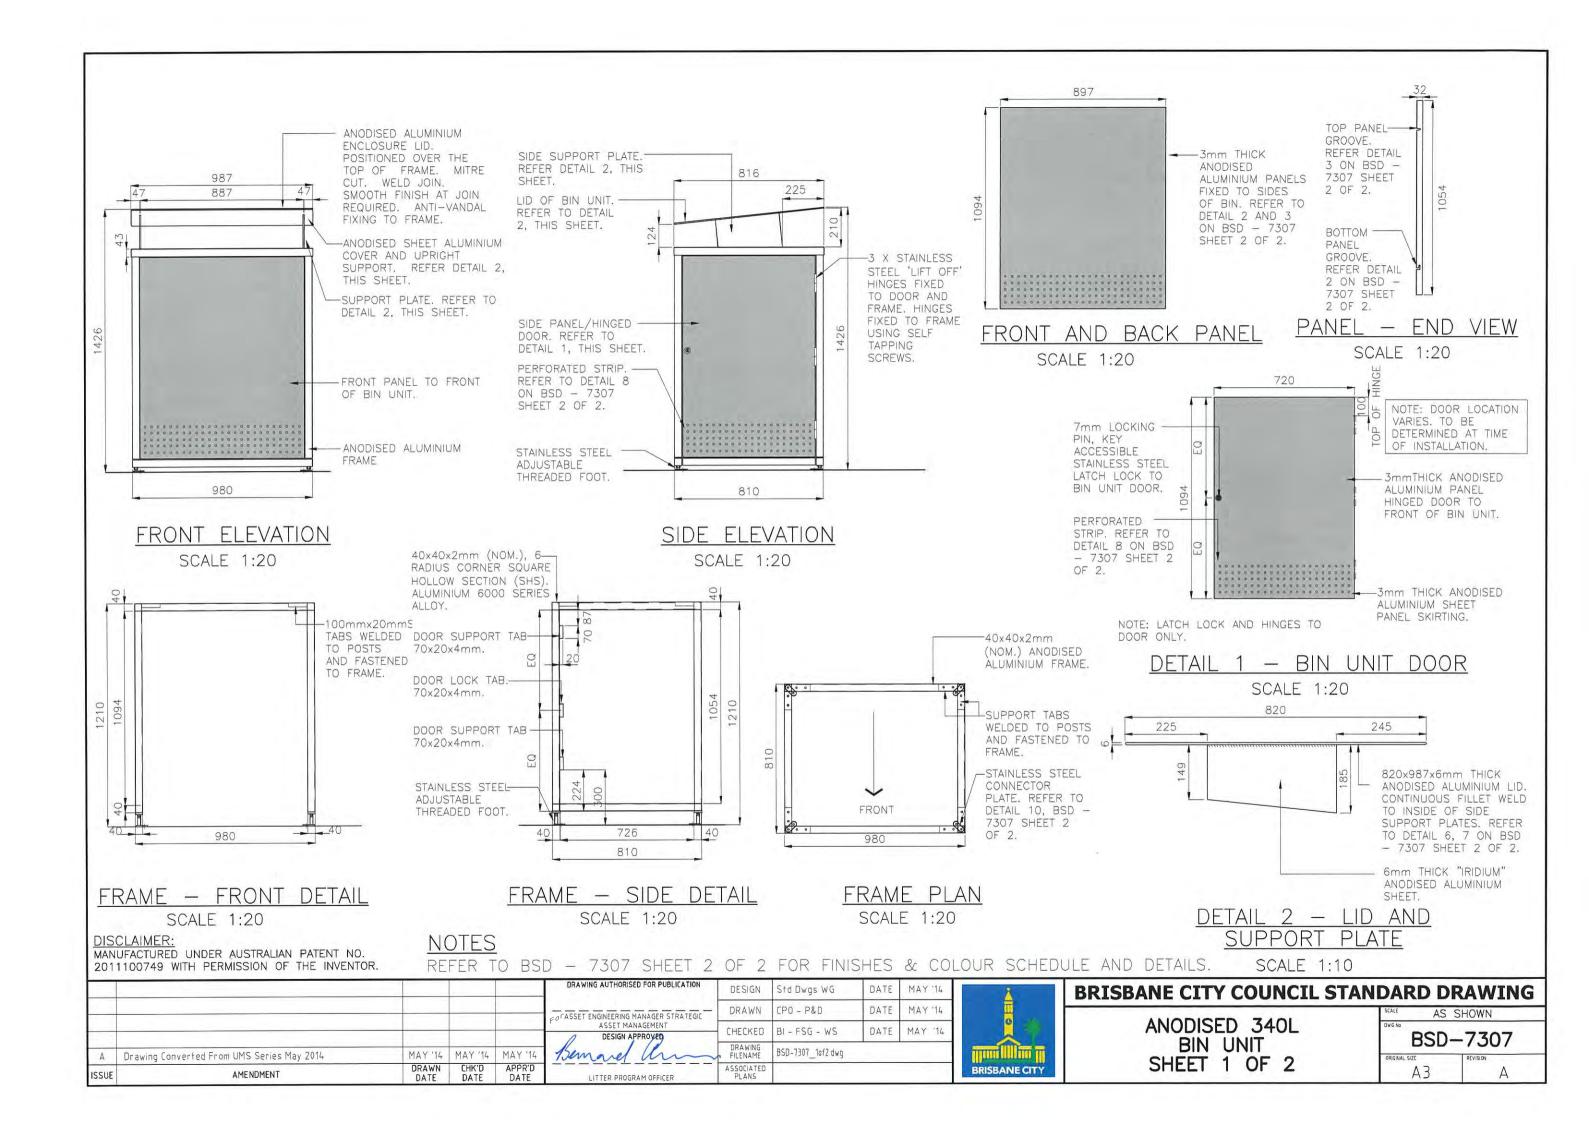


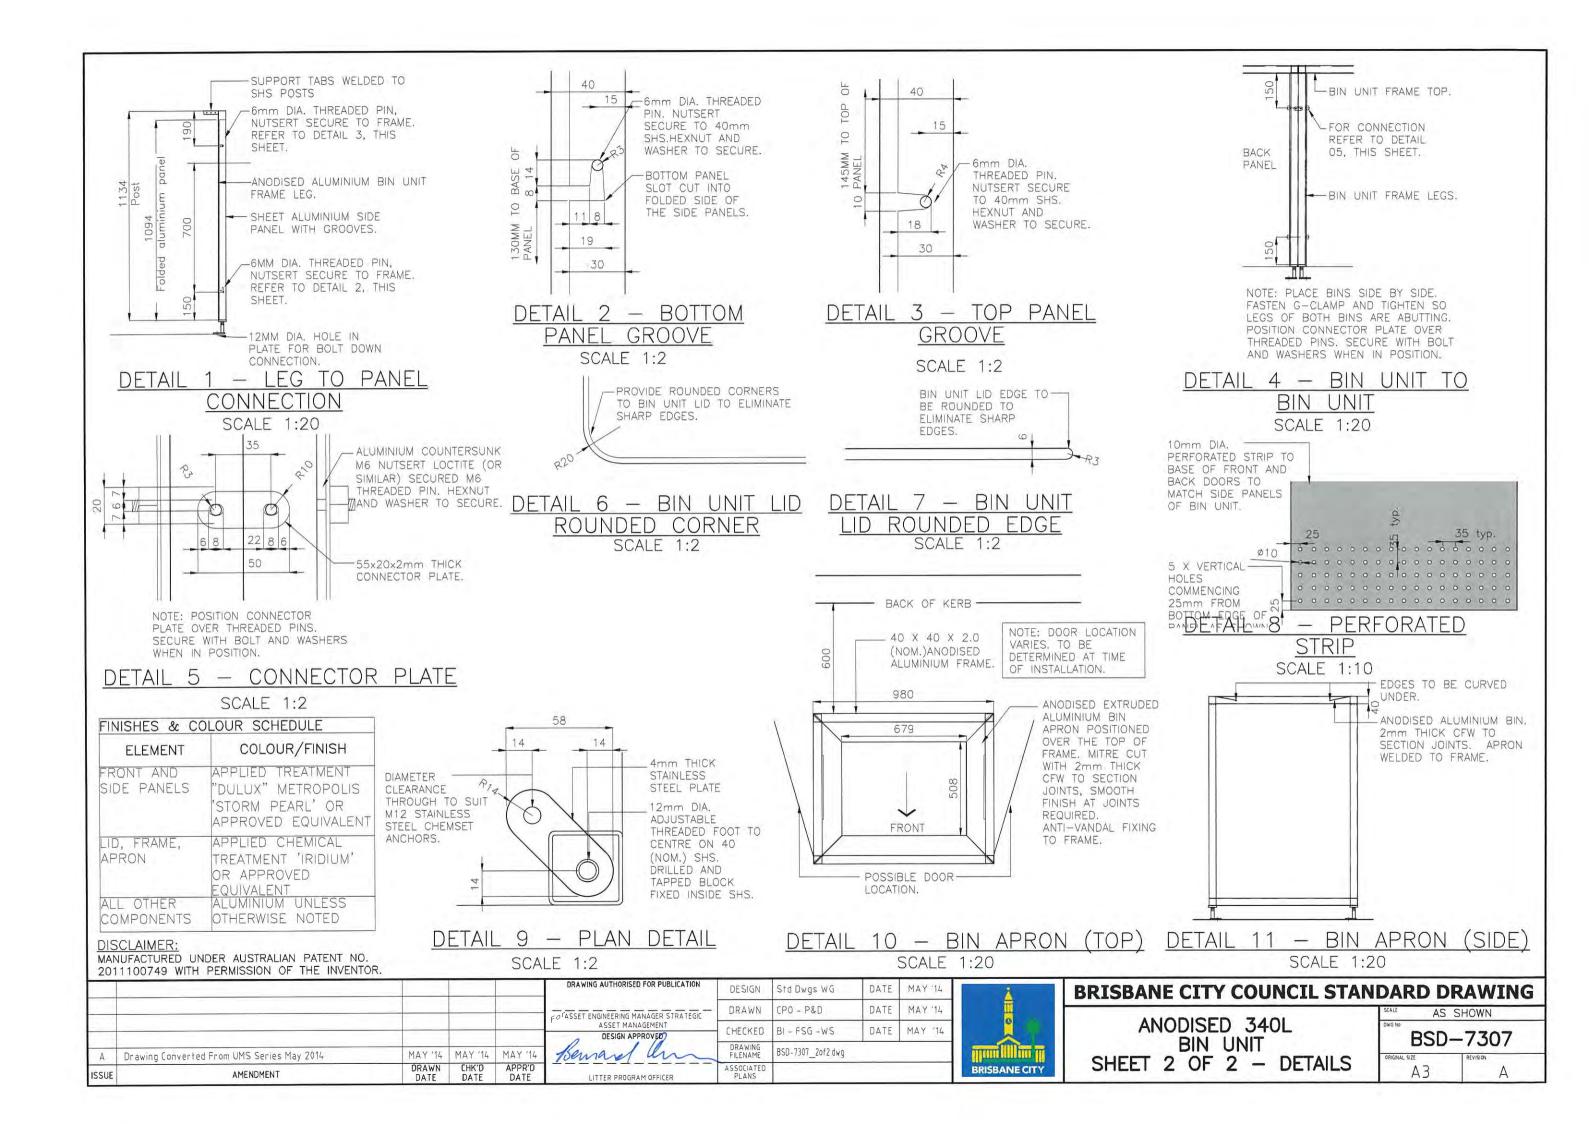


FOUNTAIN WITH DOG BOWL FEATURE


319.2 O/A

FRONT VIEW

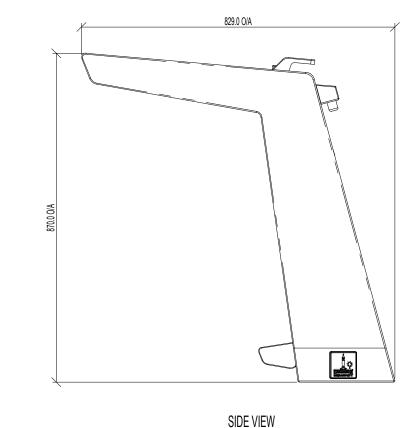

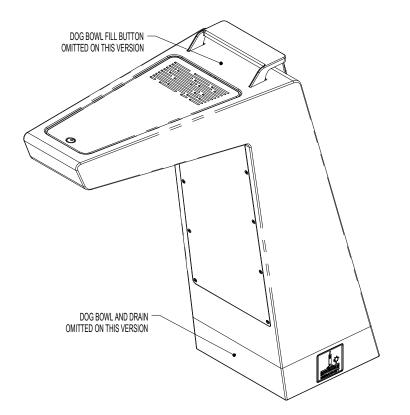

STANDARD FOUNTAIN

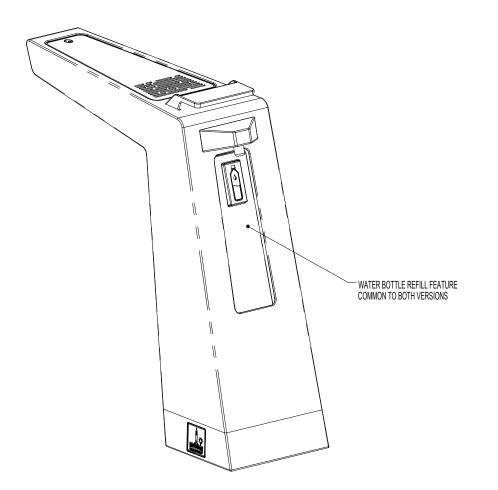

### STANDARDS

DESIGNED IN ACCORDANCE WITH, AND FABRICATION TO MEET THE FOLLOWING STANDARDS:

- AS1428.4.1:2009, TACTILE GROUND SURFACE INDICATORS FOR THE ORIENTATION OF PEOPLE WITH VISION IMPAIRMENT.
- AS1627.4 METAL FINISHING -PREPARATION AND PRE-TREATMENT OF SURFACES - ABRASIVE BLAST CLEANING OF STEEL.
- AS2312:2002/AMDT 1:2004, GUIDE TO PROTECTION OF IRON AND STEEL AGAINST EXTERIOR ATMOSPHERIC CORROSION, 1994.
- GUIDE TO ENGINEERING PRACTICE, 'PEDESTRIANS', PART 13, AUSTROADS.
- 5. AUSTRALIAN ROAD RULES , 1999, WWW.NRTC.GOV.AU
- 6. AS4506 -2005, METAL FINISHING-THERMOSET POWDER COATINGS.
- 7. AS4680:2006, HOT DIP GALVANISING.

### **NOTES**

- WELDING TO BE ACCORDANCE TO AS1554.1 CAT GP WELDING, ALL SHARP EDGES & BURRS REMOVED.
- PART SHOULD BE SUPPLIED CLEAN AND FREE FROM MARKS, BURRS, SCUFFS, DISTORTION AND WARPAGE.
- 3. ENSURE ANTI-SEIZE IS ON ALL NUTS AND BOLTS PRIOR TO ASSEMBLY.
- 4. DRAWING TO AS1100 DRAWING STANDARDS.
- 5. 316 S.S AND 316 S.S FASTENERS TO BE USED THROUGHOUT FOR COASTAL INSTALLATIONS OR ANY ENVIRONMENT WITH HIGH CORROSION.
- 6. ALL TOLERANCES ± 1.5mm UNLESS OTHERWISE SPECIFIED

### **MATERIAL**

- 1. MATERIAL: SEE COMPONENT DRAWING
- 2. COLOUR: SEE COMPONENT DRAWING
- 3. FINISH: SEE COMPONENT DRAWING

STRUCTURAL DESIGN REVIEWED AND CERTIFIED FOR ISSUE	
NAME: <u>B.C. PLANT</u> RPEQ: <u>8807</u>	_
SIGNATURE: <u>ON ORIGINAL</u> DATE: 10 / 05 /	18

ISSUE	AMENDMENT	DRAWN DATE	CHK'D DATE	APPR'D DATE
Α	Drawing Converted from UMS Series April 2014	APR '14	APR '14	APR '14
В	Water bottle refill addition	JAN '15	JAN '15	JAN '15
С	Dog Bowl Addition	MAY '18	JUN '18	NOV '18

DRAWING AUTHORISED FOR PUBLICATION INGA CONDRIC AUTHORISED 15/04/2014	DESIGN
ASSET ENGINEERING MANAGER	DRAWN
STRATEGIC ASSET MANAGEMENT  DESIGN APPROVED	CHECKE
VICKI MARTIN SIGNATURE ON ORIGINAL	DRAWING FILENAME
PRINCIPAL PLANNING OFFICER	ASSOCIATE


-	DESIGN	FORMZOO DESIGN	DATE	JUN '12		
	DRAWN	АВ	DATE	JUN '12		
	CHECKED	VM	DATE	APR '13		
	DRAWING FILENAME	BSD-7331 (C) Drinking fountain - Sheet 1 of 27				
_	ASSOCIATED PLANS	SUPERSEDES UMS-569				




### **BRISBANE CITY COUNCIL STANDARD DRAWING**

DRINKING FOUNTAIN SHEET 1 OF 27

•	DAILD DI	ATTITO
	SCALE 1:	10
	DWG No.	
	BSD-	7331
	ORIGINAL SIZE	REVISION
	Α3	С

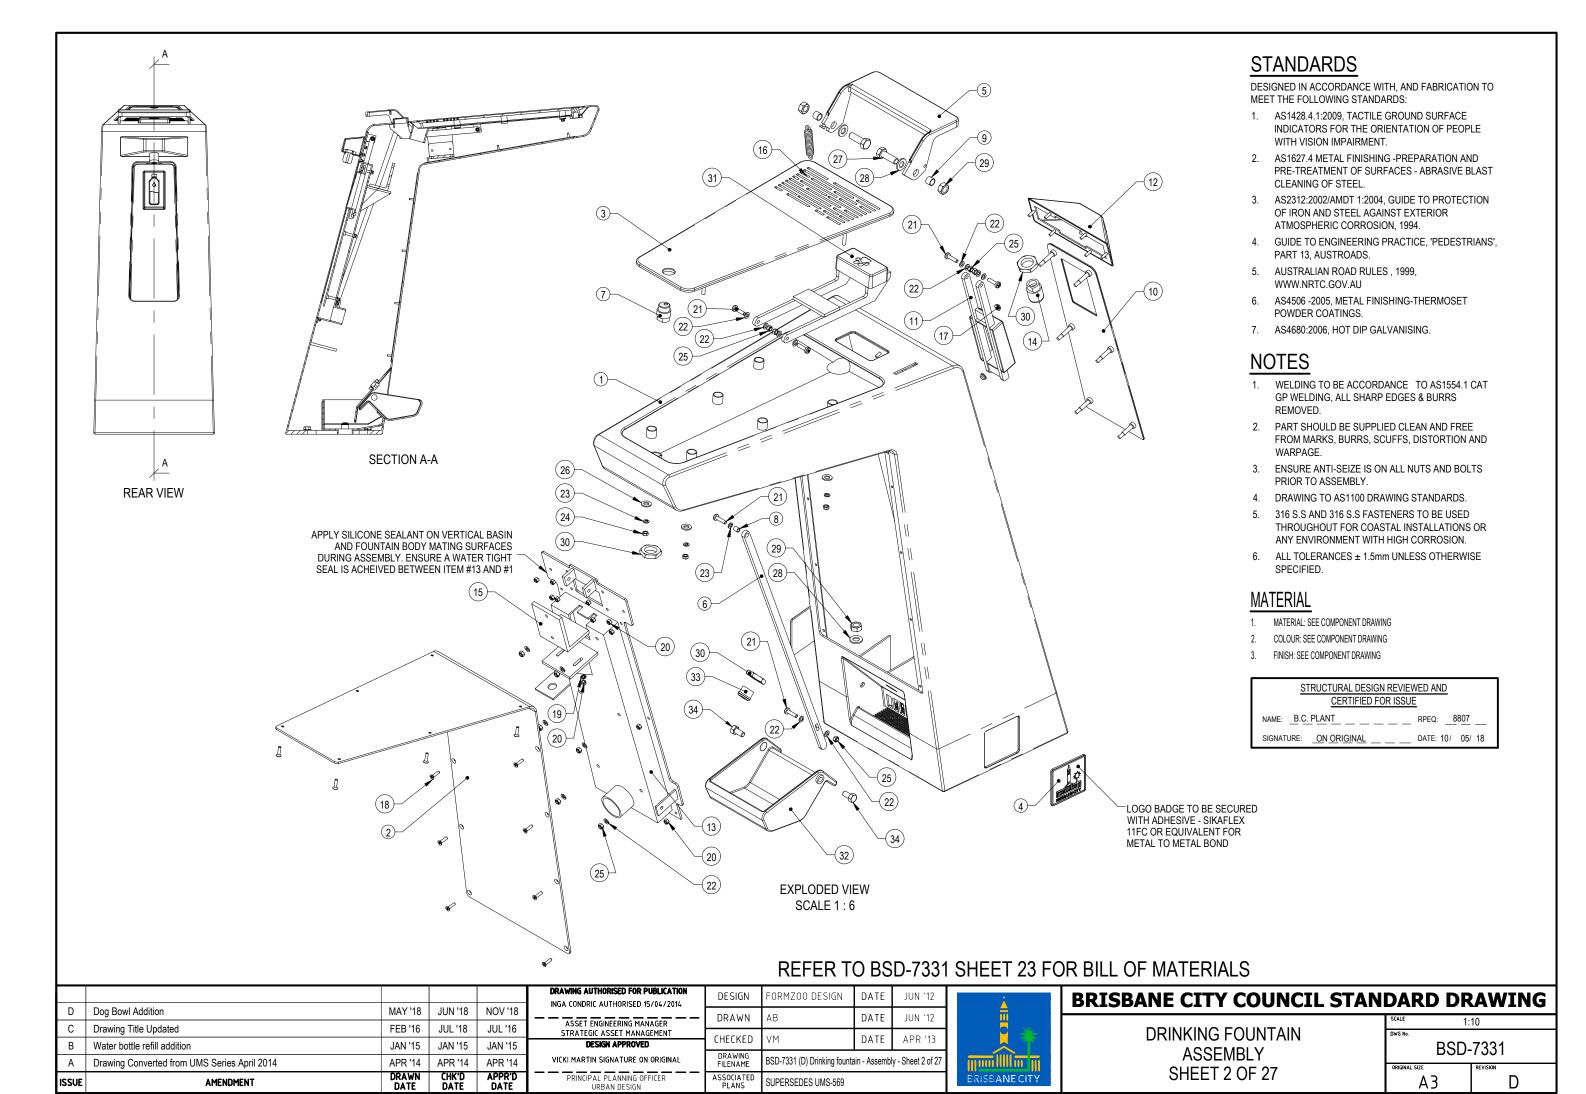

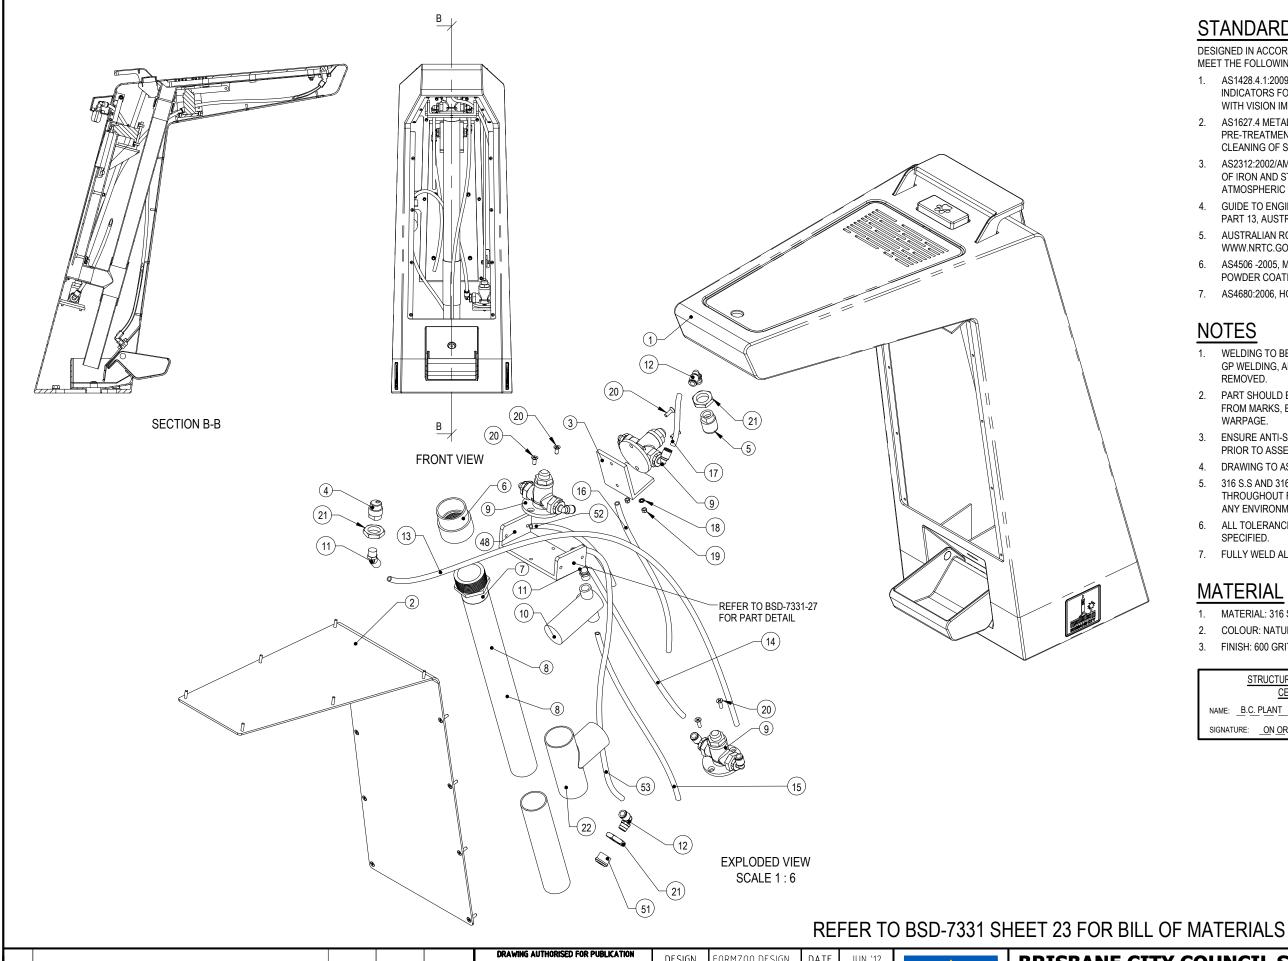

DESIGNED IN ACCORDANCE WITH, AND FABRICATION TO MEET THE FOLLOWING STANDARDS:

- 1. AS1428.4.1:2009. TACTILE GROUND SURFACE INDICATORS FOR THE ORIENTATION OF PEOPLE WITH VISION IMPAIRMENT.
- 2. AS1627.4 METAL FINISHING -PREPARATION AND PRE-TREATMENT OF SURFACES - ABRASIVE BLAST CLEANING OF STEEL.
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- AUSTRALIAN ROAD RULES, 1999, WWW.NRTC.GOV.AU
- 6. AS4506 -2005, METAL FINISHING-THERMOSET POWDER COATINGS.
- 7. AS4680:2006, HOT DIP GALVANISING.

### **NOTES**

- WELDING TO BE ACCORDANCE TO AS1554.1 CAT GP WELDING, ALL SHARP EDGES & BURRS
- 2. PART SHOULD BE SUPPLIED CLEAN AND FREE FROM MARKS, BURRS, SCUFFS, DISTORTION AND
- 3. ENSURE ANTI-SEIZE IS ON ALL NUTS AND BOLTS PRIOR TO ASSEMBLY.
- 4. DRAWING TO AS1100 DRAWING STANDARDS.
- 316 S.S AND 316 S.S FASTENERS TO BE USED THROUGHOUT FOR COASTAL INSTALLATIONS OR ANY ENVIRONMENT WITH HIGH CORROSION.
- 6. ALL TOLERANCES ± 1.5mm UNLESS OTHERWISE SPECIFIED.
- 7. FULLY WELD ALL JOINING MATERIAL 3mm FILLET.

### **MATERIAL**

- MATERIAL: 316 STAINLESS STEEL
- 2. COLOUR: NATURAL
- 3. FINISH: 600 GRIT POLISHED / GARNET BLASTING.

STRUCT	TURAL DESIGN REVIEWED AND
	CERTIFIED FOR ISSUE

NAME: B.C. PLANT SIGNATURE: ON ORIGINAL DATE: 10/ 05/ 18

ISSUE	AMENDMENT	DRAWN DATE	CHK'D DATE	APPR'D DATE	
Α	Drawing Converted from UMS Series April 2014	APR '14	APR '14	APR '14	١.
В	Water bottle refill addition	JAN '15	JAN '15	JAN '15	
С	Drawing Title Amended	FEB '16	JUL '18	JUL '16	l
D	Dog Bowl Addition	MAY '18	JUN '18	AUG '18	١.


DRAWING AUTHORISED FOR PUBLICATION INGA CONDRIC AUTHORISED 15/04/2014	DESIGN	FORMZOO DESIGN	DATE	JUN '12	
ASSET ENGINEERING MANAGER	DRAWN	N AB DATE		JUN '12	
STRATEGIC ASSET MANAGEMENT	CHECKED	VM	DATE	APR '13	
DESIGN APPROVED	CHECKED	VITI	DAIL AFR IS		
VICKI MARTIN SIGNATURE ON ORIGINAL	DRAWING FILENAME	BSD-7331 (D) Drinking fountain - Plumbing - Sheet 3 of 27			
PRINCIPAL PLANNING OFFICER	ASSOCIATED SUPERSEDES UMS-569				




### **BRISBANE CITY COUNCIL STANDARD DRAWING**

**DRINKING FOUNTAIN PLUMBING** SHEET 3 OF 27

SCALE 1.	10	
	10	
DWG No.		
BSD-7331		
ORIGINAL SIZE	REVISION	
A3	D	

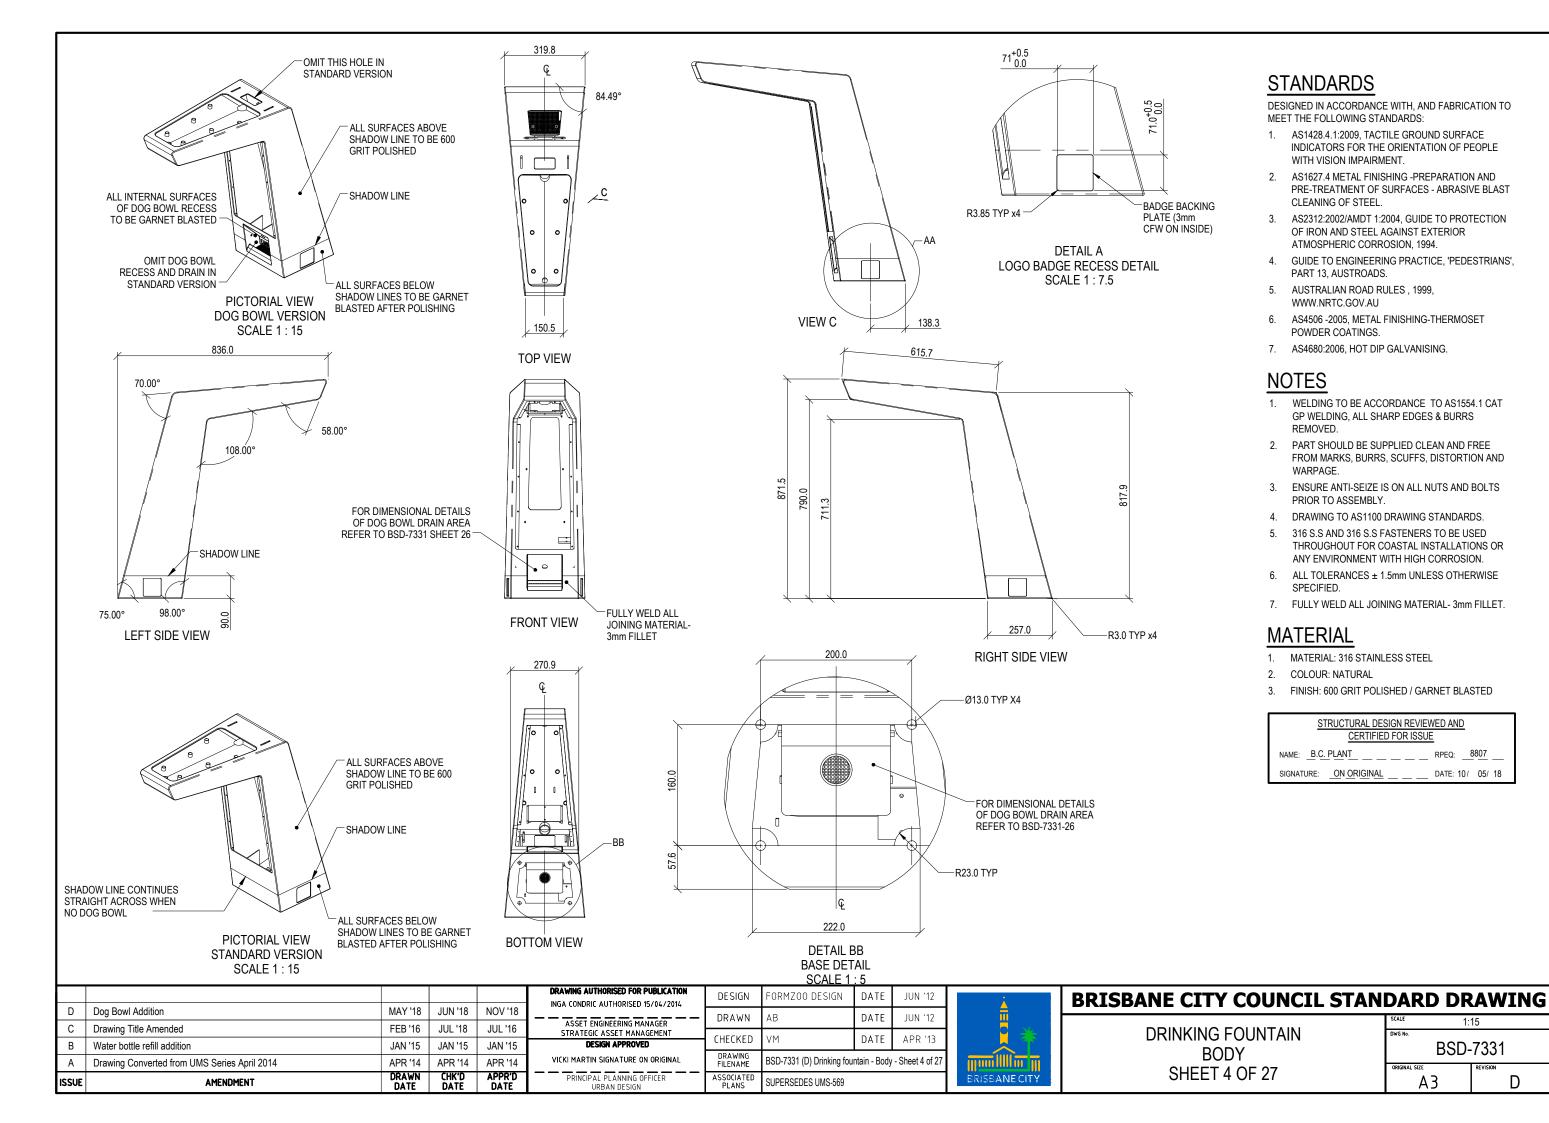


D

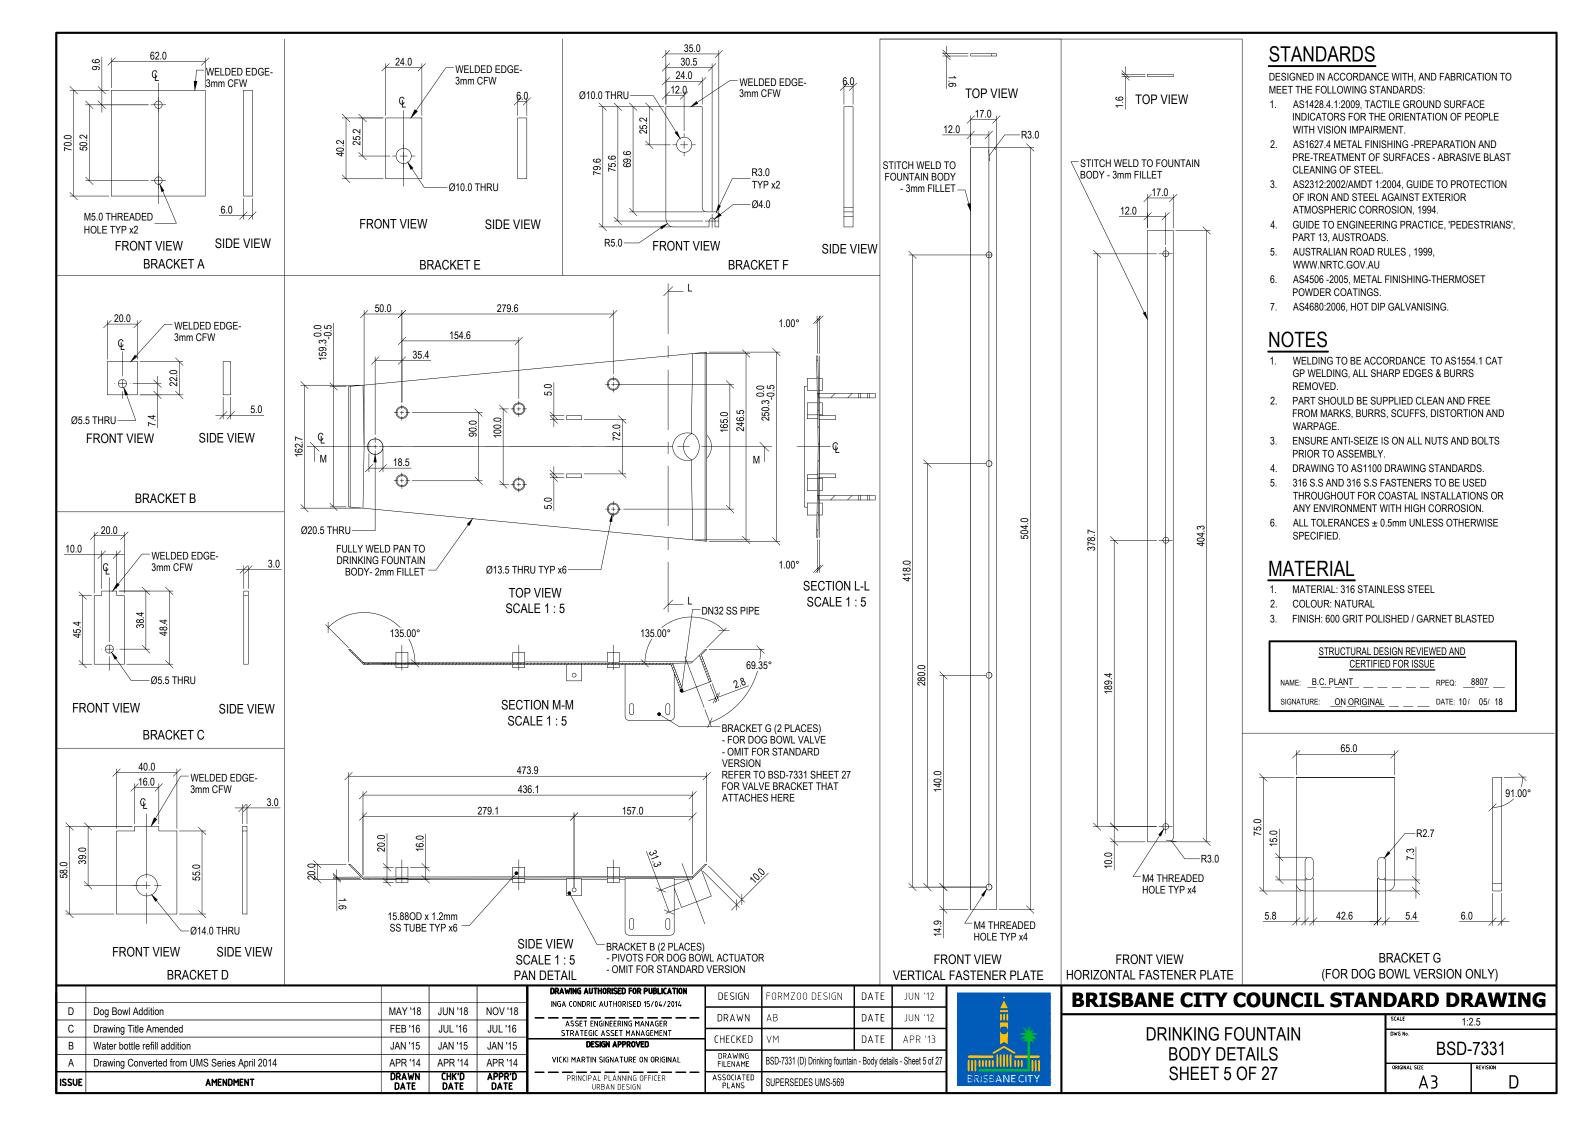

# THIS IS AN EXTERIOR FLAT PATTERN VIEW WITH EXTERIOR RADII REMOVED. THE OUTLINE DEPICTS THE THEORETICAL VERTEX. THIS OUTLINE IS TO BE CONFIRMED PRIOR TO MANUFACTURE. THIS HOLE IS FOR THE DOG BOWL VERSION ONLY - OMIT ON STANDARD VERSION ON STANDARD VERSION ON STANDARD VERSION

# TRUE SIDE VIEW (1:10) - NOT FULL SCALE FABRICATOR TO REVIEW SCALE BEFORE USING FLAT PATTERN

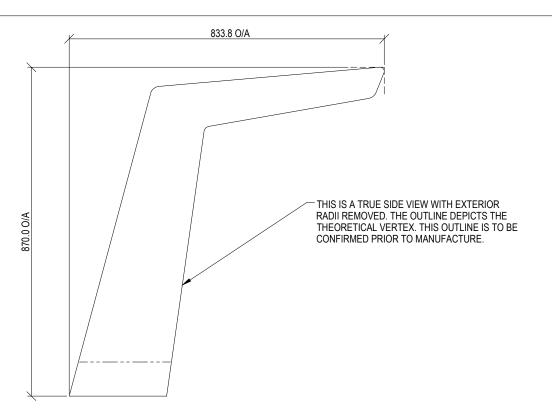

# TRUE SIDE VIEW (1:10) - NOT FULL SCALE FABRICATOR TO REVIEW SCALE BEFORE USING FLAT PATTERN

ISSUE	AMENDMENT	DRAWN DATE	CHK'D DATE	APPR'D DATE	PRINCIPAL PLANNING OFFICER URBAN DESIGN	ASSOCIATED PLANS	SUPERSEDES UMS-569		
Α	Drawing Converted from UMS Series April 2014	APR '14	APR '14	APR '14	VICKI MARTIN SIGNATURE ON ORIGINAL	DRAWING FILENAME	BSD-7331 (D) Drinking fountain	- Body flat patt	ern - Sheet 6 of 27
В	Water bottle refill addition	JAN '15	JAN '15	JAN '15	DESIGN APPROVED		VM	DATE	APR '13
С	Drawing Title Amended	FEB '16	JUL '16	JUL '16	ASSET ENGINEERING MANAGER STRATEGIC ASSET MANAGEMENT		1		
D	Dog Bowl Addition	MAY '18	JUN '18	NOV '18		DRAWN	АВ	DATE	JUN '12
					DRAWING AUTHORISED FOR PUBLICATION INGA CONDRIC AUTHORISED 15/04/2014	DESIGN	FORMZOO DESIGN	DATE	JUN '12



# STANDARDS

DESIGNED IN ACCORDANCE WITH, AND FABRICATION TO MEET THE FOLLOWING STANDARDS:

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- AS1627.4 METAL FINISHING -PREPARATION AND PRE-TREATMENT OF SURFACES - ABRASIVE BLAST CLEANING OF STEEL.
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- 5. AUSTRALIAN ROAD RULES , 1999, WWW.NRTC.GOV.AU
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### **NOTES**

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- 3. ENSURE ANTI-SEIZE IS ON ALL NUTS AND BOLTS PRIOR TO ASSEMBLY.
- 4. DRAWING TO AS1100 DRAWING STANDARDS.
- 5. 316 S.S AND 316 S.S FASTENERS TO BE USED THROUGHOUT FOR COASTAL INSTALLATIONS OR ANY ENVIRONMENT WITH HIGH CORROSION.
- 6. ALL TOLERANCES ± 1.5mm UNLESS OTHERWISE SPECIFIED.

### **MATERIAL**


- 1. MATERIAL: 316 STAINLESS STEEL
- 2. COLOUR: NATURAL
- 3. FINISH: 600 GRIT POLISHED / GARNET BLASTED

STRUCTURAL DESIGN REVIEWED AND CERTIFIED FOR ISSUE			
NAME: <u>B.C. PLANT</u> RPEQ: <u>8807</u>			
SIGNATURE: ON ORIGINAL DATE: 10/ 05/ 18			

### **BRISBANE CITY COUNCIL STANDARD DRAWING**

DRINKING FOUNTAIN BODY - FLAT PATTERN SHEET 6 OF 27

	SCALE 1	:10
	DWG No.	
	I RSD.	-7331
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	ORIGINAL SIZE	REVISION
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DESIGNED IN ACCORDANCE WITH, AND FABRICATION TO MEET THE FOLLOWING STANDARDS:

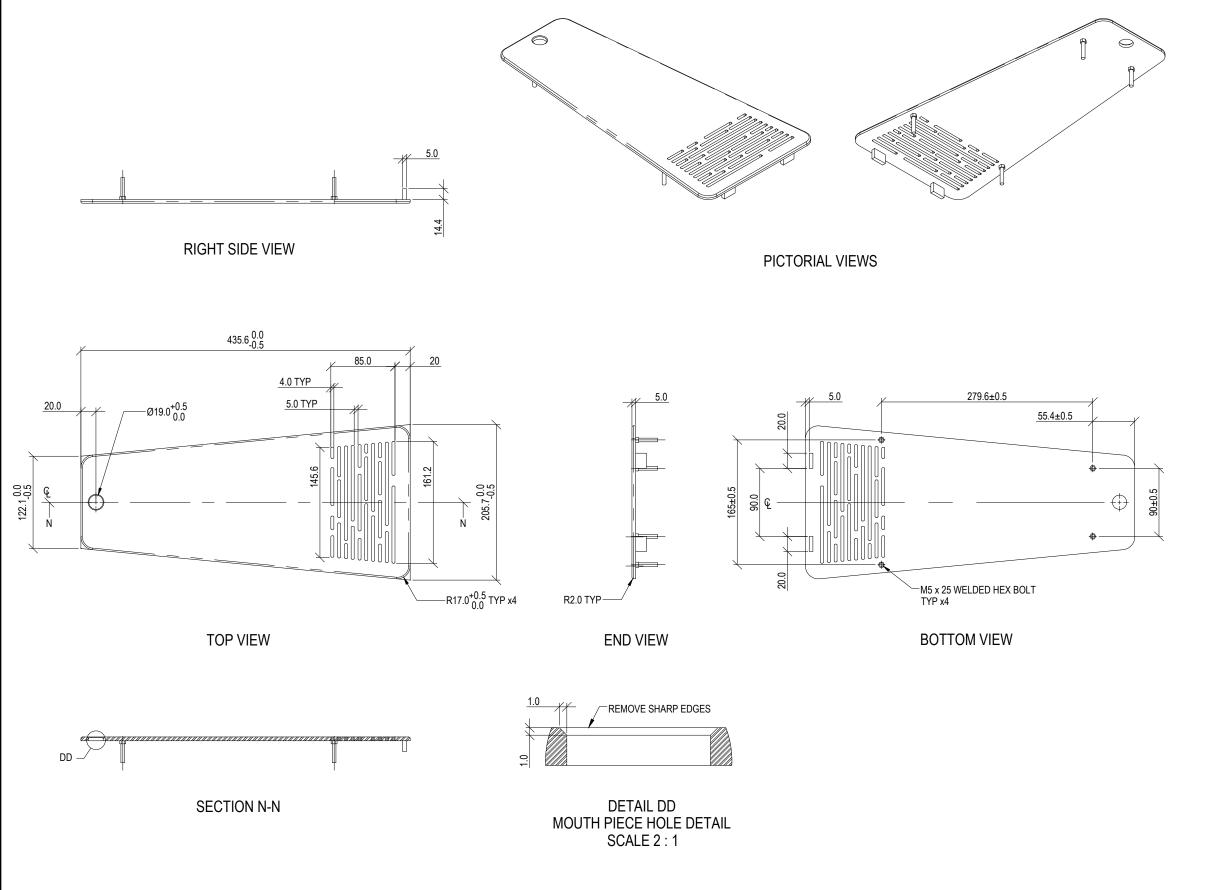- AS1428.4.1:2009, TACTILE GROUND SURFACE INDICATORS FOR THE ORIENTATION OF PEOPLE WITH VISION IMPAIRMENT.
- AS1627.4 METAL FINISHING -PREPARATION AND PRE-TREATMENT OF SURFACES - ABRASIVE BLAST CLEANING OF STEEL.
- AS2312:2002/AMDT 1:2004, GUIDE TO PROTECTION OF IRON AND STEEL AGAINST EXTERIOR ATMOSPHERIC CORROSION, 1994.
- GUIDE TO ENGINEERING PRACTICE, 'PEDESTRIANS', PART 13, AUSTROADS.
- 5. AUSTRALIAN ROAD RULES , 1999, WWW.NRTC.GOV.AU
- 6. AS4506 -2005, METAL FINISHING-THERMOSET POWDER COATINGS.
- 7. AS4680:2006, HOT DIP GALVANISING.

### **NOTES**


- WELDING TO BE ACCORDANCE TO AS1554.1 CAT GP WELDING, ALL SHARP EDGES & BURRS REMOVED.
- PART SHOULD BE SUPPLIED CLEAN AND FREE FROM MARKS, BURRS, SCUFFS, DISTORTION AND WARPAGE.
- 3. ENSURE ANTI-SEIZE IS ON ALL NUTS AND BOLTS PRIOR TO ASSEMBLY.
- 4. DRAWING TO AS1100 DRAWING STANDARDS.
- 316 S.S AND 316 S.S FASTENERS TO BE USED THROUGHOUT FOR COASTAL INSTALLATIONS OR ANY ENVIRONMENT WITH HIGH CORROSION.
- ALL TOLERANCES ± 1.5mm UNLESS OTHERWISE SPECIFIED.

### **MATERIAL**

- 1. MATERIAL: 316 STAINLESS STEEL
- 2. COLOUR: NATURAL
- 3. FINISH: HIGHLY POLISHED

STRUCTURAL DESIGN REVIEWED AND CERTIFIED FOR ISSUE				
NAME: B.C. PLANT RPEQ: 8807				
SIGNATURE: ON ORIGINAL DATE: 10/ 05/ 18				

ISSUE	AMENDMENT	DRAWN DATE	CHK'D DATE	APPR'D DATE
Α	Drawing Converted from UMS Series April 2014	APR '14	APR '14	APR '14
В	Water bottle refill addition	JAN '15	JAN '15	JAN '15
С	Drawing Title Amended	FEB '16	JUL '16	JUL '16
D	Dog Bowl Addition	MAY '18	JUN '18	NOV '18

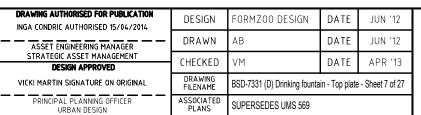




### **BRISBANE CITY COUNCIL STANDARD DRAWING**

DRINKING FOUNTAIN TOP PLATE SHEET 7 OF 27

	SCALE	1:5
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	DWG No.	
	DC	אר די די
	DO	SD-7331
	ORIGINAL SIZE	REVISION
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	I A3	ט ו
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DESIGNED IN ACCORDANCE WITH, AND FABRICATION TO MEET THE FOLLOWING STANDARDS:

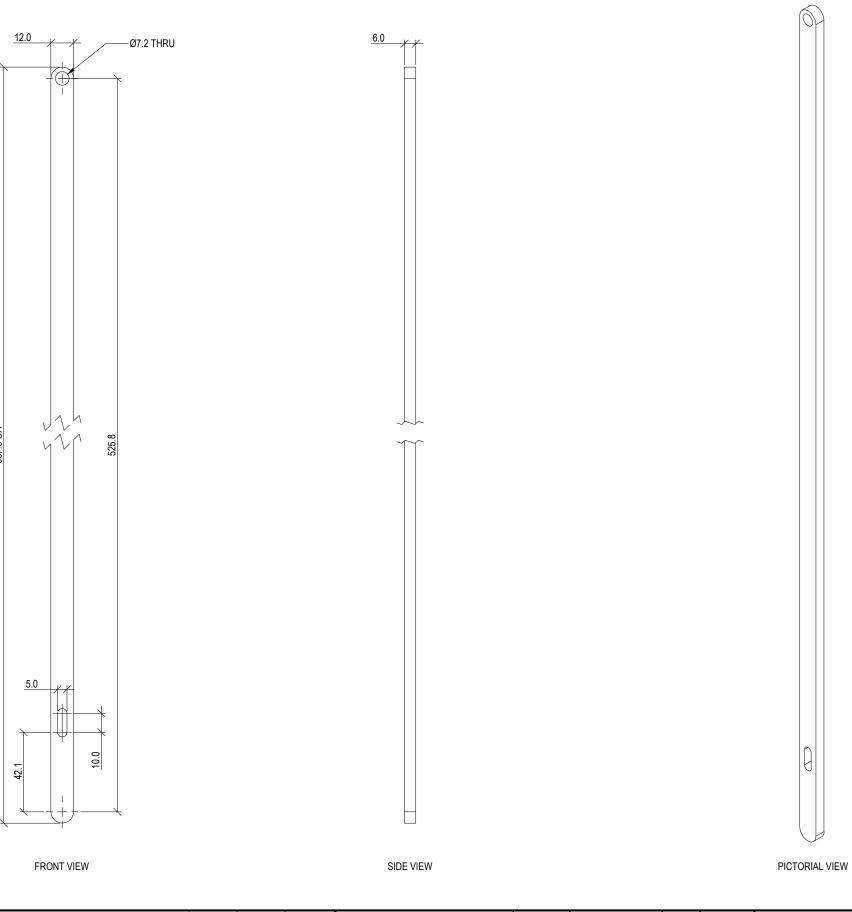- 1. AS1428.4.1:2009, TACTILE GROUND SURFACE INDICATORS FOR THE ORIENTATION OF PEOPLE WITH VISION IMPAIRMENT.
- 2. AS1627.4 METAL FINISHING -PREPARATION AND PRE-TREATMENT OF SURFACES - ABRASIVE BLAST CLEANING OF STEEL.
- 3. AS2312:2002/AMDT 1:2004, GUIDE TO PROTECTION OF IRON AND STEEL AGAINST EXTERIOR ATMOSPHERIC CORROSION, 1994.
- 4. GUIDE TO ENGINEERING PRACTICE, 'PEDESTRIANS', PART 13, AUSTROADS.
- 5. AUSTRALIAN ROAD RULES, 1999, WWW.NRTC.GOV.AU
- 6. AS4506 -2005, METAL FINISHING-THERMOSET POWDER COATINGS.
- 7. AS4680:2006, HOT DIP GALVANISING.

### **NOTES**

- 1. WELDING TO BE ACCORDANCE TO AS1554.1 CAT GP WELDING, ALL SHARP EDGES & BURRS REMOVED.
- 2. PART SHOULD BE SUPPLIED CLEAN AND FREE FROM MARKS, BURRS, SCUFFS, DISTORTION AND
- 3. ENSURE ANTI-SEIZE IS ON ALL NUTS AND BOLTS PRIOR TO ASSEMBLY.
- 4. DRAWING TO AS1100 DRAWING STANDARDS.
- 5. 316 S.S AND 316 S.S FASTENERS TO BE USED THROUGHOUT FOR COASTAL INSTALLATIONS OR ANY ENVIRONMENT WITH HIGH CORROSION.
- 6. ALL TOLERANCES ± 1.5mm UNLESS OTHERWISE SPECIFIED.

### **MATERIAL**

- 1. MATERIAL: 316 STAINLESS STEEL
- 2. COLOUR: NATURAL
- 3. FINISH: DEBURRED

STRUCTURAL DESIGN REVIEWED AND							
CERTIFIED FOR ISSUE							
NAME: <u>B.C. PLANT</u> RPEQ: <u>8807</u>							
SIGNATURE: ON ORIGINAL DATE: 10 / 05 / 18							


ISSUE	AMENDMENT	DRAWN DATE	CHK'D DATE	APPR'D DATE	PRINCIPAL PLANNING OFFICER URBAN DESIGN	ASSOCIATED PLANS	SUPERSEDES UMS-569		
Α	Drawing Converted from UMS Series April 2014	APR '14	APR '14	APR '14	VICKI MARTIN SIGNATURE ON ORIGINAL	DRAWING FILENAME	BSD-7331 (D) Drinking fountain	n - Actuator arı	m - Sheet 8 of 27
В	Water bottle refill addition	JAN '15	JAN '15	JAN '15	DESIGN APPROVED		VM	DATE	APR '13
С	Drawing Title Amended	FEB '16	JUL '16	JUL '16	ASSET ENGINEERING MANAGER STRATEGIC ASSET MANAGEMENT				
D	Dog Bowl Addition	MAY '18	JUN '18	NOV '18		DRAWN	AB	DATE	JUN '12
					DRAWING AUTHORISED FOR PUBLICATION INGA CONDRIC AUTHORISED 15/04/2014	DESIGN	FORMZOO DESIGN	DATE	JUN '12



### **BRISBANE CITY COUNCIL STANDARD DRAWING**

DRINKING FOUNTAIN **ACTUATOR ARM** SHEET 8 OF 27

_		
	SCALE 1	:2
	DWG No.	
	BSD-	7331
	ORIGINAL SIZE	REVISION
	Α3	D

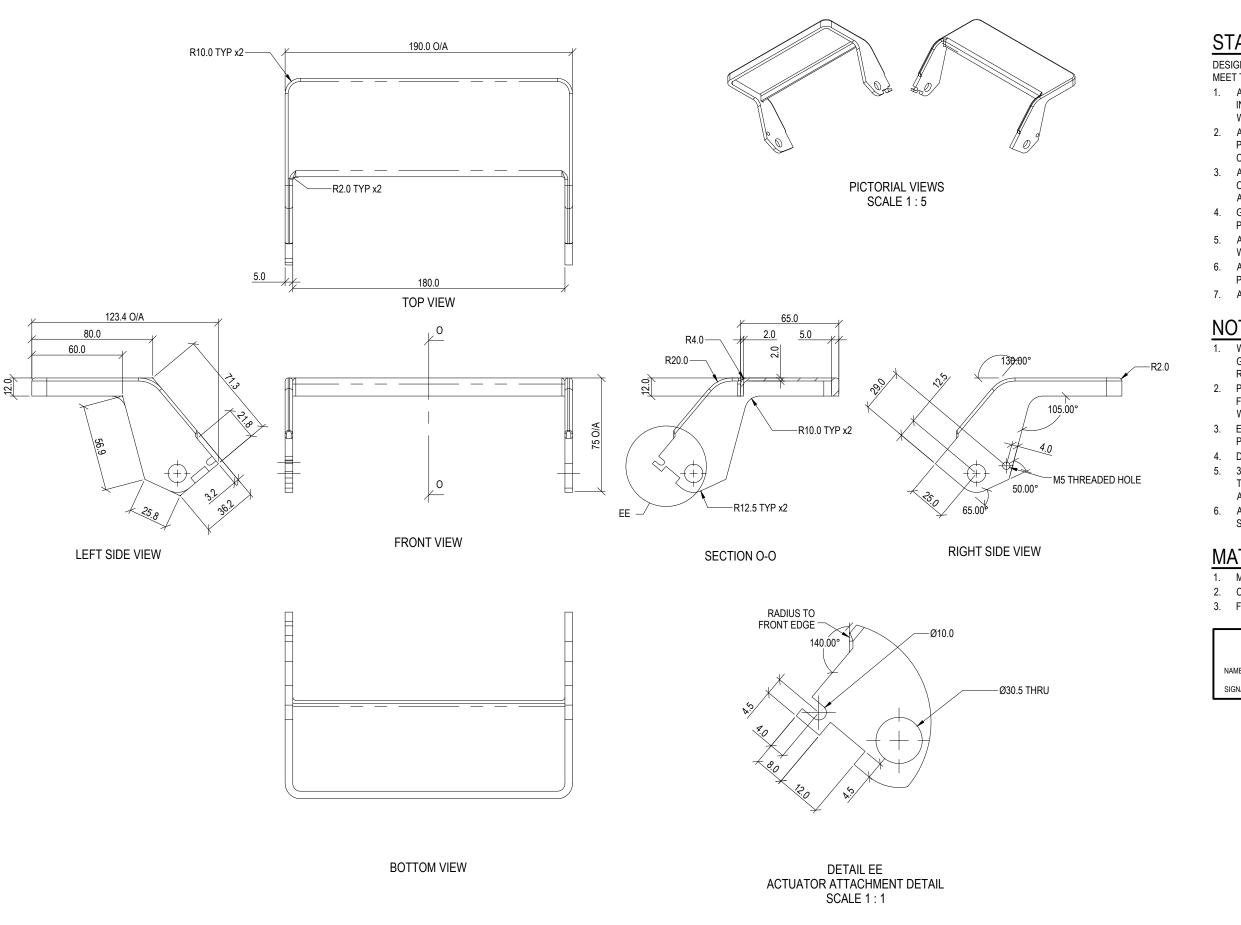

DESIGNED IN ACCORDANCE WITH, AND FABRICATION TO MEET THE FOLLOWING STANDARDS:

- 1. AS1428.4.1:2009, TACTILE GROUND SURFACE INDICATORS FOR THE ORIENTATION OF PEOPLE WITH VISION IMPAIRMENT.
- 2. AS1627.4 METAL FINISHING -PREPARATION AND PRE-TREATMENT OF SURFACES - ABRASIVE BLAST CLEANING OF STEEL.
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- 5. AUSTRALIAN ROAD RULES, 1999, WWW.NRTC.GOV.AU
- 6. AS4506 -2005, METAL FINISHING-THERMOSET POWDER COATINGS.
- 7. AS4680:2006, HOT DIP GALVANISING.

### **NOTES**

- WELDING TO BE ACCORDANCE TO AS1554.1 CAT GP WELDING, ALL SHARP EDGES & BURRS
- 2. PART SHOULD BE SUPPLIED CLEAN AND FREE FROM MARKS, BURRS, SCUFFS, DISTORTION AND WARPAGE.
- 3. ENSURE ANTI-SEIZE IS ON ALL NUTS AND BOLTS PRIOR TO ASSEMBLY.
- 4. DRAWING TO AS1100 DRAWING STANDARDS.
- 316 S.S AND 316 S.S FASTENERS TO BE USED THROUGHOUT FOR COASTAL INSTALLATIONS OR ANY ENVIRONMENT WITH HIGH CORROSION.
- 6. ALL TOLERANCES ± 0.5mm UNLESS OTHERWISE

### **MATERIAL**

- MATERIAL: 316 STAINLESS STEEL
- 2. COLOUR: NATURAL
- 3. FINISH: HIGHLY POLISHED

STRUCTURAL DESIGN REVIEWED  CERTIFIED FOR ISSUE	<u>AND</u>
NAME: B.C. PLANT RPE	:Q: <u>8807</u>
SIGNATURE: ON ORIGINAL DAT	E: 10/ 05/ 18


ISSUE	AMENDMENT	DRAWN DATE	CHK'D DATE	APPR'D DATE	PRINCIPAL PLANNING OFFICER URBAN DESIGN	ASSOCIATED PLANS	SUPERSEDES UMS-569		
Α	Drawing Converted from UMS Series April 2014	APR '14	APR '14	APR '14	VICKI MARTIN SIGNATURE ON ORIGINAL	DRAWING FILENAME	BSD-7331 (D) Drinking fount	ain - Actuato	r - Sheet 9 of 27
В	Water bottle refill addition	JAN '15	JAN '15	JAN '15	DESIGN APPROVED		VM	DATE	APR '13
С	Drawing Title Amended	FEB '16	JUL '16	JUL '16	ASSET ENGINEERING MANAGER STRATEGIC ASSET MANAGEMENT				
D	Dog Bowl Addition	MAY '18	JUN '18	NOV '18		DRAWN	АВ	DATE	JUN '12
					DRAWING AUTHORISED FOR PUBLICATION INGA CONDRIC AUTHORISED 15/04/2014	DESIGN	FORMZOO DESIGN	DATE	JUN '12





### **BRISBANE CITY COUNCIL STANDARD DRAWING**

**DRINKING FOUNTAIN ACTUATOR** SHEET 9 OF 27

•	DAILD DI	ATTITO
	SCALE 1:2	2.5
	DWG No.	
	BSD-	7331
	ORIGINAL SIZE	REVISION
	Α3	D

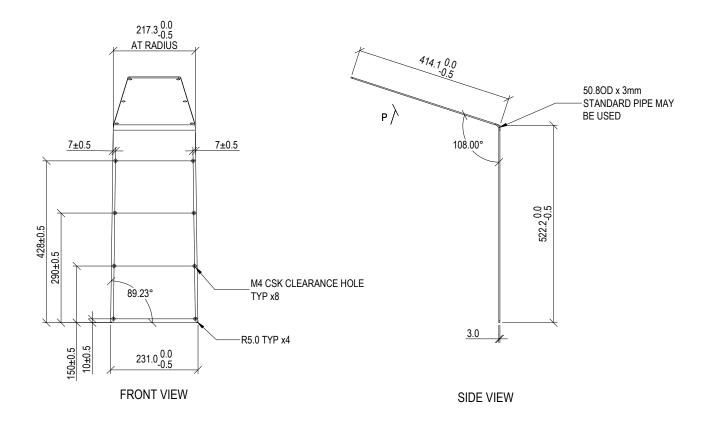

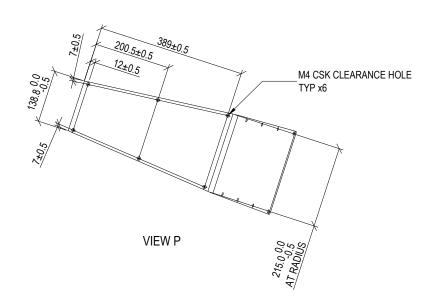

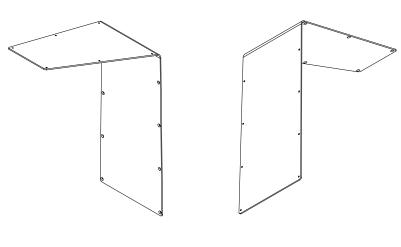

PICTORIAL VIEWS

### STANDARDS

DESIGNED IN ACCORDANCE WITH, AND FABRICATION TO MEET THE FOLLOWING STANDARDS:

- AS1428.4.1:2009, TACTILE GROUND SURFACE INDICATORS FOR THE ORIENTATION OF PEOPLE WITH VISION IMPAIRMENT.
- AS1627.4 METAL FINISHING -PREPARATION AND PRE-TREATMENT OF SURFACES - ABRASIVE BLAST CLEANING OF STEEL.
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- 5. AUSTRALIAN ROAD RULES , 1999, WWW.NRTC.GOV.AU
- . AS4506 -2005, METAL FINISHING-THERMOSET POWDER COATINGS.
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### **MATERIAL**

- 1. MATERIAL: 316 STAINLESS STEEL
- 2. COLOUR: NATURAL
- 3. FINISH: 600 GRIT POLISH

STRUCTURAL DESIGN REVIEWED AND CERTIFIED FOR ISSUE					
NAME: B.C. PLANT RPEQ:8807					
SIGNATURE: ON ORIGINAL DATE: 10 / 05 / 18					

ISSUE	AMENDMENT	DRAWN DATE	CHK'D DATE	APPR'D DATE	
Α	Drawing Converted from UMS Series April 2014	APR '14	APR '14	APR '14	
В	Water bottle refill addition	JAN '15	JAN '15	JAN '15	ĺ
С	Drawing Title Amended	FEB '16	JUL '16	JUL '16	ı
D	Dog Bowl Addition	MAY '18	JUN '18	NOV '18	
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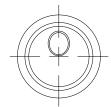
DRAWING AUTHORISED FOR PUBLICATION INGA CONDRIC AUTHORISED 15/04/2014	DESIGN	FORMZOO DESIGN	DATE	JUN '12	
ASSET ENGINEERING MANAGER	DRAWN	АВ	DATE	JUN '12	
STRATEGIC ASSET MANAGEMENT  DESIGN APPROVED	CHECKED	VM	DATE	APR '13	
VICKI MARTIN SIGNATURE ON ORIGINAL	DRAWING FILENAME	BSD-7331 (D) Drinking fountain - A	Access panel -	Sheet 10 of 27.dwg	
PRINCIPAL PLANNING OFFICER URBAN DESIGN	ASSOCIATED PLANS				




### **BRISBANE CITY COUNCIL STANDARD DRAWING**

DRINKING FOUNTAIN ACCESS PANEL SHEET 10 OF 27

•			W 1 V L	
	SCALE	1:	10	
	DWG No.			
		BSD-	7331	
	ORIGINAL SIZE		REVISION	
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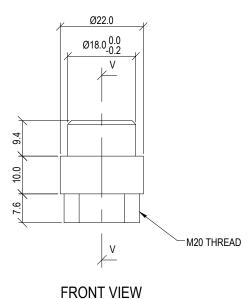



**TOP VIEW** 




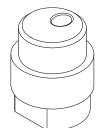

PICTORIAL VIEW



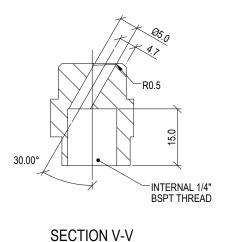

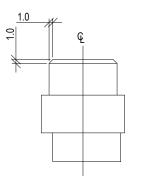

SIDE VIEW

DESIGNED IN ACCORDANCE WITH, AND FABRICATION TO MEET THE FOLLOWING STANDARDS:

- AS1428.4.1:2009, TACTILE GROUND SURFACE INDICATORS FOR THE ORIENTATION OF PEOPLE WITH VISION IMPAIRMENT.
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- 5. AUSTRALIAN ROAD RULES , 1999, WWW.NRTC.GOV.AU
- 6. AS4506 -2005, METAL FINISHING-THERMOSET POWDER COATINGS.
- 7. AS4680:2006, HOT DIP GALVANISING.


### **NOTES**

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- 3. ENSURE ANTI-SEIZE IS ON ALL NUTS AND BOLTS PRIOR TO ASSEMBLY.
- 4. DRAWING TO AS1100 DRAWING STANDARDS.
- 5. 316 S.S AND 316 S.S FASTENERS TO BE USED THROUGHOUT FOR COASTAL INSTALLATIONS OR ANY ENVIRONMENT WITH HIGH CORROSION.
- 6. ALL TOLERANCES ± 0.5mm UNLESS OTHERWISE SPECIFIED.

### MATERIAL

- 1. MATERIAL: 316 STAINLESS STEEL
- 2. COLOUR: NATURAL
- 3. FINISH: 600 GRIT POLISHED

STRUCTURAL DESIGN REVIEWED AND CERTIFIED FOR ISSUE					
NAME: B.C. PLANT RPEQ: <u>8807</u>					
SIGNATURE: ON ORIGINAL DATE: 10/ 05/ 18					

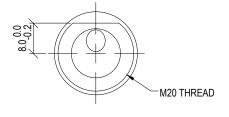

**BOTTOM VIEW** 

C Drawing Title Amended FEB '16 JUL '16 JUL '16 B Water bottle refill addition JAN '15 JAN '15 JAN '17	ISSUE	AMENDMENT	DRAWN DATE	CHK'D DATE	APPR'D DATE
C Drawing Title Amended FEB '16 JUL '16 JUL '16	Α	Drawing Converted from UMS Series April 2014	APR '14	APR '14	APR '14
	В	Water bottle refill addition	JAN '15	JAN '15	JAN '15
D Dog Bowl Addition MAY '18 JUN '18 NOV '1	С	Drawing Title Amended	FEB '16	JUL '16	JUL '16
	D	Dog Bowl Addition	MAY '18	JUN '18	NOV '18

DRAWING AUTHORISED FOR PUBLICATION INGA CONDRIC AUTHORISED 15/04/2014	DESIGN	FORMZOO DESIGN	DATE	JUN '12	
ASSET ENGINEERING MANAGER	DRAWN	АВ	DATE	JUN '12	
STRATEGIC ASSET MANAGEMENT	CHECKED	VM	DATE	APR '13	ı
DESIGN APPROVED	CHECKED	VIT	DAIL	AFR IJ	ı
VICKI MARTIN SIGNATURE ON ORIGINAL	DRAWING FILENAME	BSD-7331 (D) Drinking fountain	- Mouth piece	e - Sheet 11 of 27	l
PRINCIPAL PLANNING OFFICER URBAN DESIGN	ASSOCIATED PLANS	SUPERSEDES UMS-569			




DDTCDANE	CITY	COLINICII	CTANDADD	DDAWING
RKIZRANE	CIIY	COUNCIL	<b>STANDARD</b>	DKAWING


DRINKING FOUNTAIN MOUTH PIECE SHEET 11 OF 27


"	DAILD DI	ATTITO
	SCALE 1:	:1
	DWG No.	
	BSD-	7331
	ORIGINAL SIZE	REVISION
	Α3	D



ACTUAL SIZE SCALE 1:1

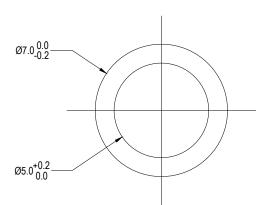

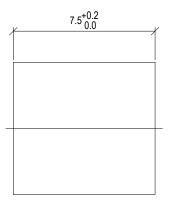

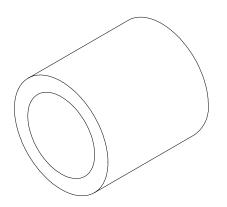

FRONT VIEW SIDE VIEW PICTORIAL VIEW

### **STANDARDS**

DESIGNED IN ACCORDANCE WITH, AND FABRICATION TO MEET THE FOLLOWING STANDARDS:

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- 6. ALL TOLERANCES  $\pm$  0.5mm UNLESS OTHERWISE SPECIFIED.

### **MATERIAL**

- 1. MATERIAL: 316 STAINLESS STEEL
- 2. COLOUR: NATURAL
- 3. FINISH: DEBURRED

STRUCTURAL DESIGN REVIEWED AND CERTIFIED FOR ISSUE				
NAME: <u>B.C. PLANT</u> RPE	EQ: <u>8807</u>			
SIGNATURE: ON ORIGINAL DAT	E: 10/ 05/ 18			


ISSUE	AMENDMENT	DRAWN DATE	CHK'D DATE	APPR'D Date	PRINCIPAL PLANNING OFFICER URBAN DESIGN	ASSOCIATED PLANS	SUPERSEDES UMS-569		
Α	Drawing Converted from UMS Series April 2014	APR '14	APR '14	APR '14	VICKI MARTIN SIGNATURE ON ORIGINAL	DRAWING FILENAME	BSD-7331 (D) Drinking fountain - A	Actuator arm bu	ısh - Sheet 12 of 27
В	Water bottle refill addition	JAN '15	JAN '15	JAN '15	DESIGN APPROVED		VM	DATE	APR '13
С	Drawing Title Amended	FEB '16	JUL '16	JUL '16	ASSET ENGINEERING MANAGER STRATEGIC ASSET MANAGEMENT				
D	Dog Bowl Addition	MAY '18	JUN '18	NOV '18		DRAWN	AB	DATE	JUN '12
					DRAWING AUTHORISED FOR PUBLICATION INGA CONDRIC AUTHORISED 15/04/2014	DESIGN	FORMZOO DESIGN	DATE	JUN '12




<b>BRISBANE CITY COUNC</b>	IL STANDARD DRAWING
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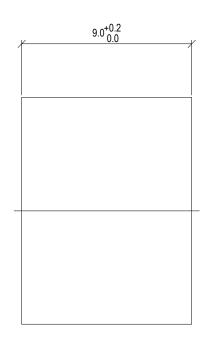
DRINKING FOUNTAIN ACTUATOR ARM BUSH SHEET 12 OF 27


"	DAILD DI	ATTITO
	SCALE 5:	1
	DWG No.	
	BSD-	7331
	ORIGINAL SIZE	REVISION
	Α3	D

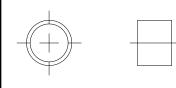

ACTUAL SIZE SCALE 1:1



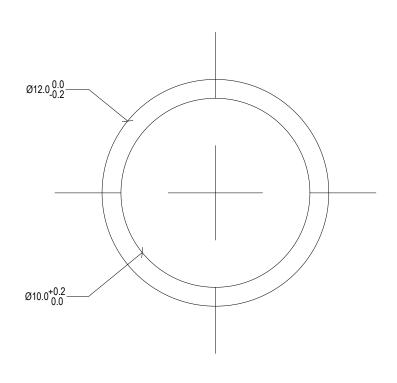

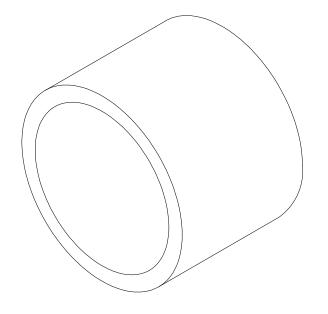

FRONT VIEW SIDE VIEW PICTORIAL VIEW

### **STANDARDS**

DESIGNED IN ACCORDANCE WITH, AND FABRICATION TO MEET THE FOLLOWING STANDARDS:

- AS1428.4.1:2009, TACTILE GROUND SURFACE INDICATORS FOR THE ORIENTATION OF PEOPLE WITH VISION IMPAIRMENT.
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- 7. AS4680:2006, HOT DIP GALVANISING.

### **NOTES**


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- 4. DRAWING TO AS1100 DRAWING STANDARDS.
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- 2. COLOUR: NATURAL
- 3. FINISH: DEBURRED

STRUCTURAL DESIGN REVIEWED AND				
CERTIFIED FOR ISSUE				
NAME: B.C. PLANT	RPEQ: <u>8807</u>			
SIGNATURE: ON ORIGINAL	DATE: 10/ 05/ 18			

ISSUE	AMENDMENT	DRAWN DATE	CHK'D DATE	APPR'D DATE	PRINCIPAL PLANNING URBAN DESIG
Α	Drawing Converted from UMS Series April 2014	APR '14	APR '14	APR '14	VICKI MARTIN SIGNATURE
В	Water bottle refill addition	JAN '15	JAN '15	JAN '15	DESIGN APPRO
С	Drawing Title Amended	FEB '16	JUL '16	JUL '16	ASSET ENGINEERING I STRATEGIC ASSET MAI
D	Dog Bowl Addition	MAY '18	JUN '18	NOV '18	INGA CONDRIC AUTHORISE
					DRAWING AUTHORISED FO




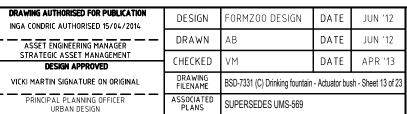



### **BRISBANE CITY COUNCIL STANDARD DRAWING**

DRINKING FOUNTAIN ACTUATOR BUSH SHEET13 OF 27

''	DAILD DIV	
	SCALE 5	:1
	DWG No.	
	BSD-	7331
	ORIGINAL SIZE	REVISION
	Α3	D

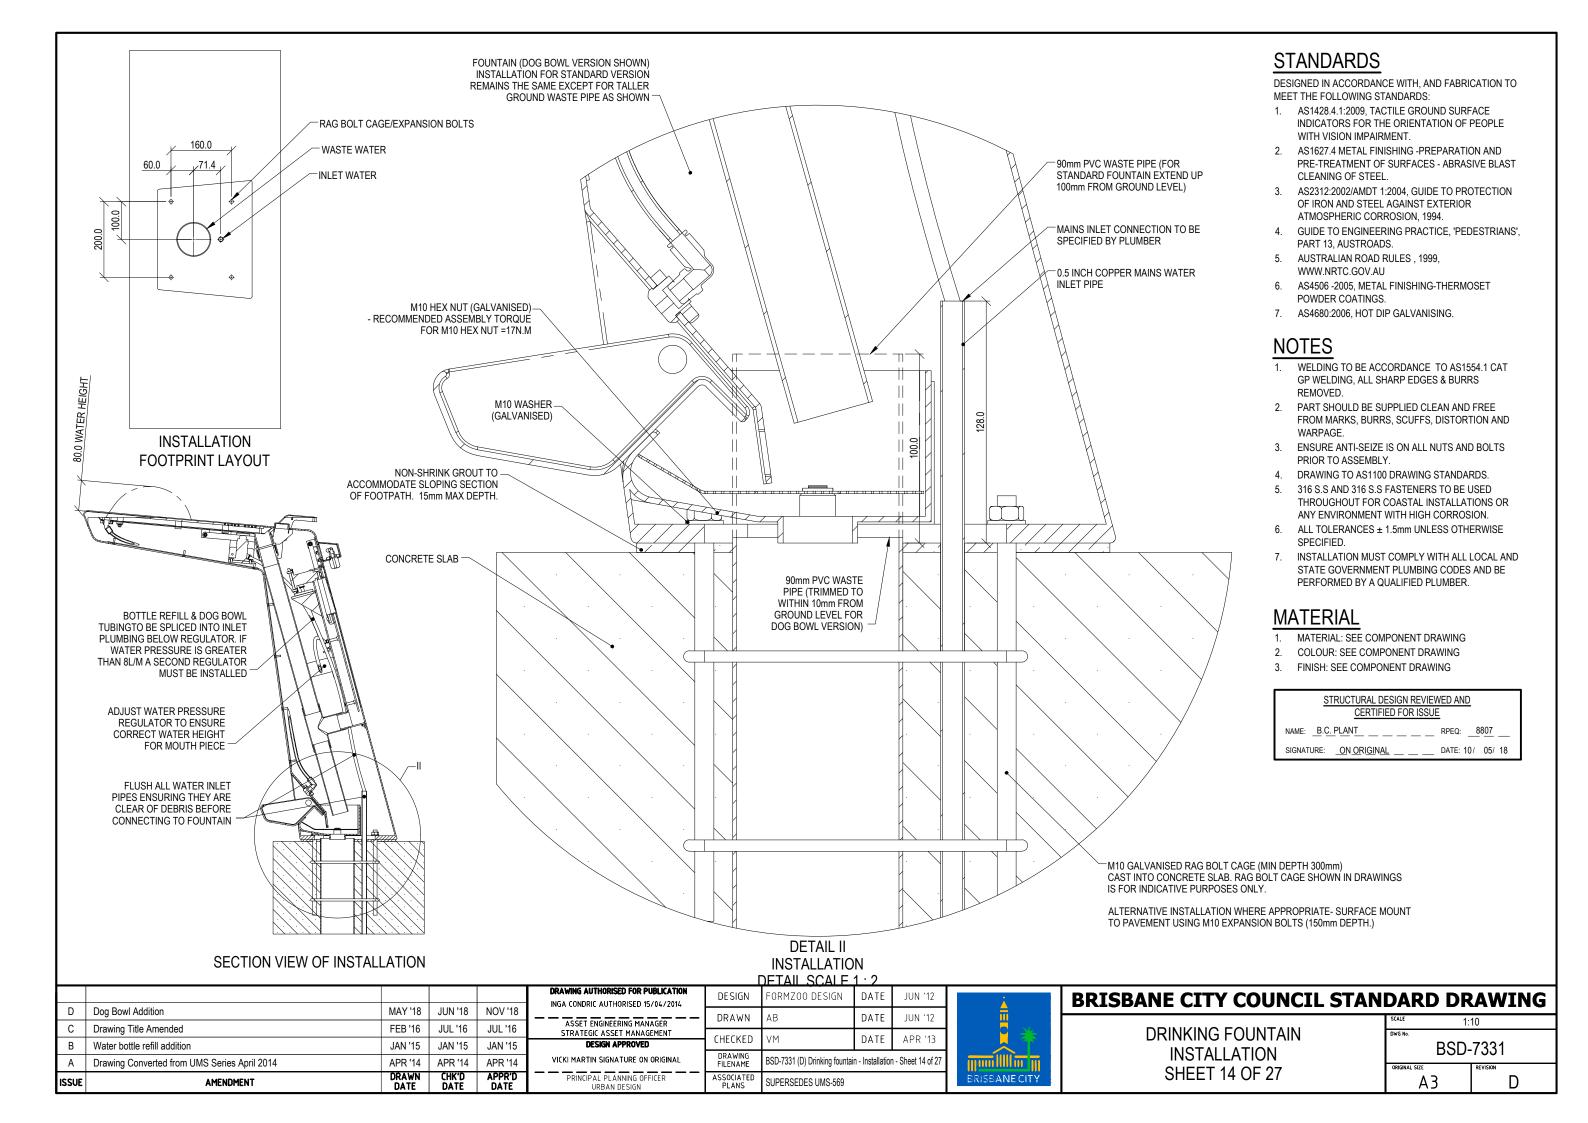

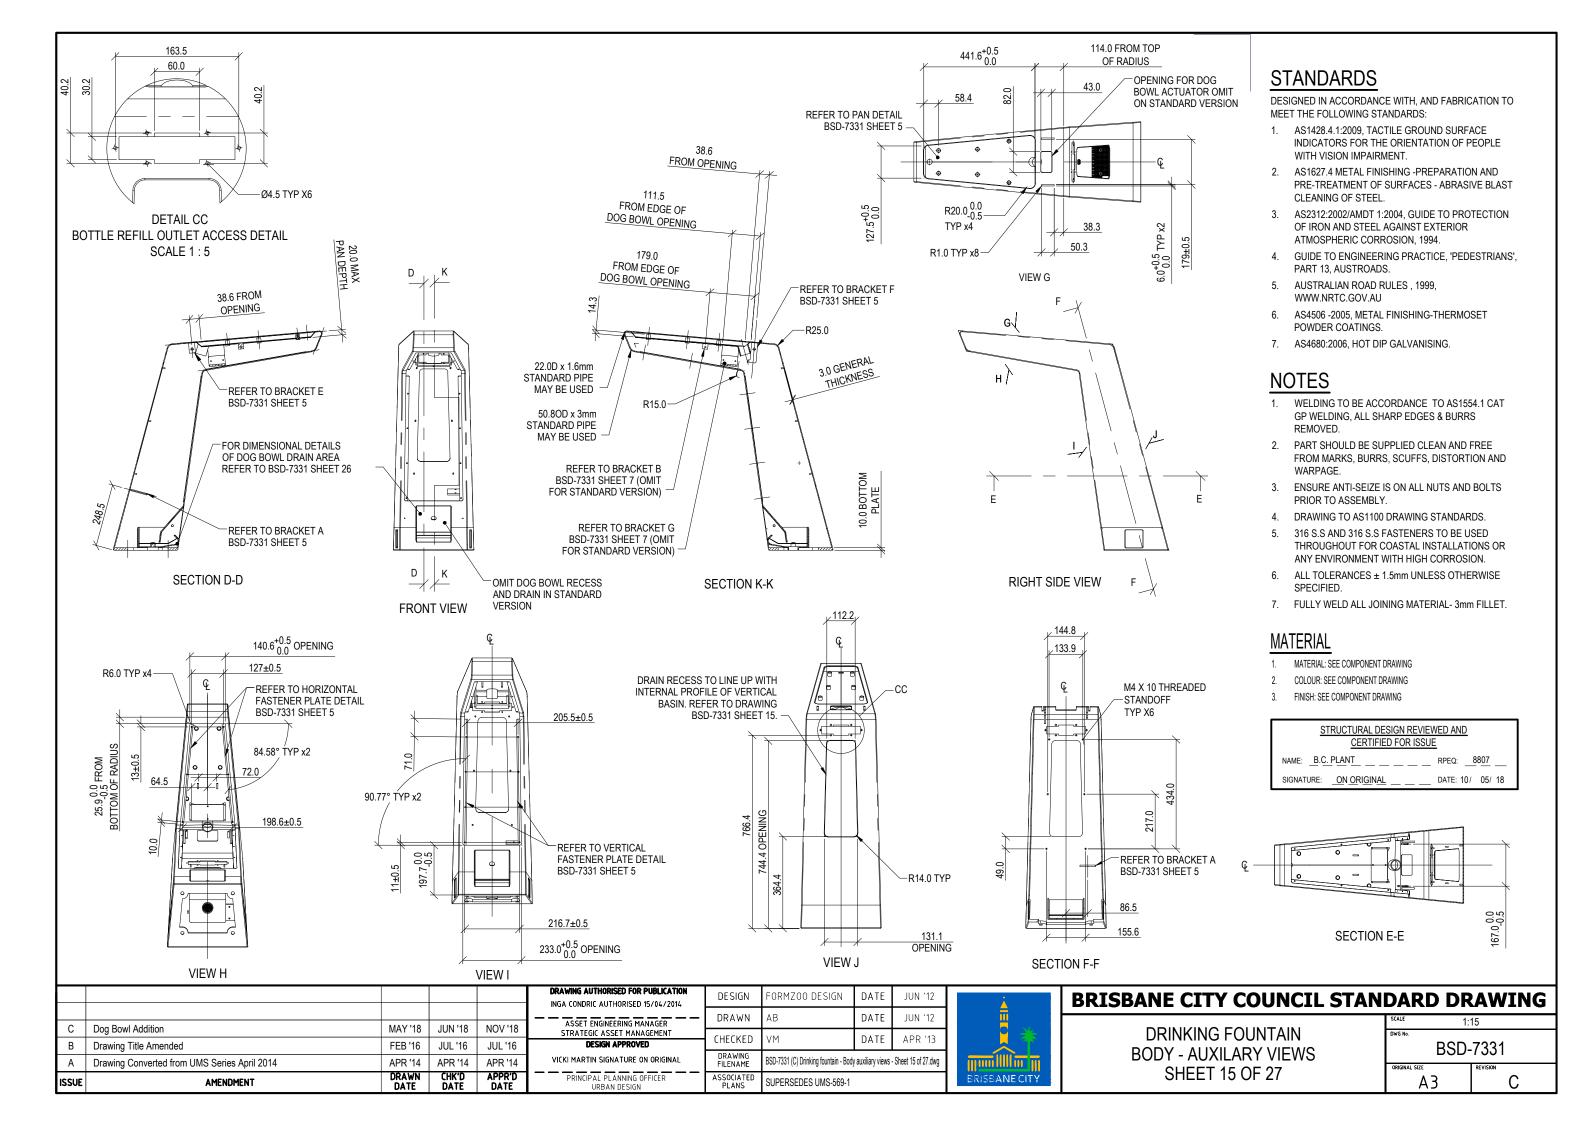

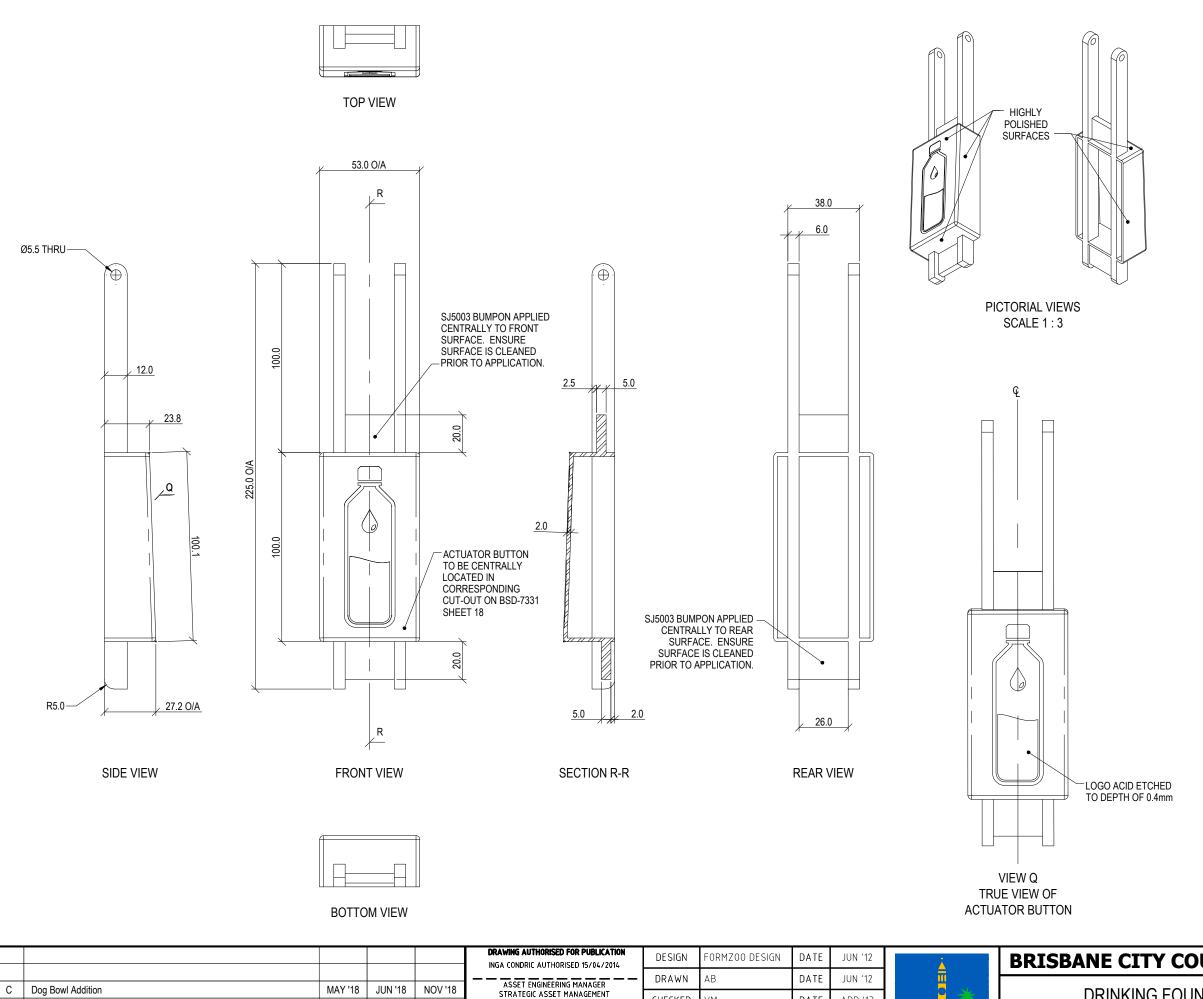

CHECKED

DRAWING FILENAME

DESIGN APPROVED

VICKI MARTIN SIGNATURE ON ORIGINAL

PRINCIPAL PLANNING OFFICER URBAN DESIGN

Drawing Title Amended

ISSUE

Drawing Converted from UMS Series April 2014

**AMENDMENT** 

FEB '16

APR '14

DRAWN

JUL '16

APR '14

JUL '16

APR '14

APPR'D

# **STANDARDS**

DESIGNED IN ACCORDANCE WITH, AND FABRICATION TO MEET THE FOLLOWING STANDARDS:

- 1. AS1428.4.1:2009, TACTILE GROUND SURFACE INDICATORS FOR THE ORIENTATION OF PEOPLE WITH VISION IMPAIRMENT.
- AS1627.4 METAL FINISHING -PREPARATION AND PRE-TREATMENT OF SURFACES - ABRASIVE BLAST CLEANING OF STEEL.
- 3. AS2312:2002/AMDT 1:2004, GUIDE TO PROTECTION OF IRON AND STEEL AGAINST EXTERIOR ATMOSPHERIC CORROSION, 1994.
- GUIDE TO ENGINEERING PRACTICE, 'PEDESTRIANS', PART 13, AUSTROADS.
- AUSTRALIAN ROAD RULES, 1999, WWW.NRTC.GOV.AU
- AS4506 -2005, METAL FINISHING-THERMOSET POWDER COATINGS.
- AS4680:2006, HOT DIP GALVANISING.

#### **NOTES**

- WELDING TO BE ACCORDANCE TO AS1554.1 CAT GP WELDING, ALL SHARP EDGES & BURRS
- PART SHOULD BE SUPPLIED CLEAN AND FREE FROM MARKS, BURRS, SCUFFS, DISTORTION AND WARPAGE.
- ENSURE ANTI-SEIZE IS ON ALL NUTS AND BOLTS PRIOR TO ASSEMBLY.
- DRAWING TO AS1100 DRAWING STANDARDS.
- 316 S.S AND 316 S.S FASTENERS TO BE USED THROUGHOUT FOR COASTAL INSTALLATIONS OR ANY ENVIRONMENT WITH HIGH CORROSION.
- ALL TOLERANCES ± 0.5mm UNLESS OTHERWISE

#### **MATERIAL**

- MATERIAL: 316 STAINLESS STEEL
- 2. COLOUR: NATURAL
- FINISH: HIGHLY POLISHED (BUTTON SURFACE ONLY).

STRUCTURAL DESIGN REVIEWED AND CERTIFIED FOR ISSUE			
NAME: B.C. PLANT RPEQ:8807			
SIGNATURE: ON ORIGINAL	DATE: 10/ 05/ 18		
SIGNATURE: ON ORIGINAL	DATE: 10 / 05 / 18		

<b>BRISBANE CITY COUNC</b>	IL STANDARD DRAWING
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**DRINKING FOUNTAIN BOTTLE REFILL ACTUATOR SHEET 16 OF 27** 

APR '13


RISBANE CITY

DATE

BSD-7331 (C) Drinking fountain - Bottle refill actuator - Sheet 16 of 27

SUPERSEDES UMS-569

SCALE	1.2
DWG No.	
	D 7004
l BS	D-7331
ORIGINAL SIZE	REVISION
۸ ٦	
ר	U

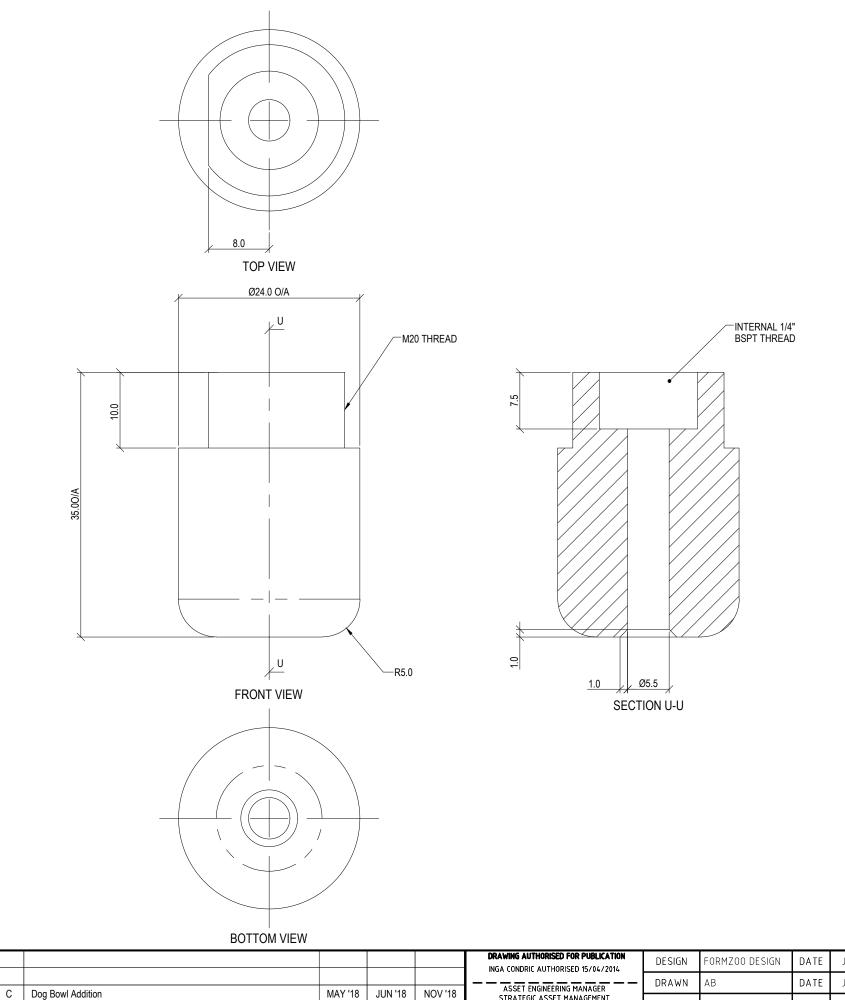

FEB '16

APR '14

DRAWN DATE JUL '16

APR '14

JUL '16

APR '14

APPR'D

Drawing Title Amended

ISSUE

Drawing Converted from UMS Series April 2014

**AMENDMENT** 

# STANDARDS

DESIGNED IN ACCORDANCE WITH, AND FABRICATION TO MEET THE FOLLOWING STANDARDS:

- AS1428.4.1:2009, TACTILE GROUND SURFACE INDICATORS FOR THE ORIENTATION OF PEOPLE WITH VISION IMPAIRMENT.
- AS1627.4 METAL FINISHING -PREPARATION AND PRE-TREATMENT OF SURFACES - ABRASIVE BLAST CLEANING OF STEEL.
- AS2312:2002/AMDT 1:2004, GUIDE TO PROTECTION OF IRON AND STEEL AGAINST EXTERIOR ATMOSPHERIC CORROSION, 1994.
- GUIDE TO ENGINEERING PRACTICE, 'PEDESTRIANS', PART 13, AUSTROADS.
- 5. AUSTRALIAN ROAD RULES , 1999, WWW.NRTC.GOV.AU
- AS4506 -2005, METAL FINISHING-THERMOSET POWDER COATINGS.
- 7. AS4680:2006, HOT DIP GALVANISING.

#### **NOTES**

- I. WELDING TO BE ACCORDANCE TO AS1554.1 CAT GP WELDING, ALL SHARP EDGES & BURRS REMOVED
- PART SHOULD BE SUPPLIED CLEAN AND FREE FROM MARKS, BURRS, SCUFFS, DISTORTION AND WARPAGE.
- 3. ENSURE ANTI-SEIZE IS ON ALL NUTS AND BOLTS PRIOR TO ASSEMBLY.
- 4. DRAWING TO AS1100 DRAWING STANDARDS.
- 316 S.S AND 316 S.S FASTENERS TO BE USED THROUGHOUT FOR COASTAL INSTALLATIONS OR ANY ENVIRONMENT WITH HIGH CORROSION.
- 6. ALL TOLERANCES ± 0.5mm UNLESS OTHERWISE SPECIFIED

#### **MATERIAL**

- 1. MATERIAL: 316 STAINLESS STEEL
- 2. COLOUR: NATURAL
- 3. FINISH: 600 GRIT POLISHED



# **BRISBANE CITY COUNCIL STANDARD DRAWING**

DRINKING FOUNTAIN BOTTLE REFILL OUTLET SHEET 17 OF 27

•	DAILD DIGHTING		
	SCALE 2	:1	
	DWG No.		
	BSD-	7331	
	ORIGINAL SIZE	REVISION	
	Α3	С	

DRAWING AUTHORISED FOR PUBLICATION
INGA CONDRIC AUTHORISED 15/04/2014

ASSET ENGINEERING MANAGER
STRATEGIC ASSET MANAGEMENT

DESIGN APPROVED
VICKI MARTIN SIGNATURE ON ORIGINAL
PRINCIPAL PLANNING OFFICER
URBAN DESIGN

DESIGN FORMZOO DESIGN
DATE
JUN '12


CHECKED VM
DATE APR '13


DRAWING
FILENAME
BSD-7331 (C) Drinking fountain - Bottle refill outlet - Sheet 17 of 27.dwg
PRINCIPAL PLANNING OFFICER
URBAN DESIGN


SUPERSEDES UMS-569-1

ERISBANE CITY

PICTORIAL VIEW

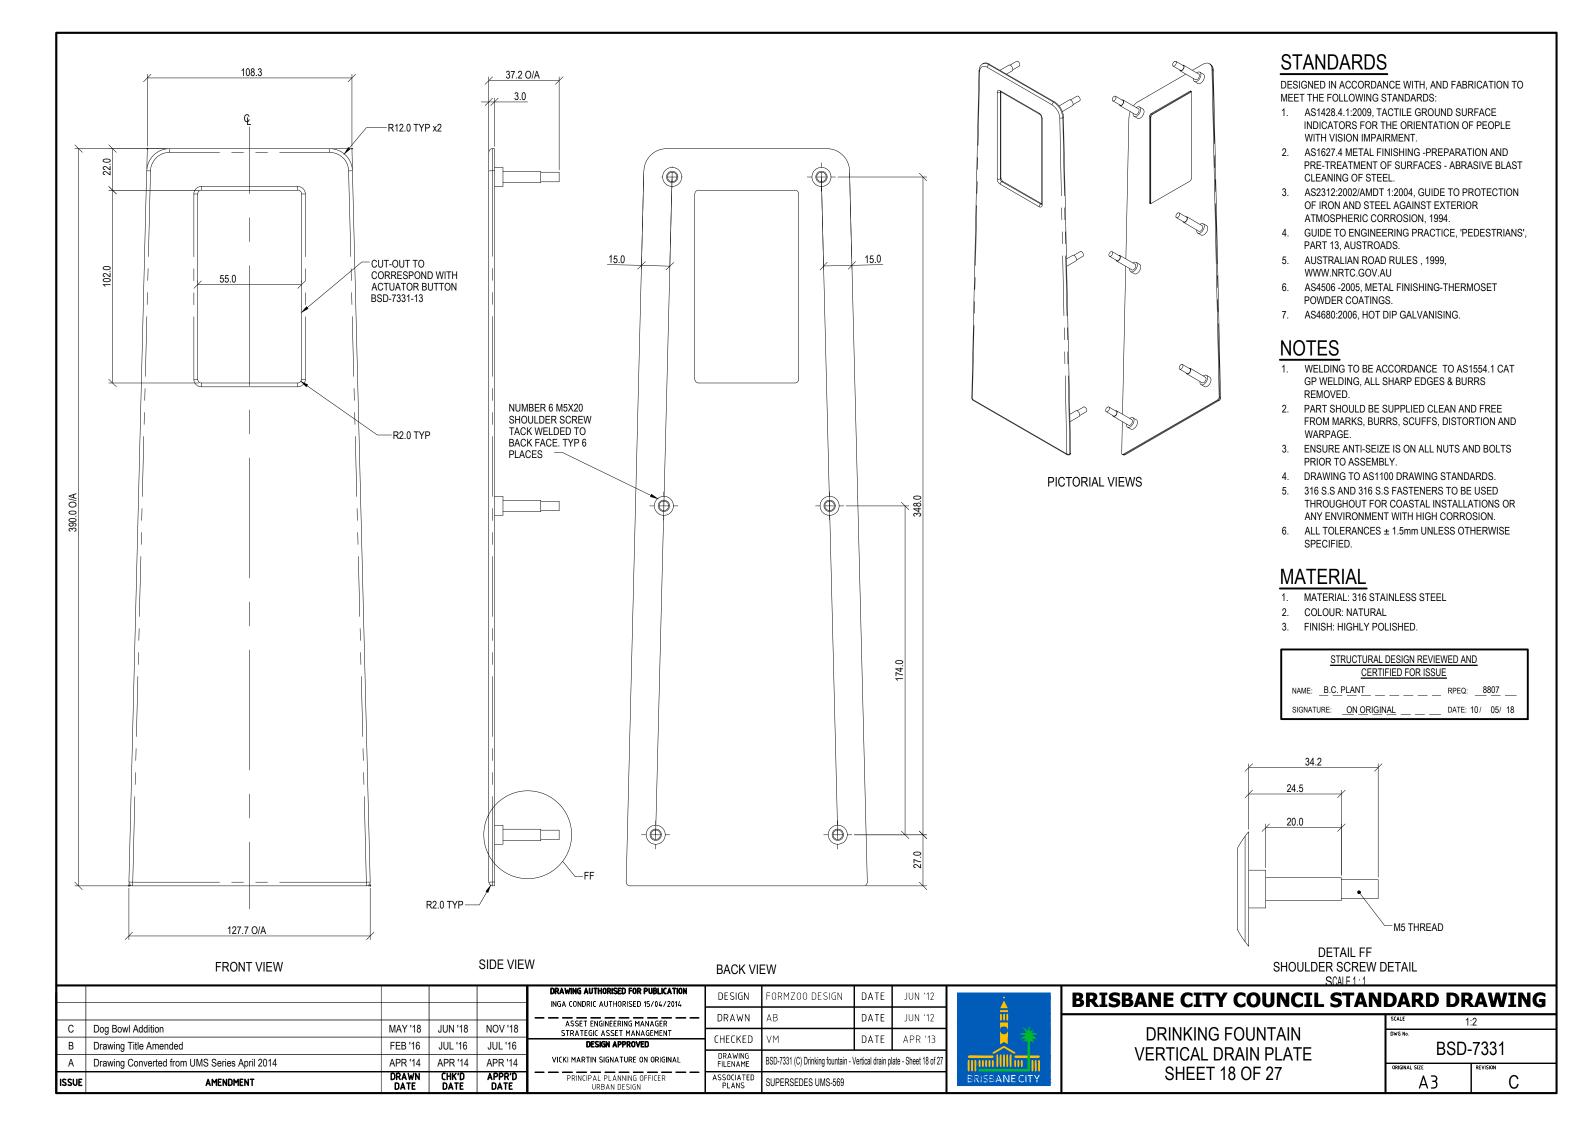

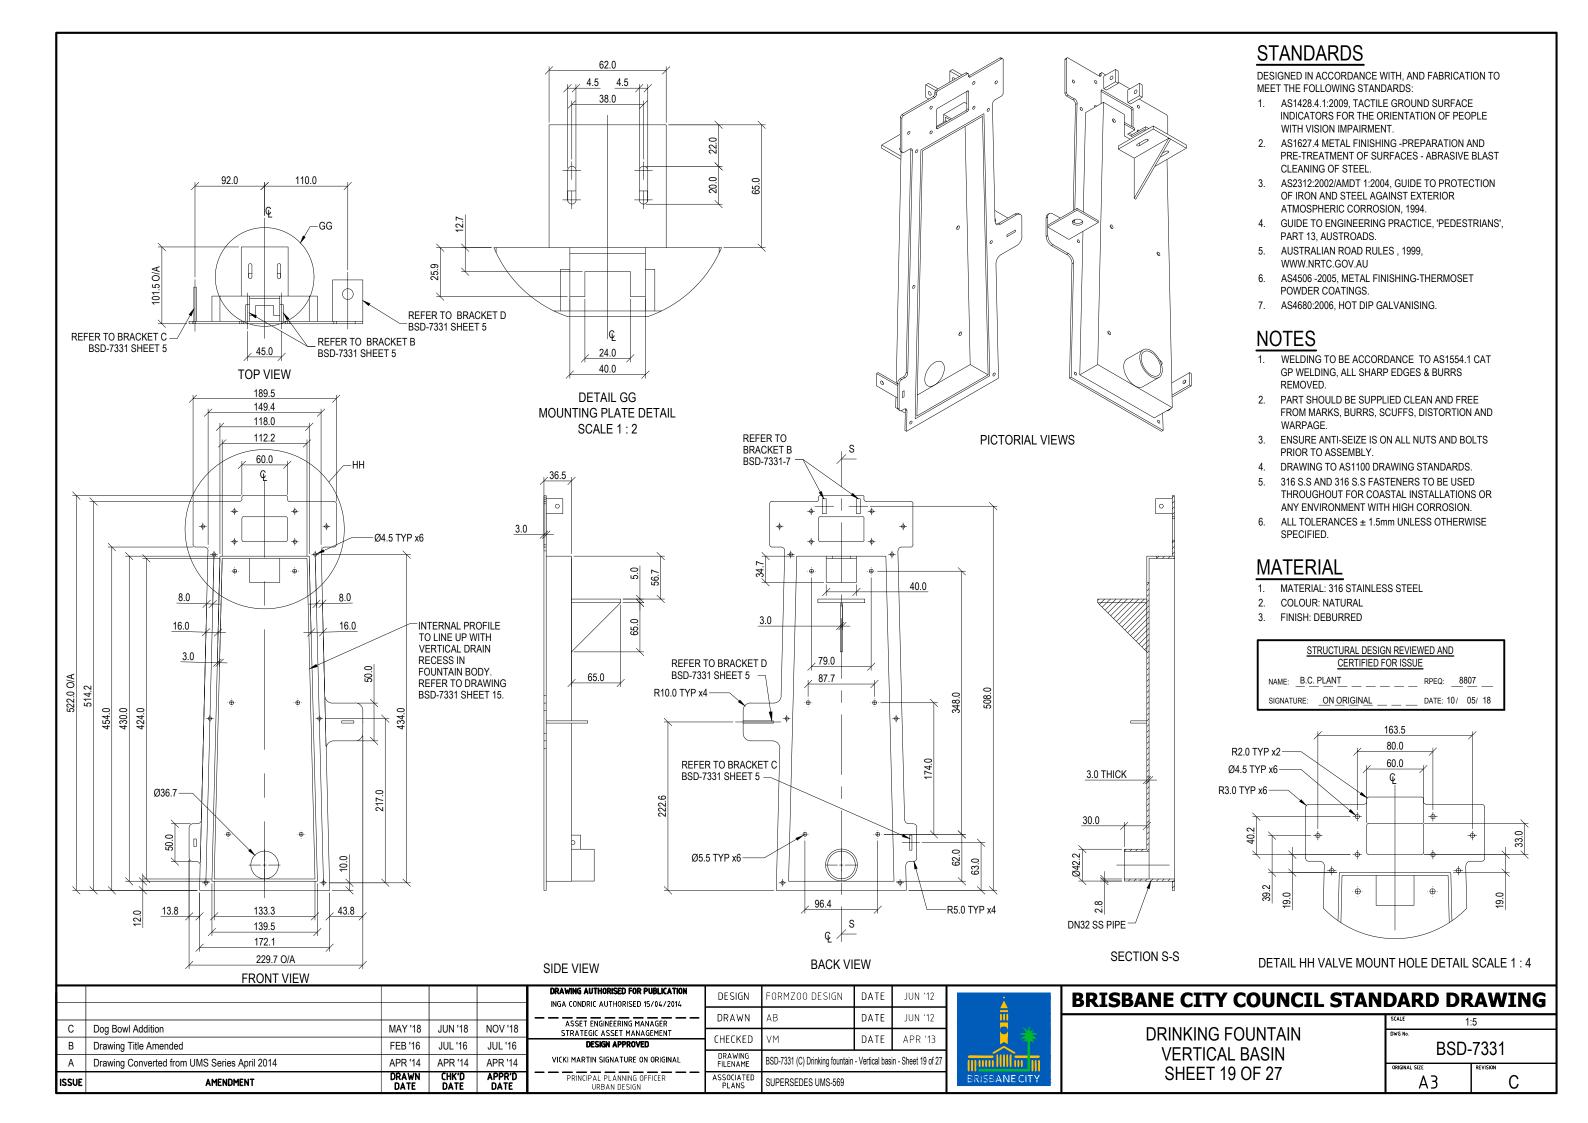

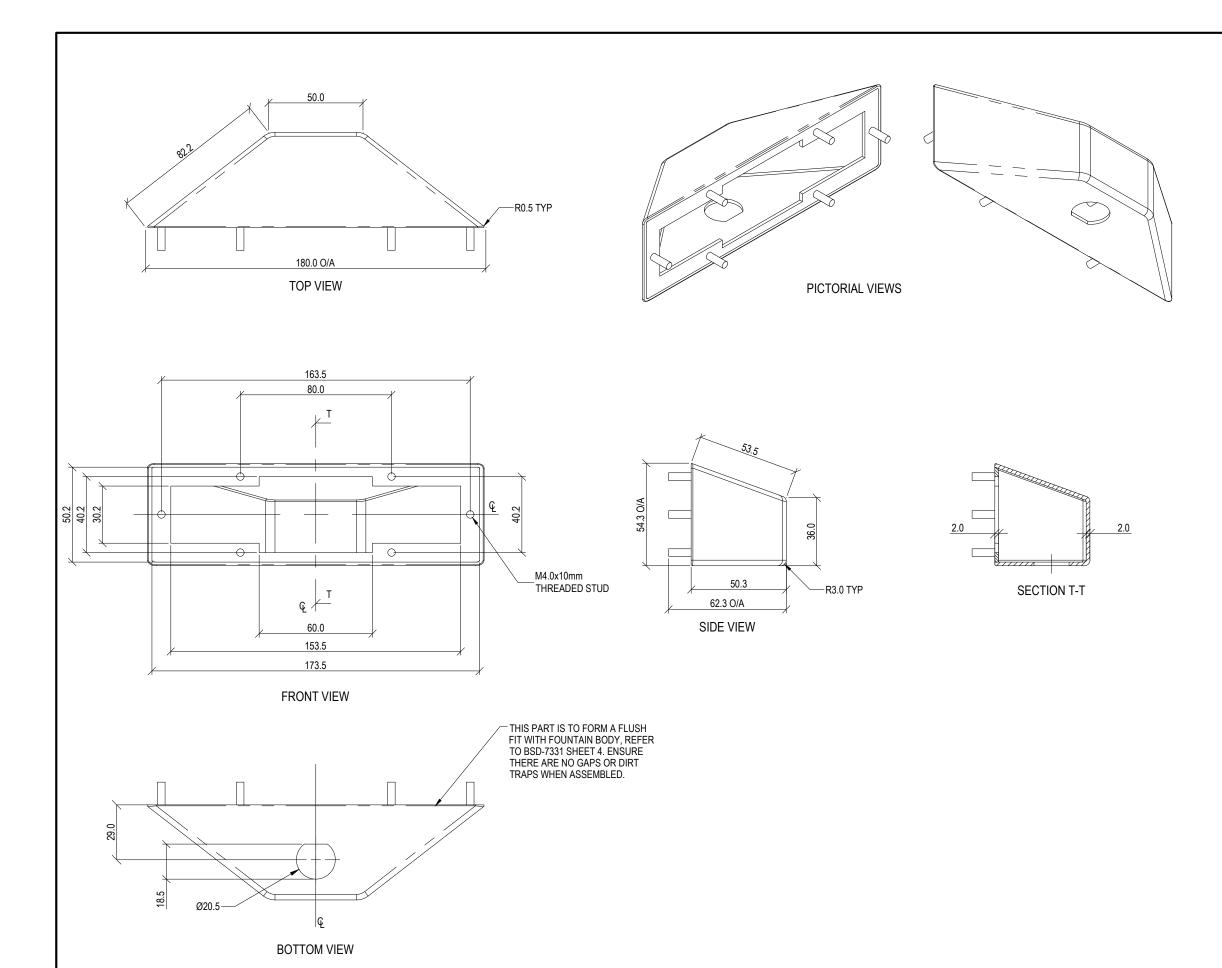

# STANDARDS

DESIGNED IN ACCORDANCE WITH, AND FABRICATION TO MEET THE FOLLOWING STANDARDS:

- AS1428.4.1:2009, TACTILE GROUND SURFACE INDICATORS FOR THE ORIENTATION OF PEOPLE WITH VISION IMPAIRMENT.
- AS1627.4 METAL FINISHING -PREPARATION AND PRE-TREATMENT OF SURFACES - ABRASIVE BLAST CLEANING OF STEEL.
- AS2312:2002/AMDT 1:2004, GUIDE TO PROTECTION OF IRON AND STEEL AGAINST EXTERIOR ATMOSPHERIC CORROSION, 1994.
- GUIDE TO ENGINEERING PRACTICE, 'PEDESTRIANS', PART 13, AUSTROADS.
- 5. AUSTRALIAN ROAD RULES , 1999, WWW.NRTC.GOV.AU
- 6. AS4506 -2005, METAL FINISHING-THERMOSET POWDER COATINGS.
- 7. AS4680:2006, HOT DIP GALVANISING.

# NOTES

- WELDING TO BE ACCORDANCE TO AS1554.1 CAT GP WELDING, ALL SHARP EDGES & BURRS REMOVED.
- PART SHOULD BE SUPPLIED CLEAN AND FREE FROM MARKS, BURRS, SCUFFS, DISTORTION AND WARPAGE.
- 3. ENSURE ANTI-SEIZE IS ON ALL NUTS AND BOLTS PRIOR TO ASSEMBLY.
- 4. DRAWING TO AS1100 DRAWING STANDARDS.
- 5. 316 S.S AND 316 S.S FASTENERS TO BE USED THROUGHOUT FOR COASTAL INSTALLATIONS OR ANY ENVIRONMENT WITH HIGH CORROSION.
- 6. ALL TOLERANCES ± 0.5mm UNLESS OTHERWISE SPECIFIED

# **MATERIAL**

- 1. MATERIAL: 316 STAINLESS STEEL
- 2. COLOUR: NATURAL
- 3. FINISH: 600 GRIT POLISH

STRUCTURAL DESIGN REVIEWED AND		
CERTIFIED FOR ISSUE		
NAME: B.C. PLANT	RPEQ:88 <u>07</u>	
SIGNATURE: ON ORIGINAL	DATE: 10 / 05 / 18	

ISSUE	AMENDMENT	DRAWN DATE	CHK'D DATE	APPR'D DATE	PRINCIPAL PLANNING OFFICER URBAN DESIGN	ASSOCIATED PLANS	ĺ
Α	Drawing Converted from UMS Series April 2014	APR '14	APR '14	APR '14	VICKI MARTIN SIGNATURE ON ORIGINAL	DRAWING FILENAME	١
В	Drawing Title Amended	FEB '16	JUL '16	JUL '16	DESIGN APPROVED	CHECKED	ļ
С	Dog Bowl Addition	MAY '18	JUN '18	NOV '18	STRATEGIC ASSET MANAGEMENT	CHECKED	t
					ASSET ENGINEERING MANAGER	DRAWN	ĺ
					DRAWING AUTHORISED FOR PUBLICATION INGA CONDRIC AUTHORISED 15/04/2014	DESIGN	١



FORMZOO DESIGN

SUPERSEDES UMS-569

DATE

DATE

DATE

BSD-7331 (C) Drinking fountain - Valve mount - Sheet 20 of 27

JUN '12


JUN '12


APR '13

# **BRISBANE CITY COUNCIL STANDARD DRAWING**


DRINKING FOUNTAIN VALVE MOUNT SHEET 20 OF 27


DAILD DICAMING			
scale 1:2			
DWG No.			
BSD-7331			
ORIGINAL SIZE	REVISION		
A3	С		

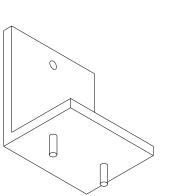


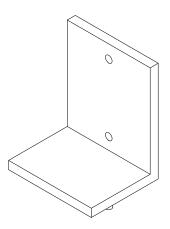

PICTORIAL VIEWS

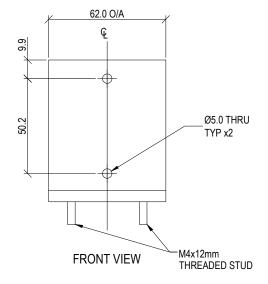

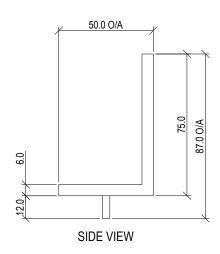

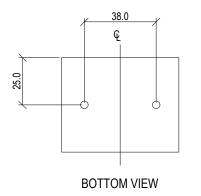

#### DRAWING AUTHORISED FOR PUBLICATION DESIGN FORMZOO DESIGN DATE JUN '12 INGA CONDRIC AUTHORISED 15/04/2014 DRAWN DATE JUN '12 ASSET ENGINEERING MANAGER C Dog Bowl Addition MAY '18 JUN '18 NOV '18 STRATEGIC ASSET MANAGEMENT CHECKED APR '13 DATE Drawing Title Amended FEB '16 JUL '16 JUL '16 DESIGN APPROVED DRAWING FILENAME VICKI MARTIN SIGNATURE ON ORIGINAL BSD-7331 (C) Drinking fountain - Valve mount - Sheet 21 of 27 Drawing Converted from UMS Series April 2014 APR '14 APR '14 APR '14 PRINCIPAL PLANNING OFFICER URBAN DESIGN DRAWN DATE APPR'D ISSUE **AMENDMENT** SUPERSEDES UMS-569



# STANDARDS

DESIGNED IN ACCORDANCE WITH, AND FABRICATION TO MEET THE FOLLOWING STANDARDS:

- AS1428.4.1:2009, TACTILE GROUND SURFACE INDICATORS FOR THE ORIENTATION OF PEOPLE WITH VISION IMPAIRMENT.
- AS1627.4 METAL FINISHING -PREPARATION AND PRE-TREATMENT OF SURFACES - ABRASIVE BLAST CLEANING OF STEEL.
- . AS2312:2002/AMDT 1:2004, GUIDE TO PROTECTION OF IRON AND STEEL AGAINST EXTERIOR ATMOSPHERIC CORROSION, 1994.
- GUIDE TO ENGINEERING PRACTICE, 'PEDESTRIANS', PART 13, AUSTROADS.
- 5. AUSTRALIAN ROAD RULES , 1999, WWW.NRTC.GOV.AU
- 6. AS4506 -2005, METAL FINISHING-THERMOSET POWDER COATINGS.
- 7. AS4680:2006, HOT DIP GALVANISING.

# NOTES

- WELDING TO BE ACCORDANCE TO AS1554.1 CAT GP WELDING, ALL SHARP EDGES & BURRS REMOVED.
- PART SHOULD BE SUPPLIED CLEAN AND FREE FROM MARKS, BURRS, SCUFFS, DISTORTION AND WARPAGE.
- 3. ENSURE ANTI-SEIZE IS ON ALL NUTS AND BOLTS PRIOR TO ASSEMBLY.
- 4. DRAWING TO AS1100 DRAWING STANDARDS.
- 5. 316 S.S AND 316 S.S FASTENERS TO BE USED THROUGHOUT FOR COASTAL INSTALLATIONS OR ANY ENVIRONMENT WITH HIGH CORROSION.
- 6. ALL TOLERANCES ± 0.5mm UNLESS OTHERWISE SPECIFIED.

#### **MATERIAL**


- 1. MATERIAL: 316 STAINLESS STEEL
- 2. COLOUR: NATURAL
- 3. FINISH: DEBURRED


1	STRUCTURAL DESIGN REVIEWED AND		
- 1	CERTIFIED FOR ISSUE	ı	
1	NAME: <u>B.C. PLANT</u> RPEQ: <u>8807</u>	l	
1	SIGNATURE: ON ORIGINAL DATE: 10/ 05/ 18	l	

# **BRISBANE CITY COUNCIL STANDARD DRAWING**

DRINKING FOUNTAIN VALVE MOUNT SHEET 21 OF 27

SCALE	1:2
DWG No.	
BSD	-7331
ORIGINAL SIZE	REVISION
Δ3	

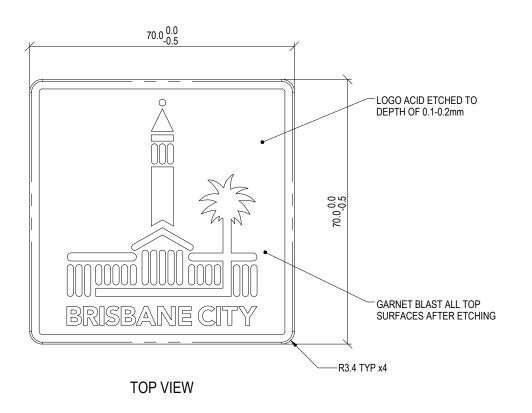

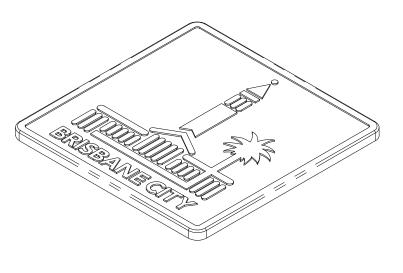

PICTORIAL VIEW



FRONT VIEW

#### D Dog Bowl Addition MAY '18 JUN '18 NOV '18 Logo Badge Etch Depth Amended MAY '17 MAY '17 MAY '17 Drawing Title Amended FEB '16 JUL '16 JUL '16 Drawing Converted from UMS Series April 2014 APR '14 APR '14 APR '14 APPR'D DATE DRAWN DATE ISSUE **AMENDMENT**

DRAWING AUTHORISED FOR PUBLICATION INGA CONDRIC AUTHORISED 15/04/2014	DESIGN	FORMZOO DESIGN	DATE	JUN '12
ASSET ENGINEERING MANAGER	DRAWN	АВ	DATE	JUN '12
STRATEGIC ASSET MANAGEMENT	CHECKED	VM	DATE	APR '13
DESIGN APPROVED	CHECKED	VII	DKIL	AFK ID
VICKI MARTIN SIGNATURE ON ORIGINAL	DRAWING FILENAME	BSD-7331 (D) Drinking fountain	- Logo badge	e - Sheet 22 of 27
PRINCIPAL PLANNING OFFICER URBAN DESIGN	ASSOCIATED PLANS	SUPERSEDES UMS-569		



# STANDARDS

DESIGNED IN ACCORDANCE WITH, AND FABRICATION TO MEET THE FOLLOWING STANDARDS:

- AS1428.4.1:2009, TACTILE GROUND SURFACE INDICATORS FOR THE ORIENTATION OF PEOPLE WITH VISION IMPAIRMENT.
- AS1627.4 METAL FINISHING -PREPARATION AND PRE-TREATMENT OF SURFACES - ABRASIVE BLAST CLEANING OF STEEL.
- AS2312:2002/AMDT 1:2004, GUIDE TO PROTECTION OF IRON AND STEEL AGAINST EXTERIOR ATMOSPHERIC CORROSION, 1994.
- GUIDE TO ENGINEERING PRACTICE, 'PEDESTRIANS', PART 13, AUSTROADS.
- 5. AUSTRALIAN ROAD RULES , 1999, WWW.NRTC.GOV.AU
- 6. AS4506 -2005, METAL FINISHING-THERMOSET POWDER COATINGS.
- 7. AS4680:2006, HOT DIP GALVANISING.

# **NOTES**

- WELDING TO BE ACCORDANCE TO AS1554.1 CAT GP WELDING, ALL SHARP EDGES & BURRS REMOVED.
- PART SHOULD BE SUPPLIED CLEAN AND FREE FROM MARKS, BURRS, SCUFFS, DISTORTION AND WARPAGE.
- 3. ENSURE ANTI-SEIZE IS ON ALL NUTS AND BOLTS PRIOR TO ASSEMBLY.
- 4. DRAWING TO AS1100 DRAWING STANDARDS.
- 5. 316 S.S AND 316 S.S FASTENERS TO BE USED THROUGHOUT FOR COASTAL INSTALLATIONS OR ANY ENVIRONMENT WITH HIGH CORROSION.
- ALL TOLERANCES ± 1.5mm UNLESS OTHERWISE SPECIFIED.

# **MATERIAL**

- 1. MATERIAL: 316 STAINLESS STEEL
- 2. COLOUR: NATURAL
- 3. FINISH: GARNET BLASTED

STRUCTURAL DESIGN REVIEWED AND			
CERTIFIED FOR ISSUE			
NAME: B.C. PLANT RPEQ: 8807			
SIGNATURE: ON ORIGINAL	DATE: 10/ 05/ 18		

# **BRISBANE CITY COUNCIL STANDARD DRAWING**

DRINKING FOUNTAIN LOGO BADGE SHEET 22 OF 27

SCALE	1:1
DWG No.	
	D 7004
I BS	D-7331
ORIGINAL SIZE	REVISION
Λ 🤉	
1 A)	1 0

		WITH DOG BOWL	STANDARD
ITEM NO.	DESCRIPTION	QTY.	QTY.
1	Drinking Fountain Body	1	1
2	Drinking Fountain Access Panel	1	1
3	Drinking Fountain Top Plate	1	1
4	Drinking Fountain Logo Badge	2	2
5	Drinking Fountain Actuator	1	1
6	Drinking Fountain Actuator Arm	1	1
7	Drinking Fountain Mouth Piece	1	1
8	Drinking Fountain Actuator Arm Bush	1	1
9	Drinking Fountain Actuator Bush	2	2
10	Drinking Fountain Vertical Drain Plate	1	1
11	Drinking Fountain Bottle Refill Actuator	1	1
12	Drinking Fountain Bottle Refill Body	1	1
13	Drinking Fountain Vertical Basin	1	1
14	Drinking Fountain Bottle Refill Outlet	1	1
15	Drinking Fountain Valve Mount	1	1
16	Return Spring to Suit	1	1
17	3M Bumpon SJ5003	2	2
18	M4x16 304 Stainless Steel CSK Phillips Head Screw	14	14
19	M4 304 Stainless Steel Internal Tooth Washer	2	2
20	M4 304 Stainless Steel Nyloc Nut	14	14
21	M5x20 304 Stanless Steel Pan Phillips Head Screw	6	4
22	M5 304 Stainless Steel Washer	16	12
23	M5 304 Stainless Steel Spring Washer	5	5
24	M5 304 Stainless Steel Hex Nut	4	4
25	M5 304 Stainless Steel Nyloc Nut	11	9
26	M8 304 Stainless Steel Washer	6	4
27	M10x30 304 Stainless Steel Hex Bolt	2	2
28	M10 304 Stainless Steel Washer	6	6
29	M10 304 Stainless Steel Hex Nut	6	6
30	M20 304 Stainless Steel Half Nut	3	2
31	Dog Bowl Actuator	1	0
32	Dog Bowl	2	0
33	Dog Bowl Fill Nozzle	1	0
34	M8 x 16 304 Stainless Steel Hex Bolt	2	0

# DRINKING FOUNTAIN ASSEMBLY BOM REFER TO BSD-7331 SHEET 2 FOR EXPLODED VIEW

ITEM NO.	DESCRIPTION	QTY.	QTY.
1	Drinking Fountain	1	1
2	Drinking Fountain Access Panel	1	1
3	Drinking Fountain Valve Mount	1	1
4	Drinking Fountain Mouth Piece	1	1
5	Drinking Fountain Bottle Refill Outlet	1	1
6	40mm Female Iron Connector	1	1
7	40mm Male Iron Connector	1	1
8	40mm PVC Pipe	2	2
9	Water Flow Valve 1KG Spring Force	3	2
10	Water Flow Regulator	1	1
11	Legris 45° Connector	2	2
12	Legris 90° Connector	2	1
13	John Guest Polyethylene Tubing (a)	1	1
14	John Guest Polyethylene Tubing (b)	1	1
15	John Guest Polyethylene Tubing (c)	1	1
16	John Guest Polyethylene Tubing (d)	1	1
17	John Guest Polyethylene Tubing (e)	1	1
18	M4 304 Stainless Steel Internal Tooth Washer	2	2
19	M4 304 Stainless Steel Nyloc Nut	2	2
20	M5x16mm 304 Stainless Steel CSK Phillips Head Screw	6	4
21	M20 304 Stainless Steel Half Nut	3	2
22	40mm PVC Tee Piece	1	1
47	Dog Bowl Valve Mount	1	0
51	Dog Bowl Fill Nozzle	1	0
52	John Guest Polyethylene Tubing (f)	1	0
53	John Guest Polyethylene Tubing (g)	1	0

DRINKING FOUNTAIN
PLUMBING BOM
REFER TO BSD-7331 SHEET 3
FOR EXPLODED VIEW

# **STANDARDS**

DESIGNED IN ACCORDANCE WITH, AND FABRICATION TO MEET THE FOLLOWING STANDARDS:

- AS1428.4.1:2009, TACTILE GROUND SURFACE INDICATORS FOR THE ORIENTATION OF PEOPLE WITH VISION IMPAIRMENT.
- AS1627.4 METAL FINISHING -PREPARATION AND PRE-TREATMENT OF SURFACES - ABRASIVE BLAST CLEANING OF STEEL.
- 3. AS2312:2002/AMDT 1:2004, GUIDE TO PROTECTION OF IRON AND STEEL AGAINST EXTERIOR ATMOSPHERIC CORROSION, 1994.
- GUIDE TO ENGINEERING PRACTICE, 'PEDESTRIANS', PART 13, AUSTROADS.
- 5. AUSTRALIAN ROAD RULES , 1999, WWW.NRTC.GOV.AU
- 6. AS4506 -2005, METAL FINISHING-THERMOSET POWDER COATINGS.
- 7. AS4680:2006, HOT DIP GALVANISING.

#### **NOTES**

- WELDING TO BE ACCORDANCE TO AS1554.1 CAT GP WELDING, ALL SHARP EDGES & BURRS REMOVED.
- PART SHOULD BE SUPPLIED CLEAN AND FREE FROM MARKS, BURRS, SCUFFS, DISTORTION AND WARPAGE.
- 3. ENSURE ANTI-SEIZE IS ON ALL NUTS AND BOLTS PRIOR TO ASSEMBLY.
- 4. DRAWING TO AS1100 DRAWING STANDARDS.
- 5. 316 S.S AND 316 S.S FASTENERS TO BE USED THROUGHOUT FOR COASTAL INSTALLATIONS OR ANY ENVIRONMENT WITH HIGH CORROSION.
- ALL TOLERANCES ± 1.5mm UNLESS OTHERWISE SPECIFIED.

#### MATERIAL

- MATERIAL: SEE COMPONENT DRAWING
- 2. COLOUR: SEE COMPONENT DRAWING
- 3. FINISH: SEE COMPONENT DRAWING

STRUCTURAL DESIGN REVIEWED AND					
CERTIFIED FOR ISSUE					
NAME: _B.C. PLANT	RPEQ: <u>8807</u>				
SIGNATURE: ON ORIGINAL	DATE: 10/ 05/ 18				


ISSUE	AMENDMENT	DRAWN DATE	CHK'D DATE	APPR'D Date	PRINCIPAL PLANNING OFFICER URBAN DESIGN	ASSOCIATED PLANS			
Α	Drawing Converted from UMS Series April 2014	APR '14	APR '14	APR '14	VICKI MARTIN SIGNATURE ON ORIGINAL	DRAWING FILENAME	BSD-7331 (C) Drinking fountain -	Bill of materia	ls - Sheet 23 of 27
В	Drawing Title Amended	FEB '16	JUL '16	JUL '16	DESIGN APPROVED		VM	DATE	APR '13
С	Dog Bowl Addition	MAY '18	JUN '18	NOV '18	ASSET ENGINEERING MANAGER STRATEGIC ASSET MANAGEMENT	SUESUED			
						DRAWN	АВ	DATE	JUN '12
					DRAWING AUTHORISED FOR PUBLICATION INGA CONDRIC AUTHORISED 15/04/2014	DESIGN	FORMZOO DESIGN	DATE	JUN '12



# **BRISBANE CITY COUNCIL STANDARD DRAWING**

DRINKING FOUNTAIN BILL OF MATERIALS SHEET 23 OF 27

•		UTITIO
	SCALE NOT T	O SCALE
	DWG No.	
	BSD-7	331
	ORIGINAL SIZE	REVISION
	A3	C

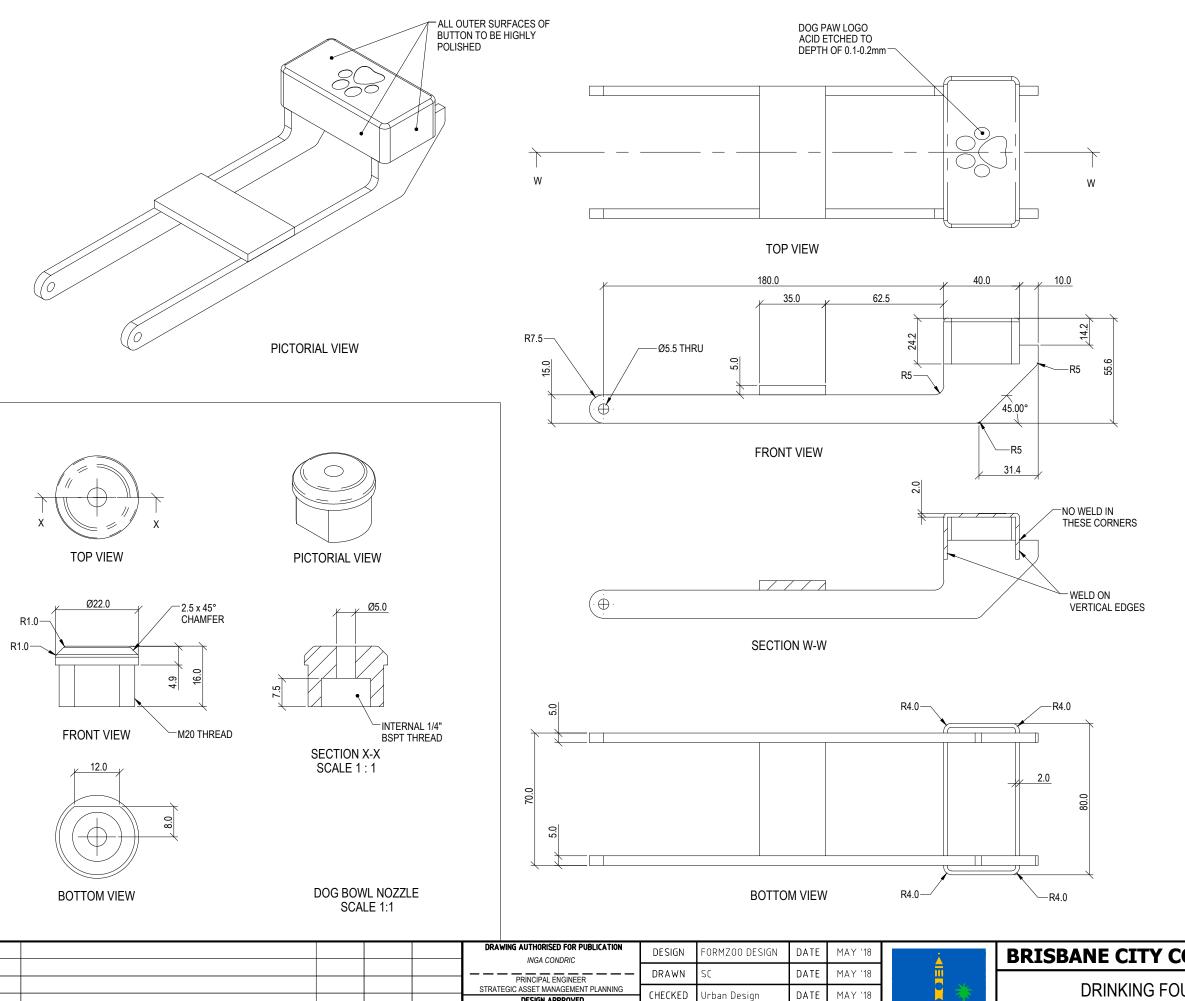

DESIGN APPROVED

VICKI MARTIN

PRINCIPAL PLANNING OFFICER URBAN DESIGN

MAY '18

DRAWN DATE

JUN '18

NOV '18

APPR'D

Original Issue - Dog Bowl Additional

**AMENDMENT** 

ISSUE

DRAWING FILENAME

BSD-7331 (A) Drinking fountain - Dog bowl actuator and nozzle - Sheet 24 of 23

RISBANE CITY

#### **STANDARDS**

DESIGNED IN ACCORDANCE WITH, AND FABRICATION TO MEET THE FOLLOWING STANDARDS:

- AS1428.4.1:2009, TACTILE GROUND SURFACE INDICATORS FOR THE ORIENTATION OF PEOPLE WITH VISION IMPAIRMENT.
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- AUSTRALIAN ROAD RULES, 1999, WWW.NRTC.GOV.AU
- AS4506 -2005, METAL FINISHING-THERMOSET POWDER COATINGS.
- 7. AS4680:2006, HOT DIP GALVANISING.

#### **NOTES**

- WELDING TO BE ACCORDANCE TO AS1554.1 CAT GP WELDING, ALL SHARP EDGES & BURRS REMOVED.
- 2. PART SHOULD BE SUPPLIED CLEAN AND FREE FROM MARKS, BURRS, SCUFFS, DISTORTION AND WARPAGE.
- ENSURE ANTI-SEIZE IS ON ALL NUTS AND BOLTS PRIOR TO ASSEMBLY.
- DRAWING TO AS1100 DRAWING STANDARDS.
- 316 S.S AND 316 S.S FASTENERS TO BE USED THROUGHOUT FOR COASTAL INSTALLATIONS OR ANY ENVIRONMENT WITH HIGH CORROSION.
- ALL TOLERANCES ± 0.5mm UNLESS OTHERWISE

#### **MATERIAL**

- MATERIAL: 316 STAINLESS STEEL
- COLOUR: NATURAL
- 3. FINISHES:


NOZZLE - 600 GRIT POLISHED ACTUATOR - DEBURRED FRAME WITH HIGHLY POLISHED BUTTON AND ETCHED LOGO.






DRINKING FOUNTAIN DOG BOWL ACTUATOR & NOZZLE **SHEET 24 OF 27** 

SCALE	1:2	
DWG No.		
Е	BSD-7331	
ORIGINAL SIZE	REVISION	
Α3	A	

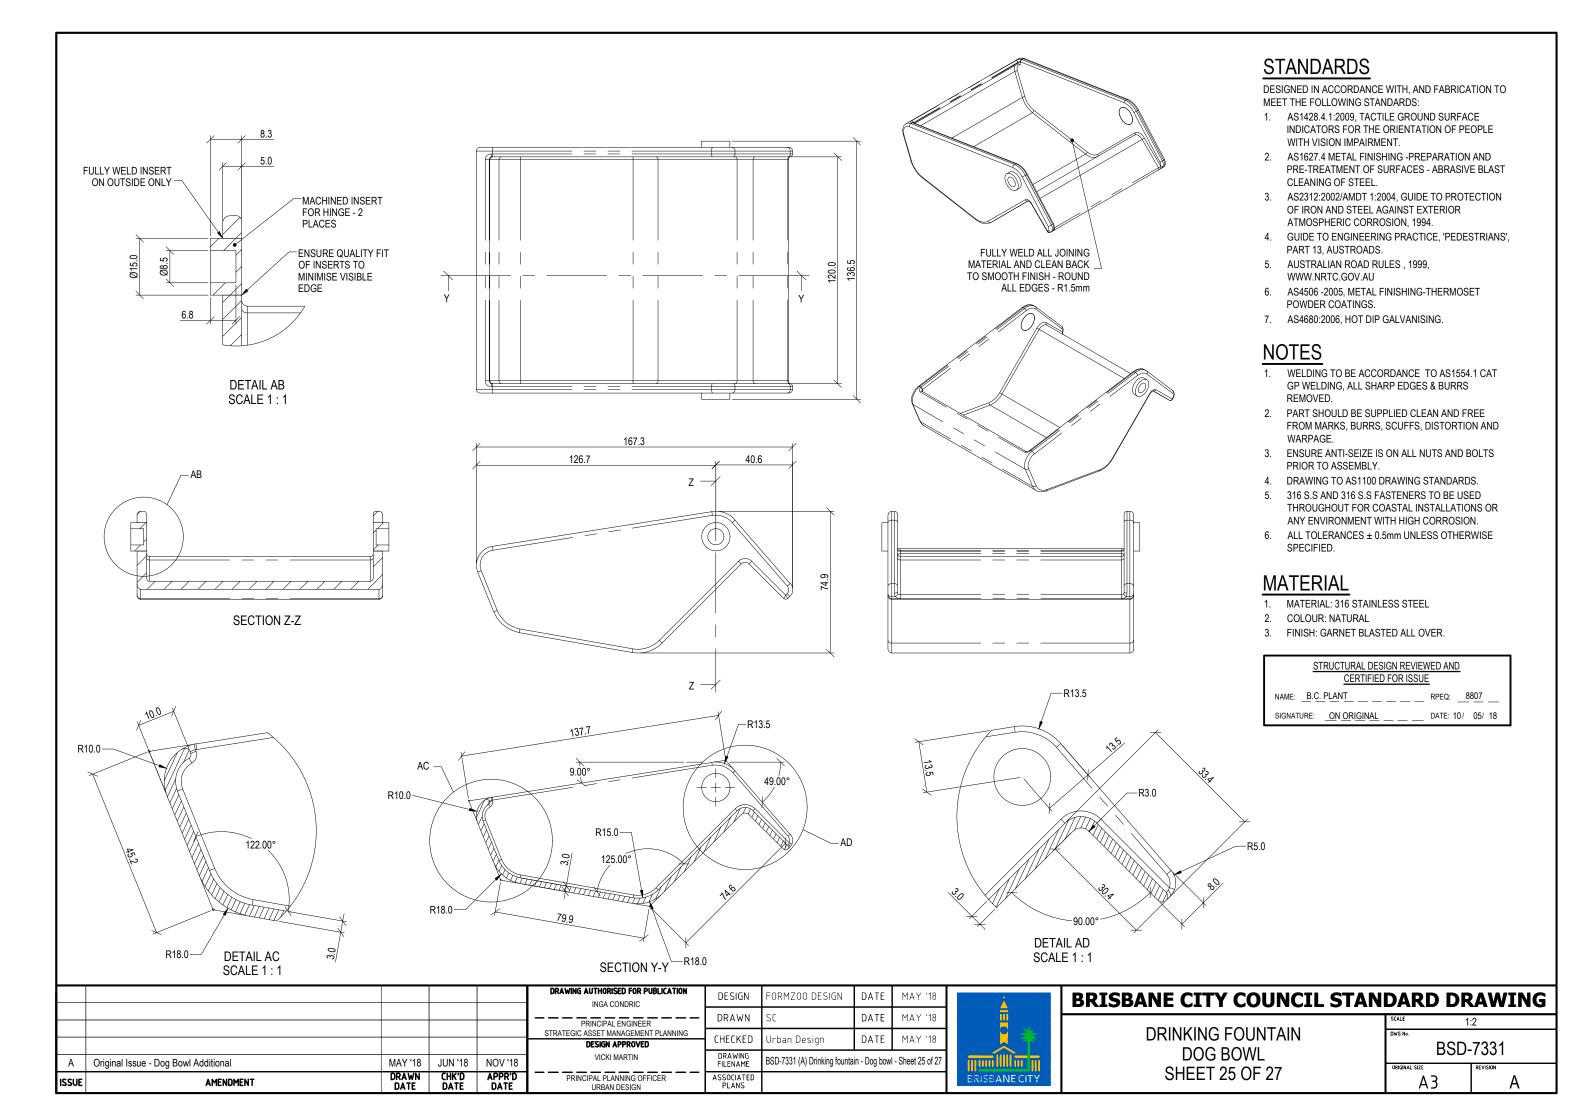

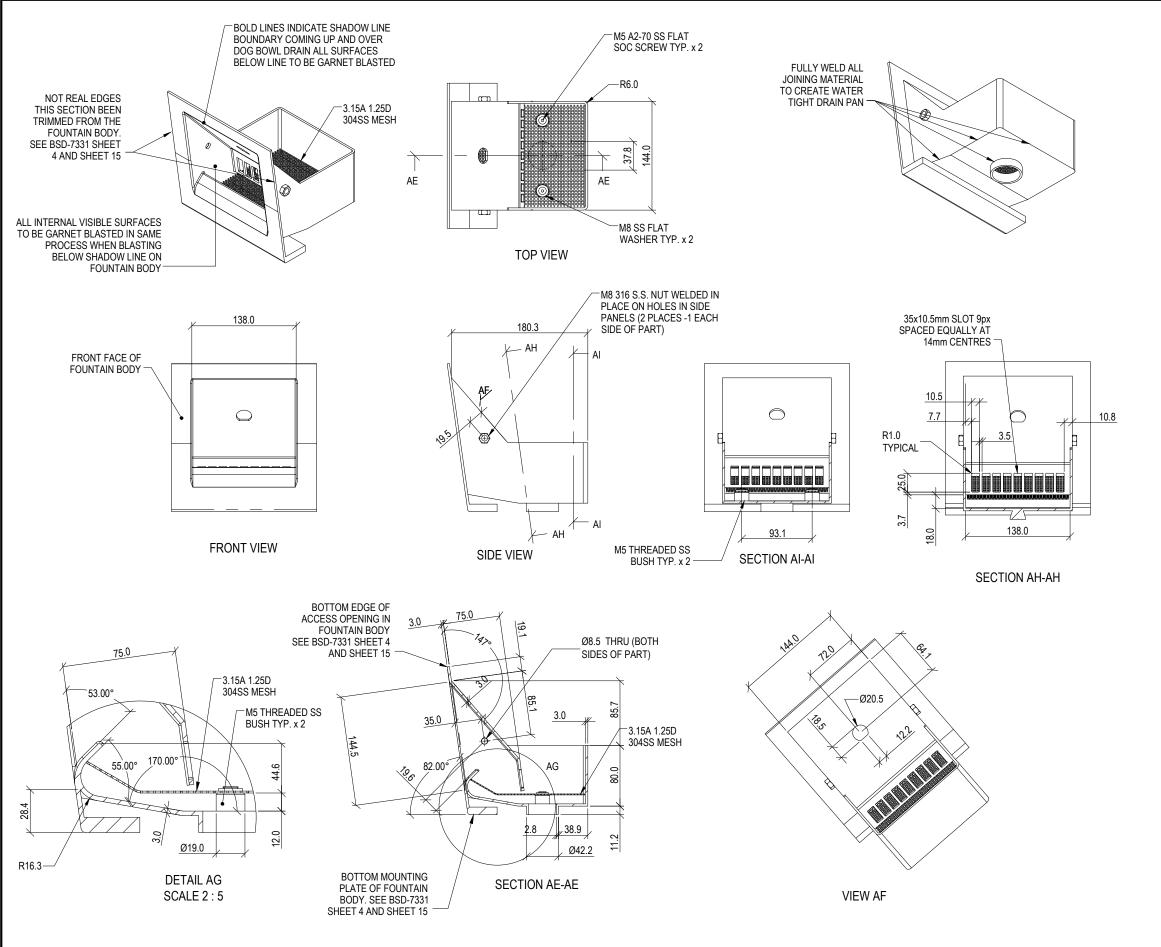

# **STANDARDS**

DESIGNED IN ACCORDANCE WITH, AND FABRICATION TO MEET THE FOLLOWING STANDARDS:

- AS1428.4.1:2009, TACTILE GROUND SURFACE INDICATORS FOR THE ORIENTATION OF PEOPLE WITH VISION IMPAIRMENT.
  - AS1627.4 METAL FINISHING -PREPARATION AND PRE-TREATMENT OF SURFACES - ABRASIVE BLAST CLEANING OF STEEL.
  - AS2312:2002/AMDT 1:2004, GUIDE TO PROTECTION OF IRON AND STEEL AGAINST EXTERIOR ATMOSPHERIC CORROSION, 1994.
- GUIDE TO ENGINEERING PRACTICE, 'PEDESTRIANS', PART 13, AUSTROADS.
- AUSTRALIAN ROAD RULES , 1999, WWW.NRTC.GOV.AU
- AS4506 -2005, METAL FINISHING-THERMOSET POWDER COATINGS.
- 7. AS4680:2006, HOT DIP GALVANISING.

# **NOTES**

- WELDING TO BE ACCORDANCE TO AS1554.1 CAT GP WELDING, ALL SHARP EDGES & BURRS REMOVED.
- PART SHOULD BE SUPPLIED CLEAN AND FREE FROM MARKS, BURRS, SCUFFS, DISTORTION AND WARPAGE.
- 3. ENSURE ANTI-SEIZE IS ON ALL NUTS AND BOLTS PRIOR TO ASSEMBLY.
- 4. DRAWING TO AS1100 DRAWING STANDARDS.
- 5. 316 S.S AND 316 S.S FASTENERS TO BE USED THROUGHOUT FOR COASTAL INSTALLATIONS OR ANY ENVIRONMENT WITH HIGH CORROSION.
- 6. ALL TOLERANCES ± 0.5mm UNLESS OTHERWISE SPECIFIED.

#### **MATERIAL**

- 1. MATERIAL: 316 STAINLESS STEEL
- 2. COLOUR: NATURAL
- 3. FINISH: GARNET BLASTED AS PART OF FOUNTAIN BODY

STRUCTURAL DESIGN REVIEWED AND CERTIFIED FOR ISSUE				
NAME: B.C. PLANT RPEQ:8807				
SIGNATURE: ON ORIGINAL DATE: 10/ 05/ 18				

ISSUE	AMENDMENT	DRAWN DATE	CHK'D DATE	APPR'D DATE	PRINCIPAL PLANNING OFFICER URBAN DESIGN	ASSOCIATED PLANS			
Α	Original Issue - Dog Bowl Addition	MAY '18	JUN '18	NOV '18	VICKI MARTIN	DRAWING FILENAME	BSD-7331 (A) Drinking fountain - Do	g bowl recess_d	Irain - Sheet 26 of 27
					DESIGN APPROVED	CHECKED	Urban Design	DATE	MAY '18
					STRATEGIC ASSET MANAGEMENT PLANNING				
					PRINCIPAL ENGINEER	DRAWN	SC	DATE	MAY '18
					INGA CONDRIC	DESIGN	T OTTI E GO DE STAIN	DATE	11/(1 10
					DRAWING AUTHORISED FOR PUBLICATION	DESIGN	FORMZOO DESIGN	DATE	MAY '18



# **BRISBANE CITY COUNCIL STANDARD DRAWING**


DRINKING FOUNTAIN DOG BOWL RECESS/DRAIN SHEET 26 OF 27

SCALE 1	:2					
DWG No.						
BSD-7331						
ORIGINAL SIZE	REVISION					
A3	Α					




Ø5.0 THRU

TYP. x 6

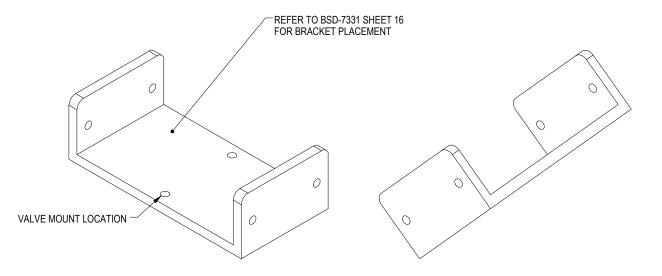


PICTORIAL VIEWS

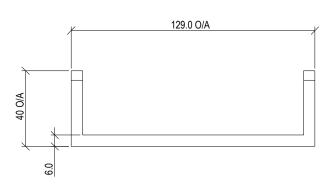

TOP VIEW

6.0



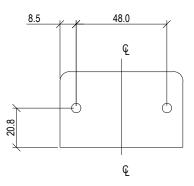

SIDE VIEW

# **STANDARDS**

DESIGNED IN ACCORDANCE WITH, AND FABRICATION TO MEET THE FOLLOWING STANDARDS:

- AS1428.4.1:2009, TACTILE GROUND SURFACE INDICATORS FOR THE ORIENTATION OF PEOPLE WITH VISION IMPAIRMENT.
- 2. AS1627.4 METAL FINISHING -PREPARATION AND PRE-TREATMENT OF SURFACES ABRASIVE BLAST CLEANING OF STEEL.
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- 5. AUSTRALIAN ROAD RULES , 1999, WWW.NRTC.GOV.AU
- 6. AS4506 -2005, METAL FINISHING-THERMOSET POWDER COATINGS.
- 7. AS4680:2006, HOT DIP GALVANISING.

#### **NOTES**

- WELDING TO BE ACCORDANCE TO AS1554.1 CAT GP WELDING, ALL SHARP EDGES & BURRS REMOVED.
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- 4. DRAWING TO AS1100 DRAWING STANDARDS.
- 5. 316 S.S AND 316 S.S FASTENERS TO BE USED THROUGHOUT FOR COASTAL INSTALLATIONS OR ANY ENVIRONMENT WITH HIGH CORROSION.
- 6. ALL TOLERANCES  $\pm$  0.5mm UNLESS OTHERWISE SPECIFIED.

# **MATERIAL**

- 1. MATERIAL: 316 STAINLESS STEEL
- 2. COLOUR: NATURAL
- 3. FINISH: DEBURRED

STRUCTURAL DESIGN REVIEWED AND  CERTIFIED FOR ISSUE						
NAME: <u>B.C. PLANT</u> RPEQ: <u>8807</u>	l					
SIGNATURE: ON ORIGINAL DATE: 10/ 05/ 18	l					

					DRAWING AUTHORISED FOR PUBLICATION
					INGA CONDRIC
					PRINCIPAL ENGINEER STRATEGIC ASSET MANAGEMENT PLANNING
					DESIGN APPROVED
Α	Original Issue - Dog Bowl Addition	MAY '18	JUN '18	NOV '18	VICKI MARTIN
ISSUE	AMENDMENT	DRAWN DATE	CHK'D DATE	APPR'D DATE	PRINCIPAL PLANNING OFFICER URBAN DESIGN

	DESIGN	FORMZOO DESIGN	DATE	MAY '18	
	DRAWN	SC	DATE	MAY '18	
-	CHECKED	Urban Design	DATE	MAY '18	
	DRAWING FILENAME	BSD-7331 (A) Drinking fountain - Do	ount - Sheet 27 of 27		
	ASSOCIATED PLANS				



# **BRISBANE CITY COUNCIL STANDARD DRAWING**

DRINKING FOUNTAIN DOG BOWL VALVEMOUNT SHEET 27 OF 27

DAILD DIGHTING		
	SCALE 1:2	
	DWG No.	
	BSD-7331	
	ORIGINAL SIZE	REVISION
	Α3	Α